

FOUNDATION PLAN NOTES

- 1. REF. S001 & S002 FOR STRUCTURAL NOTES, DESIGN DATA, SCHEDULES &
- 2. REF. THE S400 SERIES FOR TYPICAL FOUNDATION AND MASONRY DETAILS. 3. ALL CONTRACTORS ARE REQUIRED TO COORDINATE THEIR WORK WITH ALL DISCIPLINES TO AVOID CONFLICTS. THE MECHANICAL, ELECTRICAL, AND PLUMBING ASPECTS ARE NOT IN THE SCOPE OF THESE DRAWINGS. THEREFORE, ALL REQUIRED MATERIALS AND WORK MAY NOT BE
- INDICATED. 4. ALL EXISTING CONSTRUCTION SHOWN IN PLAN AND/OR SECTION WAS DERIVED FROM EXISTING DRAWINGS AND MUST BE FIELD VERIFIED. IF ANY DISCREPANCIES ARE DISCOVERED BETWEEN INFORMATION SHOWN ON THE DRAWINGS AND ACTUAL CONDITIONS, IMMEDIATELY CONTACT THE ARCHITECT/ENGINEER FOR DIRECTION BEFORE PROCEEDING WITH
- 5. ALL ELEVATIONS ARE REFERENCED FROM THE EXISTING FIRST FLOOR FIN. FLOOR ELEVATION +0'-0". VERIFY USGS ELEVATION WITH CIVIL DRAWINGS.
- 6. <u>ALL WALLS SHALL BE LAID OUT FROM THE ARCHITECTURAL DRAWINGS.</u> 7. REF. ARCH. DRAWINGS. FOR ALL DIMENSIONS NOT SHOWN. CONTRACTOR SHALL VERIFY ALL DIMENSIONS PRIOR TO CONSTRUCTION AND IMMEDIATELY NOTIFY ARCHITECT/ENGINEER OF ANY DISCREPANCIES. 8. COORDINATE EXACT SIZE & LOCATION OF ALL MECHANICAL OPENINGS IN FDN. WALLS WITH THE MECHANICAL, ELECTRICAL & PLUMBING
- CONTRACTORS. 9. <u>NOTE</u>: PERIMETER FOOTINGS SHALL BE LOWERED AND/OR SLEEVED TO PASS BELOW PLUMBING LINES (E.G., SANITARY & STORM LINES, WATER LINES, ETC.) SHOWN ON THE PLUMBING DRAWINGS. PROVIDE FOOTING
- STEPS AS REQUIRED PER THE TYPICAL DETAILS ON \$401. 10. ALL SLAB RECESSES SHALL BE LOCATED PER THE ARCHITECTURAL DRAWINGS. COORDINATE DEPTHS OF ALL SLAB RECESSES WITH THE ARCHITECTURAL DRAWINGS AND/OR THE FLOORING SUPPLIER.
- 11. PROVIDE CMU REINFORCING AS NOTED ON PLANS & SECTIONS. IF NOT SHOWN ELSEWHERE, MINIMUM CMU WALL REINFORCING TO BE #5 VERTS @ 48" OC. PROVIDE OPEN-CORE BOND BEAMS AT TOPS OF WALLS, AT CHANGES IN CMU THICKNESS, AND WHERE INDICATED ON PLANS & SECTIONS (10'-0" OC MAX VERTICAL SPACING). PROVIDE 1/2 OF INTERRUPTED VERTICALS AT JAMBS OF OPENINGS AND PROVIDE ADDITIONAL VERT'S. AT ENDS OF WALLS.
- 12. COORDINATE REINFORCING DOWELS FOR CMU VERTICAL REINFORCING WITH REINF. NOTED ON PLANS & SECTIONS. 13. GROUT ALL CORES OF CMU SOLID BELOW FIN. FLOOR ELEVATION.
- 14. PROVIDE THICKENED SLAB UNDER ALL INTERIOR CMU WALLS WITHOUT FOOTINGS. SEE S401 FOR THICKENED SLAB DETAIL. REF. THE ARCHITECTURAL DRAWINGS FOR LOCATIONS OF CMU WALLS.
- 15. ALL FOOTINGS SHALL BEAR ON APPROVED SOIL. UNDERCUT AS REQ'D. TO SUITABLE BEARING MATERIAL AS DETERMINED BY THE GEOTECHNICAL TESTING AGENCY. REF. TYPICAL FOOTING UNDERCUT DETAILS ON S402.
- 16. PROVIDE CONTROL/CONTRACTION JOINTS IN SLABS ON GRADE (REF. TYPICAL DETAILS ON S401). ALL JOINTS IN SLABS TO RECEIVE THIN OR THICK-SET TERRAZZO, CERAMIC OR PORCELAIN TILE, VINYL-COMPOSITION TILE (VCT) OR VINYL SHEET GOODS, EPOXY OR SIMILAR THIN-FILM FINISH FLOORING SHALL BE CAREFULLY COORDINATED WITH THE FLOORING CONTRACTOR. THE CONTRACTOR SHALL SUBMIT SLAB JOINT LAYOUT TO ARCHITECT/ENGINEER FOR REVIEW PRIOR TO PLACING SLABS.
- 17. EARTH-FORMED FOOTINGS ARE ACCEPTABLE WHERE SOIL CONDITIONS PERMIT (I.E. WHERE THE BANKS OF THE EXCAVATION WILL HOLD WITHOUT CAVING AND SLOUGHING). HOWEVER, THE PLAN DIMENSION OF EARTH- FORMED FOOTINGS MUST BE INCREASED BY 2" ALONG ALL EDGES TO ACCOUNT FOR INACCURACIES ASSOCIATED WITH EARTH-FORMING (I.E. 2'-0" WIDE WALL FOOTINGS SHALL BE 2'-4" WIDE AND 5'-0" SQUARE COLUMN FOOTINGS SHALL BE 5'-4" SQUARE).
- 18. UNLESS NOTED OTHERWISE, ALL NEW FOOTINGS ABUTTING EX. FOUNDATIONS (REF. 'SP' FTG LABEL ON PLAN) SHALL BE SIZED PER THE FOOTING SCHEDULES SUCH THAT HALF THE FOOTING SIZE SHALL BE TAKEN FROM THE CENTER OF THE COLUMN/WALL IN ALL DIRECTIONS NOT LIMITED BY THE ADJACENT EX. FDNS. BOTTOM OF 'SP' FTG TO MATCH EX. ADJACENT B/FTG ELEVATION. REF. SPECIFIC SECTIONS, TYP DETAILS & FOOTING SCHEDULES FOR DOWELING & REINF. INFORMATION.
- 19. REF. ARCHITECTURAL DWGS. FOR MASONRY CONTROL & EXPANSION JOINT LOCATIONS. 20. PLAN LEGEND:

DENOTES FIN. FLOOR DENOTES TOP OF FTG, SLAB, PIER, ETC. DENOTES BOTTOM OF FTG, GRADE BEAM, ETC. DENOTES SLAB ON GRADE CONTROL/CONTRACTION JOINT DENOTES WALL FOOTING MARK & TOP OF FOOTING ELEVATION (REF. WALL FTG SCHED.) WF24 -2'-8" DENOTES TIE BEAM MARK & T/BEAM ELEVATION (REF. TIE BEAM SCHEDULE)

- - - - -DENOTES WALL FOOTING WITH STEPS. REF. TYP. DETAIL ON S401 - \bot - \bot -DENOTES CMU FOUNDATION WALL

DENOTES CMU FDN. WALL HELD DOWN AT OPENINGS DENOTES CMU WALL VERT. REINF. SIZE & SPACING. IF NOT SHOWN, PROVIDE MIN. PER NOTE 11 ABOVE.

4" CONC. SOG T/SLAB +0'-0"

DENOTES SLAB ON GRADE THICKNESS & T/SLAB ELEVATION. ALL SLABS ON GRADE TO BE PLACED ON 6" MIN. COMPACTED GRANULAR FILL & VAPOR BARRIER/RETARDER PER SPECS. PROVIDE THE 4" SLAB: 6x6-W1.4xW1.4 WWF

FOLLOWING WELDED WIRE FABRIC REINFORCING: 5" SLAB: 6x6-W2.1xW2.1 WWF 6" SLAB: 6x6-W2.9xW2.9 WWF - DENOTES COLUMN FOOTING

MARK & TOP OF FTG. ELEVATION

(SEE COL. FTG. SCHED. ON S002) DENOTES PIER MARK & TOP OF PIER ELEVATION (SEE PIER SCHED. ON S002) FOOTING DENOTES COLUMN SIZE (REF. FRAMING PLANS FOR STUB COLS. NOT SHOWN ON FDN. PLAN) CONCRETE PIER — └── STEEL COLUMN



SCOPE DRAWINGS:

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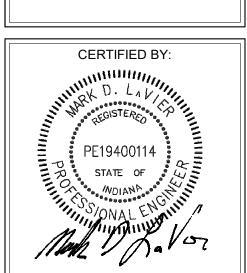
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REVISIONS: ADDENDUM 01 2025-01-29


ISSUE DATE DRAWN BY CHECKED BY

01/15/2025 JRV

DRAWING TITLE: FOUNDATION PLAN - UNIT B



DRAWING NUMBER S200B

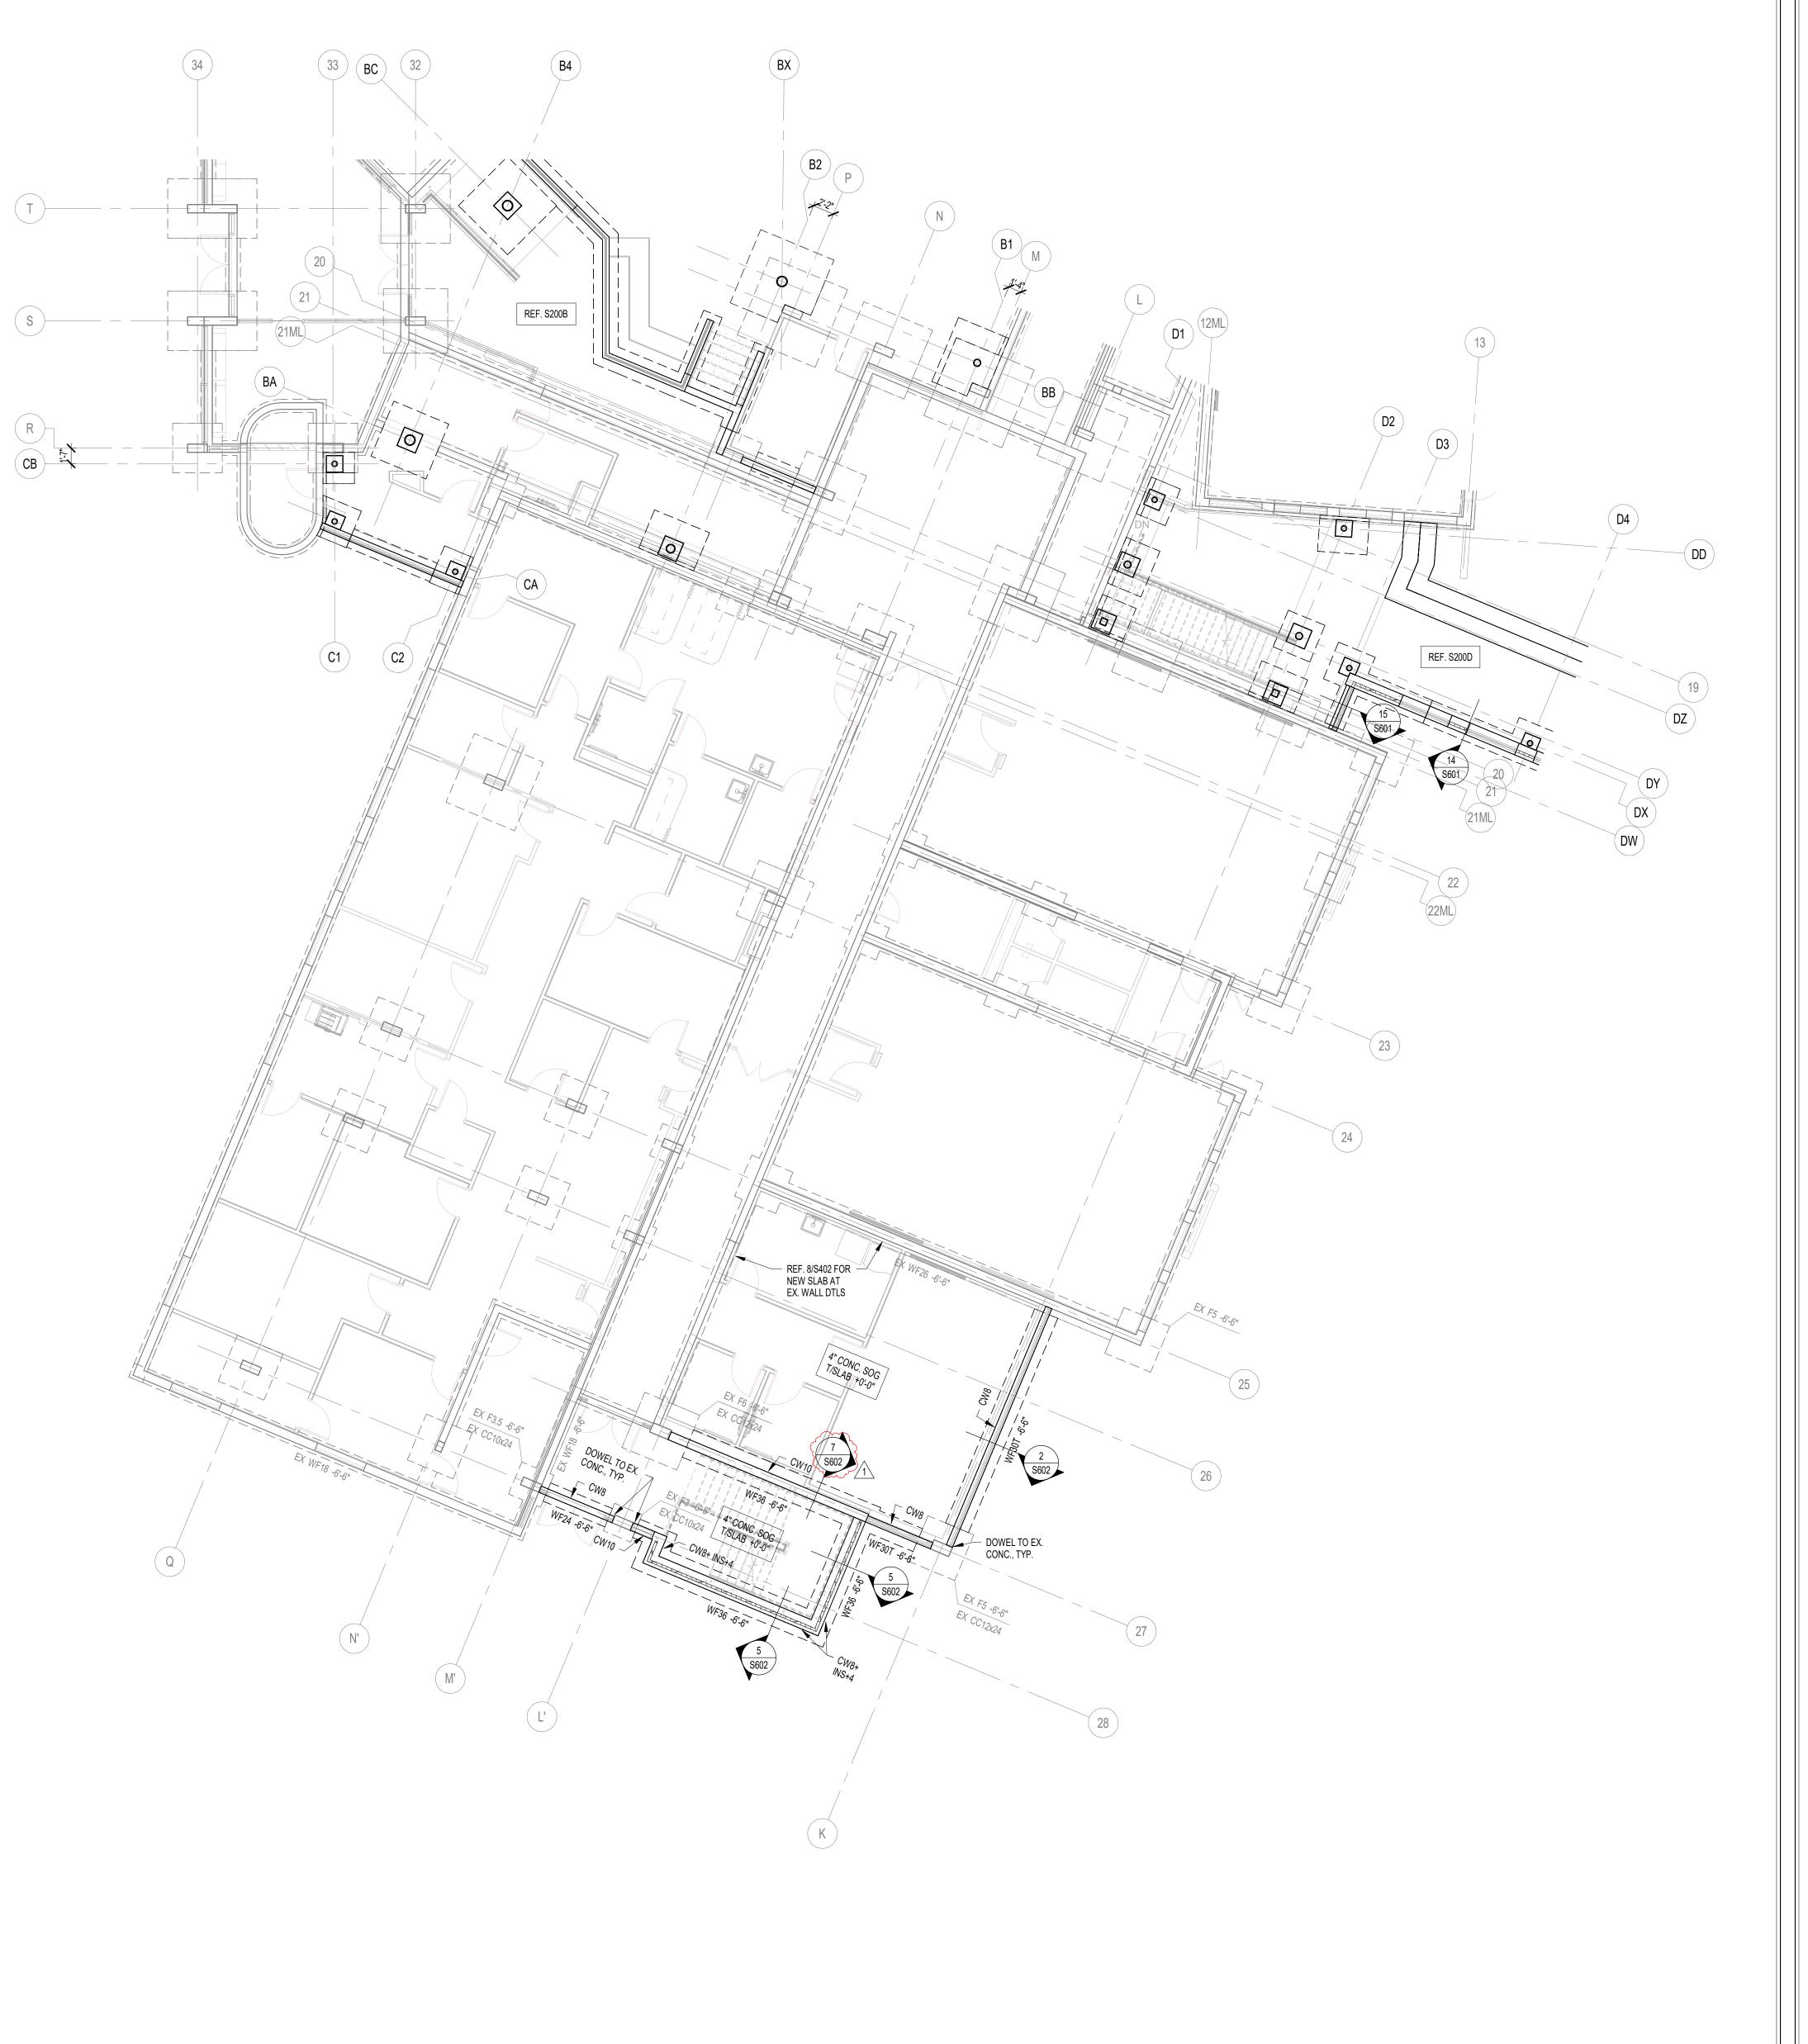

FOUNDATION PLAN NOTES

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- SHOWN ELSEWHERE, MINIMUM CMU WALL REINFORCING TO BE #5 VERTS @ 48" OC. PROVIDE OPEN-CORE BOND BEAMS AT TOPS OF WALLS, AT CHANGES IN CMU THICKNESS, AND WHERE INDICATED ON PLANS & SECTIONS (10'-0" OC MAX VERTICAL SPACING). PROVIDE 1/2 OF INTERRUPTED VERTICALS AT JAMBS OF OPENINGS AND PROVIDE ADDITIONAL VERT'S. AT ENDS OF WALLS.

 12. COORDINATE REINFORCING DOWELS FOR CMU VERTICAL REINFORCING WITH REINF. NOTED ON PLANS & SECTIONS.

11. PROVIDE CMU REINFORCING AS NOTED ON PLANS & SECTIONS. IF NOT

- GROUT ALL CORES OF CMU SOLID BELOW FIN. FLOOR ELEVATION.
 PROVIDE THICKENED SLAB UNDER ALL INTERIOR CMU WALLS WITHOUT FOOTINGS. SEE S401 FOR THICKENED SLAB DETAIL. REF. THE
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 REF. ARCHITECTURAL DWGS. FOR MASONRY CONTROL & EXPANSION
- JOINT LOCATIONS.

 20. PLAN LEGEND:

FF
T/X'
DENOTES FIN. FLOOR
T/X'
DENOTES TOP OF FTG, SLAB, PIER, ETC.

B/X'
DENOTES BOTTOM OF FTG, GRADE BEAM, ETC.
CJ
DENOTES SLAB ON GRADE
CONTROL/CONTRACTION JOINT
WF24 -2'-8"
DENOTES WALL FOOTING MARK & TOP OF
FOOTING ELEVATION (REF. WALL FTG SCHED.)
TB24x24 -1'-4"
DENOTES TIE BEAM MARK & T/BEAM
ELEVATION (REF. TIE BEAM SCHEDULE)

DENOTES WALL FOOTING WITH STEPS.

DENOTES CMU FDN. WALL HELD DOWN AT OPENINGS

#5@32"OC

DENOTES CMU WALL VERT. REINF. SIZE & SPACING. IF NOT SHOWN, PROVIDE MIN. PER NOTE 11 ABOVE.

4" CONC. SOG
T/SLAB +0'-0"


DENOTES SLAB ON GRADE THICKNESS & T/SLAB
ELEVATION. ALL SLABS ON GRADE TO BE PLACED ON
6" MIN. COMPACTED GRANULAR FILL & VAPOR
BARRIER/RETARDER PER SPECS. PROVIDE THE
FOLLOWING WELDED WIRE FABRIC REINFORCING:
4" SLAB: 6x6-W1 4xW1 4 WWF

BARRIEN/RETARDER PER SPECS. PROVIDE THE FOLLOWING WELDED WIRE FABRIC REINFORCING

4" SLAB: 6x6-W1.4xW1.4 WWF

5" SLAB: 6x6-W2.1xW2.1 WWF

6" SLAB: 6x6-W2.9xW2.9 WWF

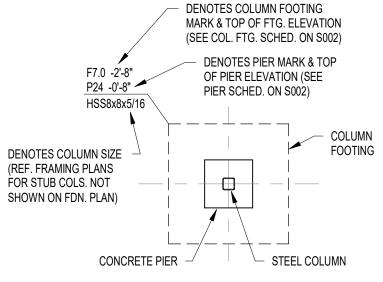

KEY PLAN



BCSC TOGETHER WE LEARN

831 Keystone Crossing, Indianapolis, IN 46240

Brumleve, Brumleve, Inc. P 317.423.1550 F 317.423.1551

550 Virginia Avenue Indianapolis, IN 46203

SCHOOL CORPORATION
RENOVATIONS AND ADDITIONS
-- FRANCES SMITH ELEMENT
4505 WAYCROSS DRIVE, COLUMBUS, IN 4

SCOPE DRAWINGS:

These drawings indicate the general scope of the project in terms of architectural design concept, the dimensions of the building, the major architectural elements and the type of structural, mechanical and electrical systems.

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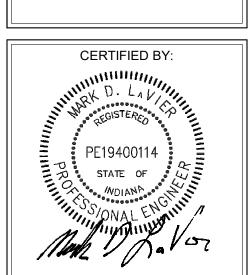
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REVISIONS:

ADDENDUM 01 2025-01-29

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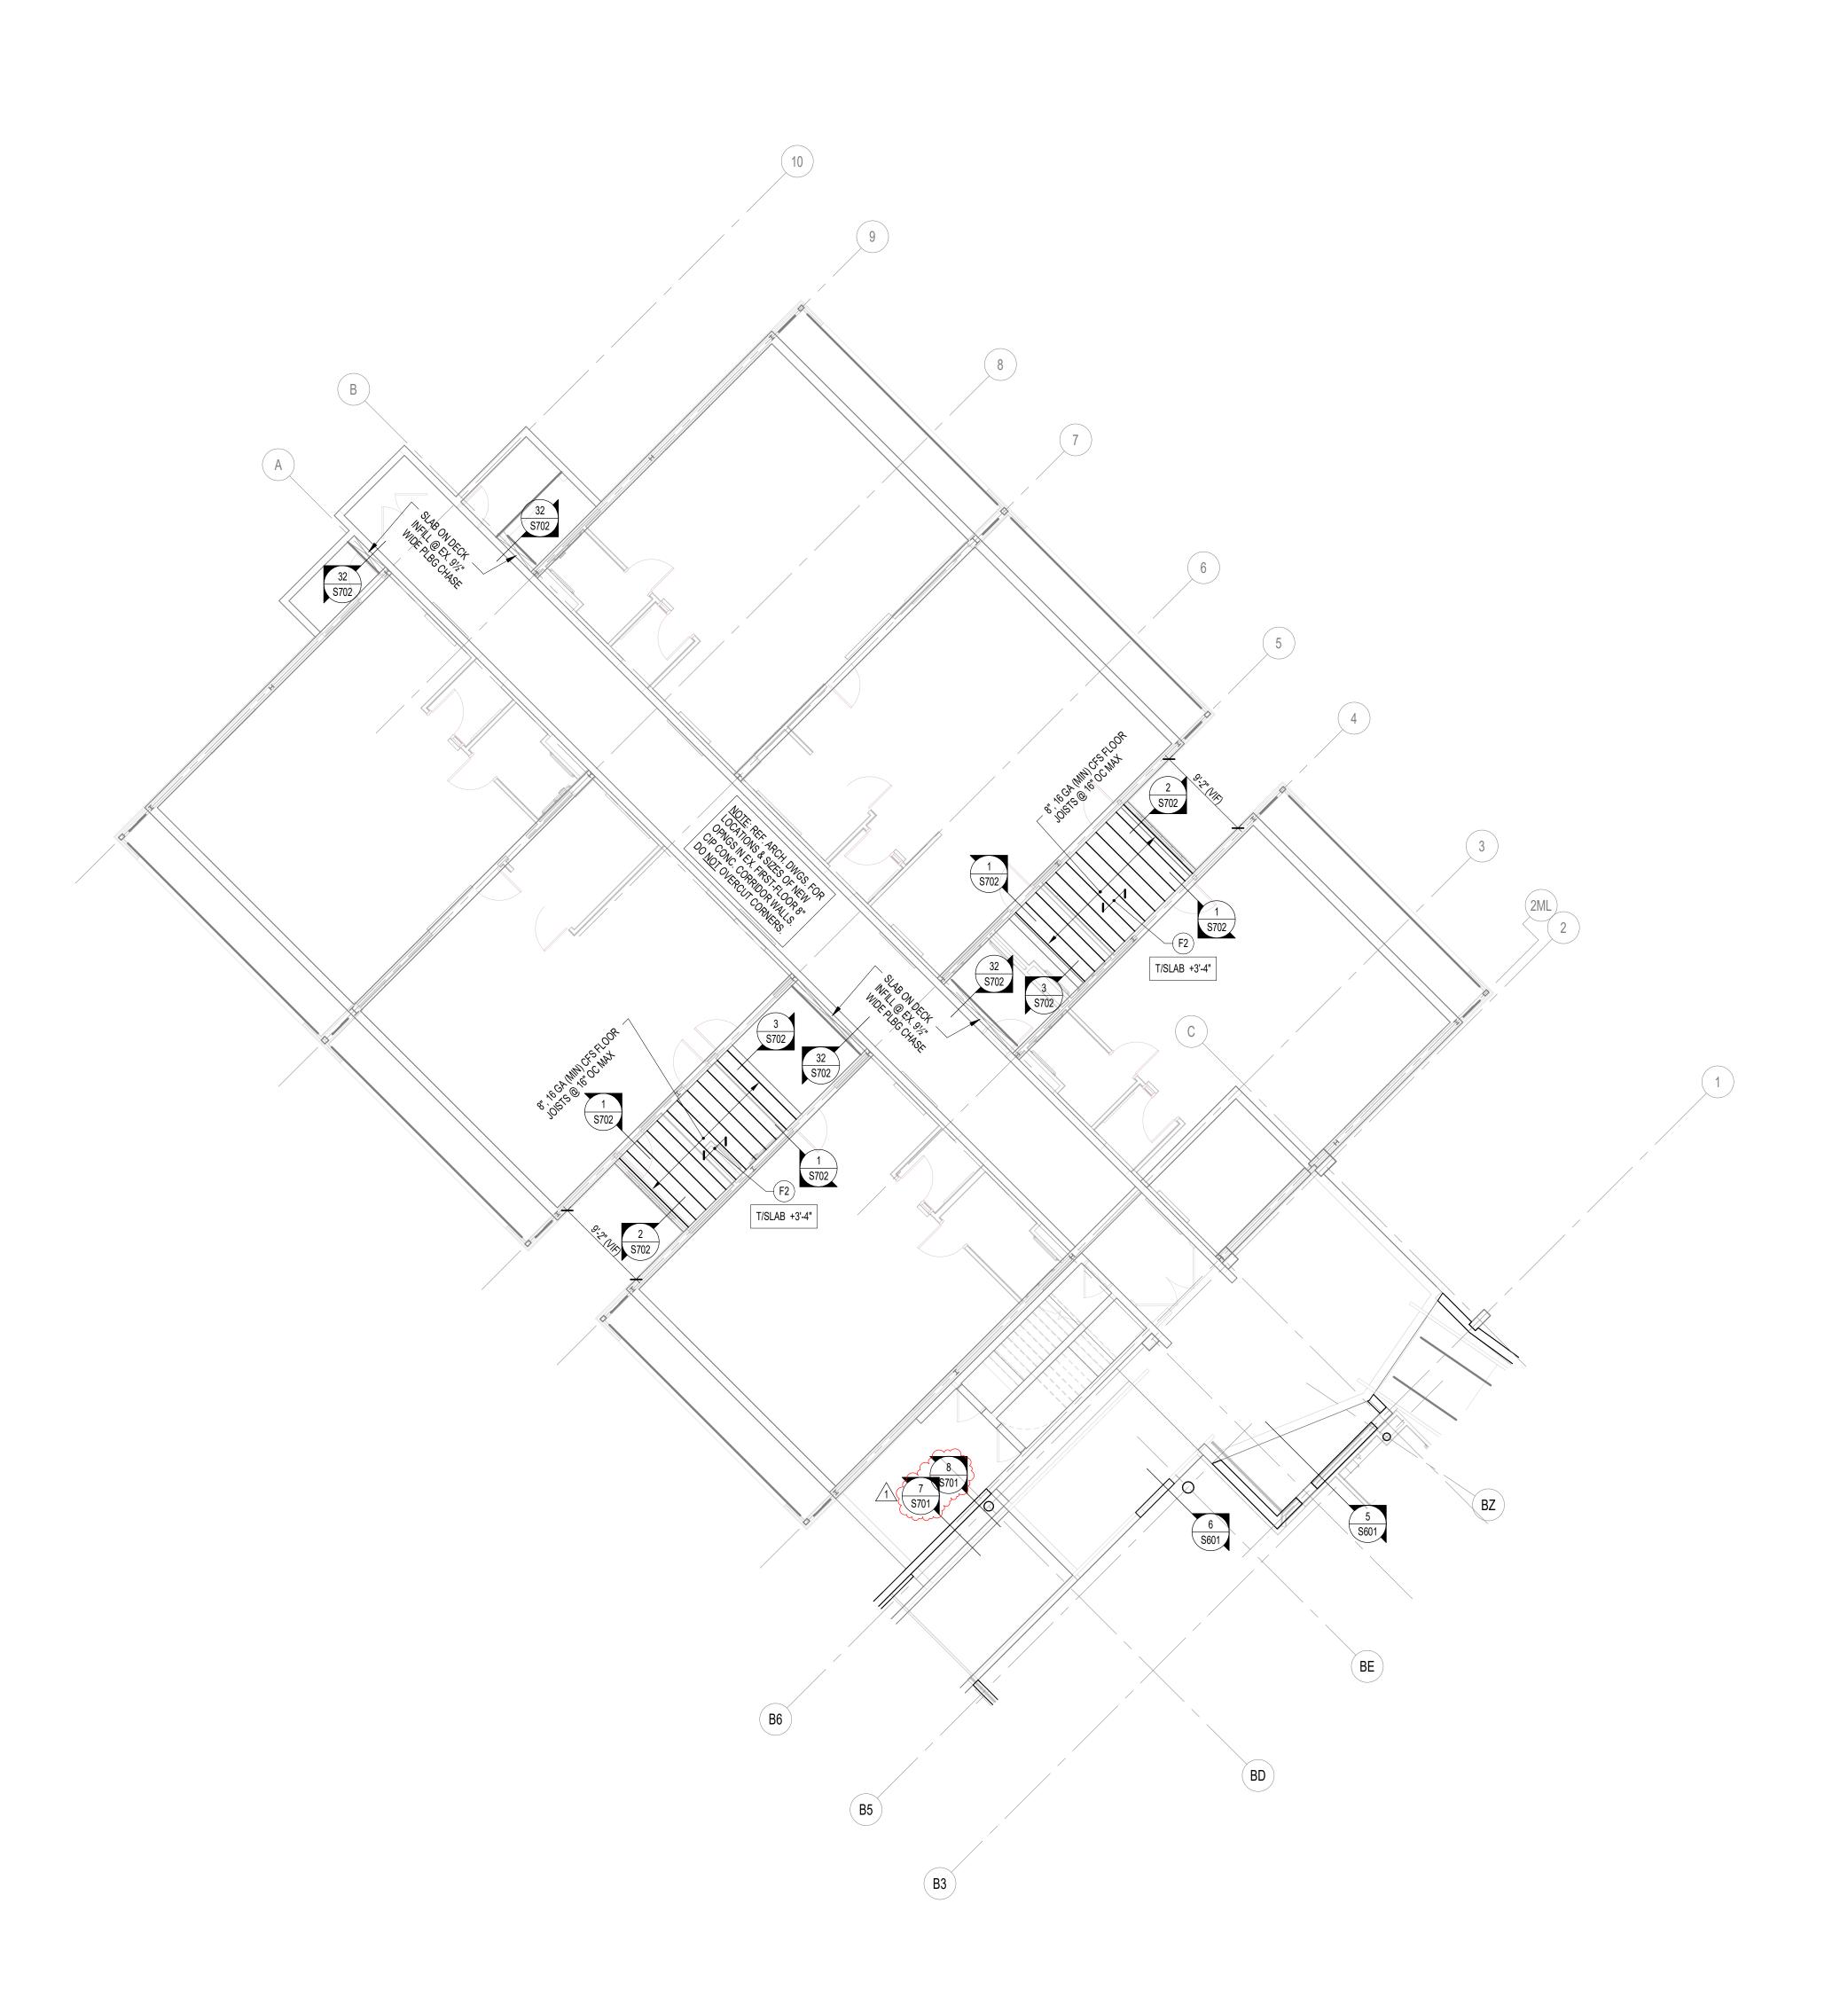
FOUNDATION
PLAN - UNIT C



S200C

PROJECT NUMBER 2024023

1 FOUNDATION PLAN - UNIT C
S200C SCALE: 1/8" = 1'-0"



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- DISCIPLINES TO AVOID CONFLICTS. THE MECHANICAL, ELECTRICAL, AND PLUMBING ASPECTS ARE NOT IN THE SCOPE OF THESE DRAWINGS. THEREFORE, ALL REQUIRED MATERIALS AND WORK MAY NOT BE INDICATED. 4. ALL EXISTING CONSTRUCTION SHOWN IN PLAN AND/OR SECTION WAS DERIVED FROM EXISTING DRAWINGS AND MUST BE FIELD VERIFIED. IF

ANY DISCREPANCIES ARE DISCOVERED BETWEEN INFORMATION SHOWN

- ON THE DRAWINGS AND ACTUAL CONDITIONS, IMMEDIATELY CONTACT THE ARCHITECT/ENGINEER FOR DIRECTION BEFORE PROCEEDING WITH 5. ALL ELEVATIONS ARE REFERENCED FROM THE EXISTING FIRST FLOOR FIN.
- FLOOR ELEVATION +0'-0". VERIFY USGS ELEVATION WITH CIVIL DWGS. 6. <u>ALL</u> WALLS SHALL BE LAID OUT FROM THE ARCHITECTURAL DRAWINGS. 7. REF. ARCH. DRAWINGS. FOR ALL DIMENSIONS NOT SHOWN. CONTRACTOR
- SHALL VERIFY ALL DIMENSIONS PRIOR TO CONSTRUCTION AND IMMEDIATELY NOTIFY ARCHITECT/ENGINEER OF ANY DISCREPANCIES. 8. COORDINATE EXACT SIZE & LOCATION OF ANY MECHANICAL OPENINGS IN FLOOR SLAB, ROOF DECK, OR WALLS WITH THE MEP CONTRACTOR(S). LOCATION & SIZE OF ALL DUCT OPENINGS, GRILLES, ETC. SHALL BE
- VERIFIED PRIOR TO CONSTRUCTION. 9. ALL ELEVATIONS SHOWN ON PLAN INDICATE TOP OF STEEL BEAM UNLESS
- NOTED OTHERWISE. 10. PROVIDE CHANNEL FRAMES AT ALL SUPPORTED SLAB OPENINGS PER TYPICAL DETAIL ON S404. COORDINATE EXACT NUMBER, LOCATIONS & DIMENSIONS
- WITH THE APPROPRIATE CONTRACTORS & THE ARCH. & MEP DRAWINGS. 11. PROVIDE FRAMES AT ALL ROOF DRAINS, ROOF HATCHES & OTHER ROOF OPENINGS PER TYPICAL DETAILS ON S404. COORD. EXACT NUMBER, LOCATIONS & DIMENSIONS WITH THE APPROPRIATE CONTRACTORS & THE ARCH. & MEP DWGS.
- 12. PROVIDE CMU REINFORCING AS NOTED ON PLANS. IF NOT SHOWN ON PLANS, MINIMUM CMU WALL REINFORCING TO BE #5 VERTS @ 48" O.C. PROVIDE OPEN-CORE BOND BEAMS AT TOPS OF WALLS, AT CHANGES IN CMU THICKNESS, AND WHERE INDICATED ON PLANS & SECTIONS (10'-0" O.C. MAX VERTICAL SPACING). PROVIDE 1/2 OF INTERRUPTED VERTICALS AT JAMBS OF
- OPENINGS AND PROVIDE ADDITIONAL VERT'S. AT ENDS OF WALLS. 13. ALL MASONRY BOND BEAMS, OTHER THAN BOND BEAM LINTELS OVER OPENINGS, SHALL BE "OPEN-CORE" BOND BEAMS TO ALLOW VERTICAL REINFORCING TO PASS THROUGH, UNLESS NOTED OTHERWISE.
- 14. REF. ARCH. DWGS. FOR MASONRY CONTROL & EXPANSION JOINT LOCATIONS. 15. FOR ESTIMATING AND BIDDING PURPOSES ONLY, ASSUME AN ADDITIONAL 1/2" THICKNESS OF CONCRETE WILL BE NECESSARY FOR ALL ELEVATED SLABS ON METAL DECK. THE INTENT OF THIS REQUIREMENT IS TO
- ACCOUNT FOR ANTICIPATED DEAD LOAD DEFLECTIONS IN THE SUPPORTING STRUCTURE. THE FINISHED SLAB SHALL MEET THE FLATNESS REQUIREMENTS DEFINED IN THE SPECIFICATION. 16. PLAN LEGEND: DENOTES FIN. FLOOR
 - DENOTES TOP OF STEEL, SLAB, ETC. DENOTES BOTTOM OF LINTEL, ETC. DENOTES SLAB EDGE DIMENSION MEASURED FROM BEAM OR COLUMN CENTERLINE DENOTES DECK EDGE ANGLE DIMENSION MEASURED FROM BEAM OR COLUMN CENTERLINE DENOTES BEAM BEARING PLATE ON CMU WALL DENOTES 2", 20 GA. GALVANIZED COMPOSITE
 - WWF, TOTAL 't' = $5\frac{1}{2}$ ". REF. DETAIL 1/S404. DENOTES 11/2", 20 GA. GALVANIZED COMPOSITE DECK w/ 21/2" NW CONC SLAB w/ 6x6-W1.4xW1.4 WWF, TOTAL 't' = 4". REF. DETAIL 2/S404.

DECK w/ 31/2" NW CONC SLAB w/ 6x6-W2.1xW2.1

DENOTES 3", 18 GA. GALVANIZED COMPOSITE

- DECK w/ 21/2" NW CONC SLAB w/ 6x6-W1.4xW1.4 WWF, TOTAL 't' = 51/2". REF. DETAIL 9/S405.
- DENOTES 1½", 20 GA. GALVANIZED & PRIME-PAINTED WIDE RIB STEEL ROOF DECK. REF. DETAIL 3/S404. DENOTES 3", 18 GA. GALVANIZED & PRIME-PAINTED DEEP RIB STEEL ROOF DECK. REF. DETAIL 8/S405.
- DENOTES 3", 20/20 GA. GALVANIZED & PRIME-PAINTED DEEP RIB CELLULAR ACOUSTIC STEEL ROOF DECK w/INSULATION, NRC=0.95. REF. DETAIL 4/S404.
- DENOTES BEAM-TO-COLUMN MOMENT CONNECTION. REF. DETAILS ON S405. DENOTES BEAM-THRU-BEAM MOMENT
- CONNECTION. REF. DETAILS ON \$404. DENOTES BRACED FRAME OR KICKER LOCATION
 - DENOTES APPROX. LOCATION OF OPENING IN DECK/SLAB. REF. DETAILS ON S404 FOR TYPICAL

KIPS (SEE NOTES ABOVE)

17. WIDE-FLANGE BEAM & GIRDER NOTATION: BEAM REACTIONS SHOWN IN KIPS TO BE USED FOR DESIGN OF SHEAR CONNECTION BY STEEL FABRICATOR'S SSE (ALLOWABLE STRESS DESIGN / LOADS UNFACTORED). REF. THE STEEL CONNECTION NOTES ON S001 FOR DESIGN OF CONNECTIONS AT BEAMS & GIRDERS WITH NO REACTION SHOWN. THE MIN. SHEAR CONNECTION DESIGN LOAD SHALL BE 15 KIPS.

NO. OF 3/4" DIA. x 43/8" LONG SHEAR CONNECTOR STUDS OFFSET NON-COMPOSITE SPACED UNIFORMLY ALONG (DEAD LOAD) DEFLECTION FULL LENGTH OF BEAM W16x31 (16) $c = \frac{3}{4}$ " STEEL BEAM SIZE — DENOTES BEAM REACTION IN

KEY PLAN

TYPICAL COMPOSITE BEAM DIAGRAM



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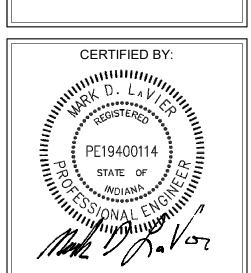
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01/15/2025 DV/JRV MDL

DRAWING TITLE: FIRST FLOOR FRAMING PLAN -



DRAWING NUMBER S201A

PROJECT NUMBER 2024023

FIRST FLOOR FRAMING PLAN - UNIT A S201A SCALE: 1/8" = 1'-0"



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- 15. ALL FOOTINGS SHALL BEAR ON APPROVED SOIL. UNDERCUT AS REQ'D. TO SUITABLE BEARING MATERIAL AS DETERMINED BY THE GEOTECHNICAL TESTING AGENCY. REF. TYPICAL FOOTING UNDERCUT DETAILS ON S402.
- 16. PROVIDE CONTROL/CONTRACTION JOINTS IN SLABS ON GRADE (REF. TYPICAL DETAILS ON S401). ALL JOINTS IN SLABS TO RECEIVE THIN OR THICK-SET TERRAZZO, CERAMIC OR PORCELAIN TILE, VINYL-COMPOSITION TILE (VCT) OR VINYL SHEET GOODS, EPOXY OR SIMILAR THIN-FILM FINISH FLOORING SHALL BE CAREFULLY COORDINATED WITH THE FLOORING CONTRACTOR. THE CONTRACTOR SHALL SUBMIT SLAB JOINT LAYOUT TO ARCHITECT/ENGINEER FOR REVIEW PRIOR TO PLACING SLABS.
- 17. EARTH-FORMED FOOTINGS ARE ACCEPTABLE WHERE SOIL CONDITIONS PERMIT (I.E. WHERE THE BANKS OF THE EXCAVATION WILL HOLD WITHOUT CAVING AND SLOUGHING). HOWEVER, THE PLAN DIMENSION OF EARTH- FORMED FOOTINGS MUST BE INCREASED BY 2" ALONG ALL EDGES TO ACCOUNT FOR INACCURACIES ASSOCIATED WITH EARTH-FORMING (I.E. 2'-0" WIDE WALL FOOTINGS SHALL BE 2'-4" WIDE AND 5'-0" SQUARE COLUMN FOOTINGS SHALL BE 5'-4" SQUARE).
- 18. UNLESS NOTED OTHERWISE, ALL NEW FOOTINGS ABUTTING EX. FOUNDATIONS (REF. 'SP' FTG LABEL ON PLAN) SHALL BE SIZED PER THE FOOTING SCHEDULES SUCH THAT HALF THE FOOTING SIZE SHALL BE TAKEN FROM THE CENTER OF THE COLUMN/WALL IN ALL DIRECTIONS NOT LIMITED BY THE ADJACENT EX. FDNS. BOTTOM OF 'SP' FTG TO MATCH EX. ADJACENT B/FTG ELEVATION. REF. SPECIFIC SECTIONS, TYP DETAILS & FOOTING SCHEDULES FOR DOWELING & REINF. INFORMATION.
- 19. REF. ARCHITECTURAL DWGS. FOR MASONRY CONTROL & EXPANSION JOINT LOCATIONS. 20. PLAN LEGEND:

DENOTES FIN. FLOOR DENOTES TOP OF FTG, SLAB, PIER, ETC. - - - - -

DENOTES BOTTOM OF FTG, GRADE BEAM, ETC. DENOTES SLAB ON GRADE CONTROL/CONTRACTION JOINT DENOTES WALL FOOTING MARK & TOP OF FOOTING ELEVATION (REF. WALL FTG SCHED.) DENOTES TIE BEAM MARK & T/BEAM ELEVATION (REF. TIE BEAM SCHEDULE) DENOTES WALL FOOTING WITH STEPS. REF. TYP. DETAIL ON S401 - \bot - \bot -


> DENOTES CMU FOUNDATION WALL DENOTES CMU FDN. WALL HELD DOWN AT OPENINGS

4" CONC. SOG

DENOTES SLAB ON GRADE THICKNESS & T/SLAB ELEVATION. ALL SLABS ON GRADE TO BE PLACED ON 6" MIN. COMPACTED GRANULAR FILL & VAPOR BARRIER/RETARDER PER SPECS. PROVIDE THE FOLLOWING WELDED WIRE FABRIC REINFORCING:

DENOTES CMU WALL VERT. REINF. SIZE & SPACING. IF NOT SHOWN, PROVIDE MIN. PER NOTE 11 ABOVE.

4" SLAB: 6x6-W1.4xW1.4 WWF 5" SLAB: 6x6-W2.1xW2.1 WWF 6" SLAB: 6x6-W2.9xW2.9 WWF

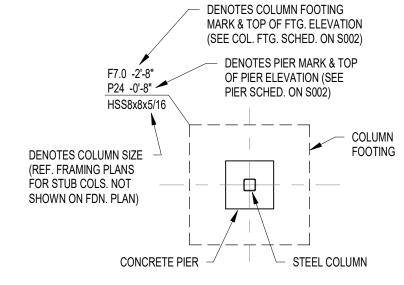



SCOPE DRAWINGS:

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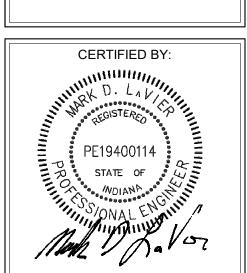
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> **REVISIONS:** ADDENDUM 01 2025-01-29

ISSUE DATE DRAWN BY CHECKED BY 01/15/2025 JRV

> DRAWING TITLE: FIRST FLOOR SLAB PLAN -



DRAWING NUMBER S201B



- REF. S001 & S002 FOR STRUCTURAL NOTES, DESIGN DATA, SCHEDULES & LEGENDS.
 REF. THE S400 SERIES FOR TYPICAL FRAMING AND MASONRY DETAILS.
 ALL CONTRACTORS ARE REQUIRED TO COORDINATE THEIR WORK WITH ALL DISCIPLINES TO AVOID CONFLICTS. THE MECHANICAL ELECTRICAL AND
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 4. ALL EXISTING CONSTRUCTION SHOWN IN PLAN AND/OR SECTION WAS DERIVED FROM EXISTING DRAWINGS AND MUST BE FIELD VERIFIED. IF ANY DISCREPANCIES ARE DISCOVERED BETWEEN INFORMATION SHOWN
- THE ARCHITECT/ENGINEER FOR DIRECTION BEFORE PROCEEDING WITH THE WORK.

 5. ALL ELEVATIONS ARE REFERENCED FROM THE EXISTING FIRST FLOOR FIN. FLOOR ELEVATION +0'-0". VERIFY USGS ELEVATION WITH CIVIL DWGS.

ON THE DRAWINGS AND ACTUAL CONDITIONS, IMMEDIATELY CONTACT

- 6. ALL WALLS SHALL BE LAID OUT FROM THE ARCHITECTURAL DRAWINGS.
 7. REF. ARCH. DRAWINGS. FOR ALL DIMENSIONS NOT SHOWN. CONTRACTOR
- SHALL VERIFY ALL DIMENSIONS PRIOR TO CONSTRUCTION AND IMMEDIATELY NOTIFY ARCHITECT/ENGINEER OF ANY DISCREPANCIES.

 8. COORDINATE EXACT SIZE & LOCATION OF ANY MECHANICAL OPENINGS IN FLOOR SLAB, ROOF DECK, OR WALLS WITH THE MEP CONTRACTOR(S). LOCATION & SIZE OF ALL DUCT OPENINGS, GRILLES, ETC. SHALL BE
- VERIFIED PRIOR TO CONSTRUCTION.

 9. ALL ELEVATIONS SHOWN ON PLAN INDICATE TOP OF STEEL BEAM UNLESS
- NOTED OTHERWISE.

 10. PROVIDE CHANNEL FRAMES AT ALL SUPPORTED SLAB OPENINGS PER TYPICAL DETAIL ON \$404. COORDINATE EXACT NUMBER, LOCATIONS & DIMENSIONS
- DETAIL ON \$404. COORDINATE EXACT NUMBER, LOCATIONS & DIMENSIONS WITH THE APPROPRIATE CONTRACTORS & THE ARCH. & MEP DRAWINGS.

 11. PROVIDE FRAMES AT ALL ROOF DRAINS, ROOF HATCHES & OTHER ROOF

OPENINGS PER TYPICAL DETAILS ON S404. COORD. EXACT NUMBER, LOCATIONS &

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 12. PROVIDE CMU REINFORCING AS NOTED ON PLANS. IF NOT SHOWN ON PLANS, MINIMUM CMU WALL REINFORCING TO BE #5 VERTS @ 48" O.C. PROVIDE OPEN-CORE BOND BEAMS AT TOPS OF WALLS, AT CHANGES IN CMU THICKNESS, AND WHERE INDICATED ON PLANS & SECTIONS (10'-0" O.C. MAX VERTICAL SPACING). PROVIDE 1/2 OF INTERRUPTED VERTICALS AT JAMBS OF
- OPENINGS AND PROVIDE ADDITIONAL VERT'S. AT ENDS OF WALLS.

 13. ALL MASONRY BOND BEAMS, OTHER THAN BOND BEAM LINTELS OVER OPENINGS, SHALL BE "OPEN-CORE" BOND BEAMS TO ALLOW VERTICAL
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 15. FOR ESTIMATING AND BIDDING PURPOSES ONLY, ASSUME AN ADDITIONAL

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 SLABS ON METAL DECK. THE INTENT OF THIS REQUIREMENT IS TO
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 16. PLAN LEGEND:
 - DENOTES FIN. FLOOR

 T/X' DENOTES TOP OF STEEL, SLAB, ETC.

 B/X' DENOTES BOTTOM OF LINTEL, ETC.

 BE DENOTES SLAB EDGE DIMENSION MEASURED FROM BEAM OR COLUMN CENTERLINE

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 DENOTES DECK EDGE ANGLE DIMENSION MEASURED FROM BEAM OR COLUMN CENTERLINE

 BP DENOTES BEAM BEARING PLATE ON CMU WALL
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 DECK w/ 3½" NW CONC SLAB w/ 6x6-W2.1xW2.1
 WWF, TOTAL 't' = 5½". REF. DETAIL 1/S404.

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 REF. DETAILS ON \$405.

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 CONNECTION. REF. DETAILS ON \$404.
 - DENOTES BRACED FRAME OR KICKER LOCATION
 DENOTES APPROX. LOCATION OF OPENING IN DECK/SLAB. REF. DETAILS ON \$404 FOR TYPICAL OPENING FRAMES.
- 17. WIDE-FLANGE BEAM & GIRDER NOTATION:

 BEAM REACTIONS SHOWN IN KIPS TO BE USED FOR


 DESIGN OF SHEAR CONNECTION BY STEEL FABRICATOR'S

 SSE (ALLOWABLE STRESS DESIGN / LOADS UNFACTORED).

 REF. THE STEEL CONNECTION NOTES ON S001 FOR DESIGN OF

 CONNECTIONS AT BEAMS & GIRDERS WITH NO REACTION SHOWN.

 THE MIN. SHEAR CONNECTION DESIGN LOAD SHALL BE 15 KIPS.

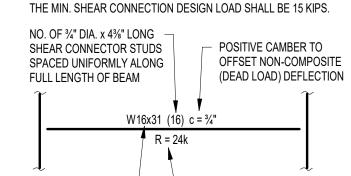

TYPICAL COMPOSITE BEAM DIAGRAM

STEEL BEAM SIZE — DENOTES BEAM REACTION IN

KIPS (SEE NOTES ABOVE)



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O Virginia Avenue
P 317.44
Isanapolis, IN 46203

SCHOOL CORPORATION
RENOVATIONS AND ADDITIONS TO
FRANCES SMITH ELEMENTAR
4505 WAYCROSS DRIVE, COLUMBUS, IN 47201

SCOPE DRAWINGS:

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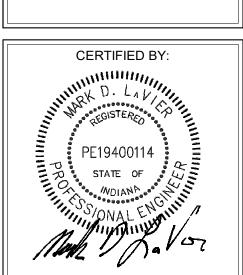
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REVISIONS:
ADDENDUM 01 2025-01-29

ISSUE DATE | DRAWN BY | CHECKED BY

01/15/2025 JRV


SECOND FLOOR & LOW ROOF FRAMING PLAN -UNIT B



DRAWING NUMBER S202B

PROJECT NUMBER 2024023

KEY PLAN NORTH

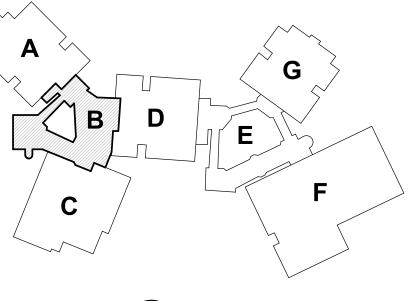



- 1. REF. S001 & S002 FOR STRUCTURAL NOTES, DESIGN DATA, SCHEDULES & LEGENDS. 2. REF. THE S400 SERIES FOR TYPICAL FRAMING AND MASONRY DETAILS. 3. ALL CONTRACTORS ARE REQUIRED TO COORDINATE THEIR WORK WITH ALL
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NO. OF 3/4" DIA. x 43/8" LONG POSITIVE CAMBER TO SHEAR CONNECTOR STUDS OFFSET NON-COMPOSITE SPACED UNIFORMLY ALONG (DEAD LOAD) DEFLECTION FULL LENGTH OF BEAM W16x31 (16) $c = \frac{3}{4}$ "

> KIPS (SEE NOTES ABOVE) TYPICAL COMPOSITE BEAM DIAGRAM

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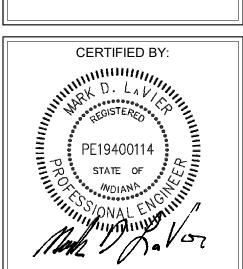
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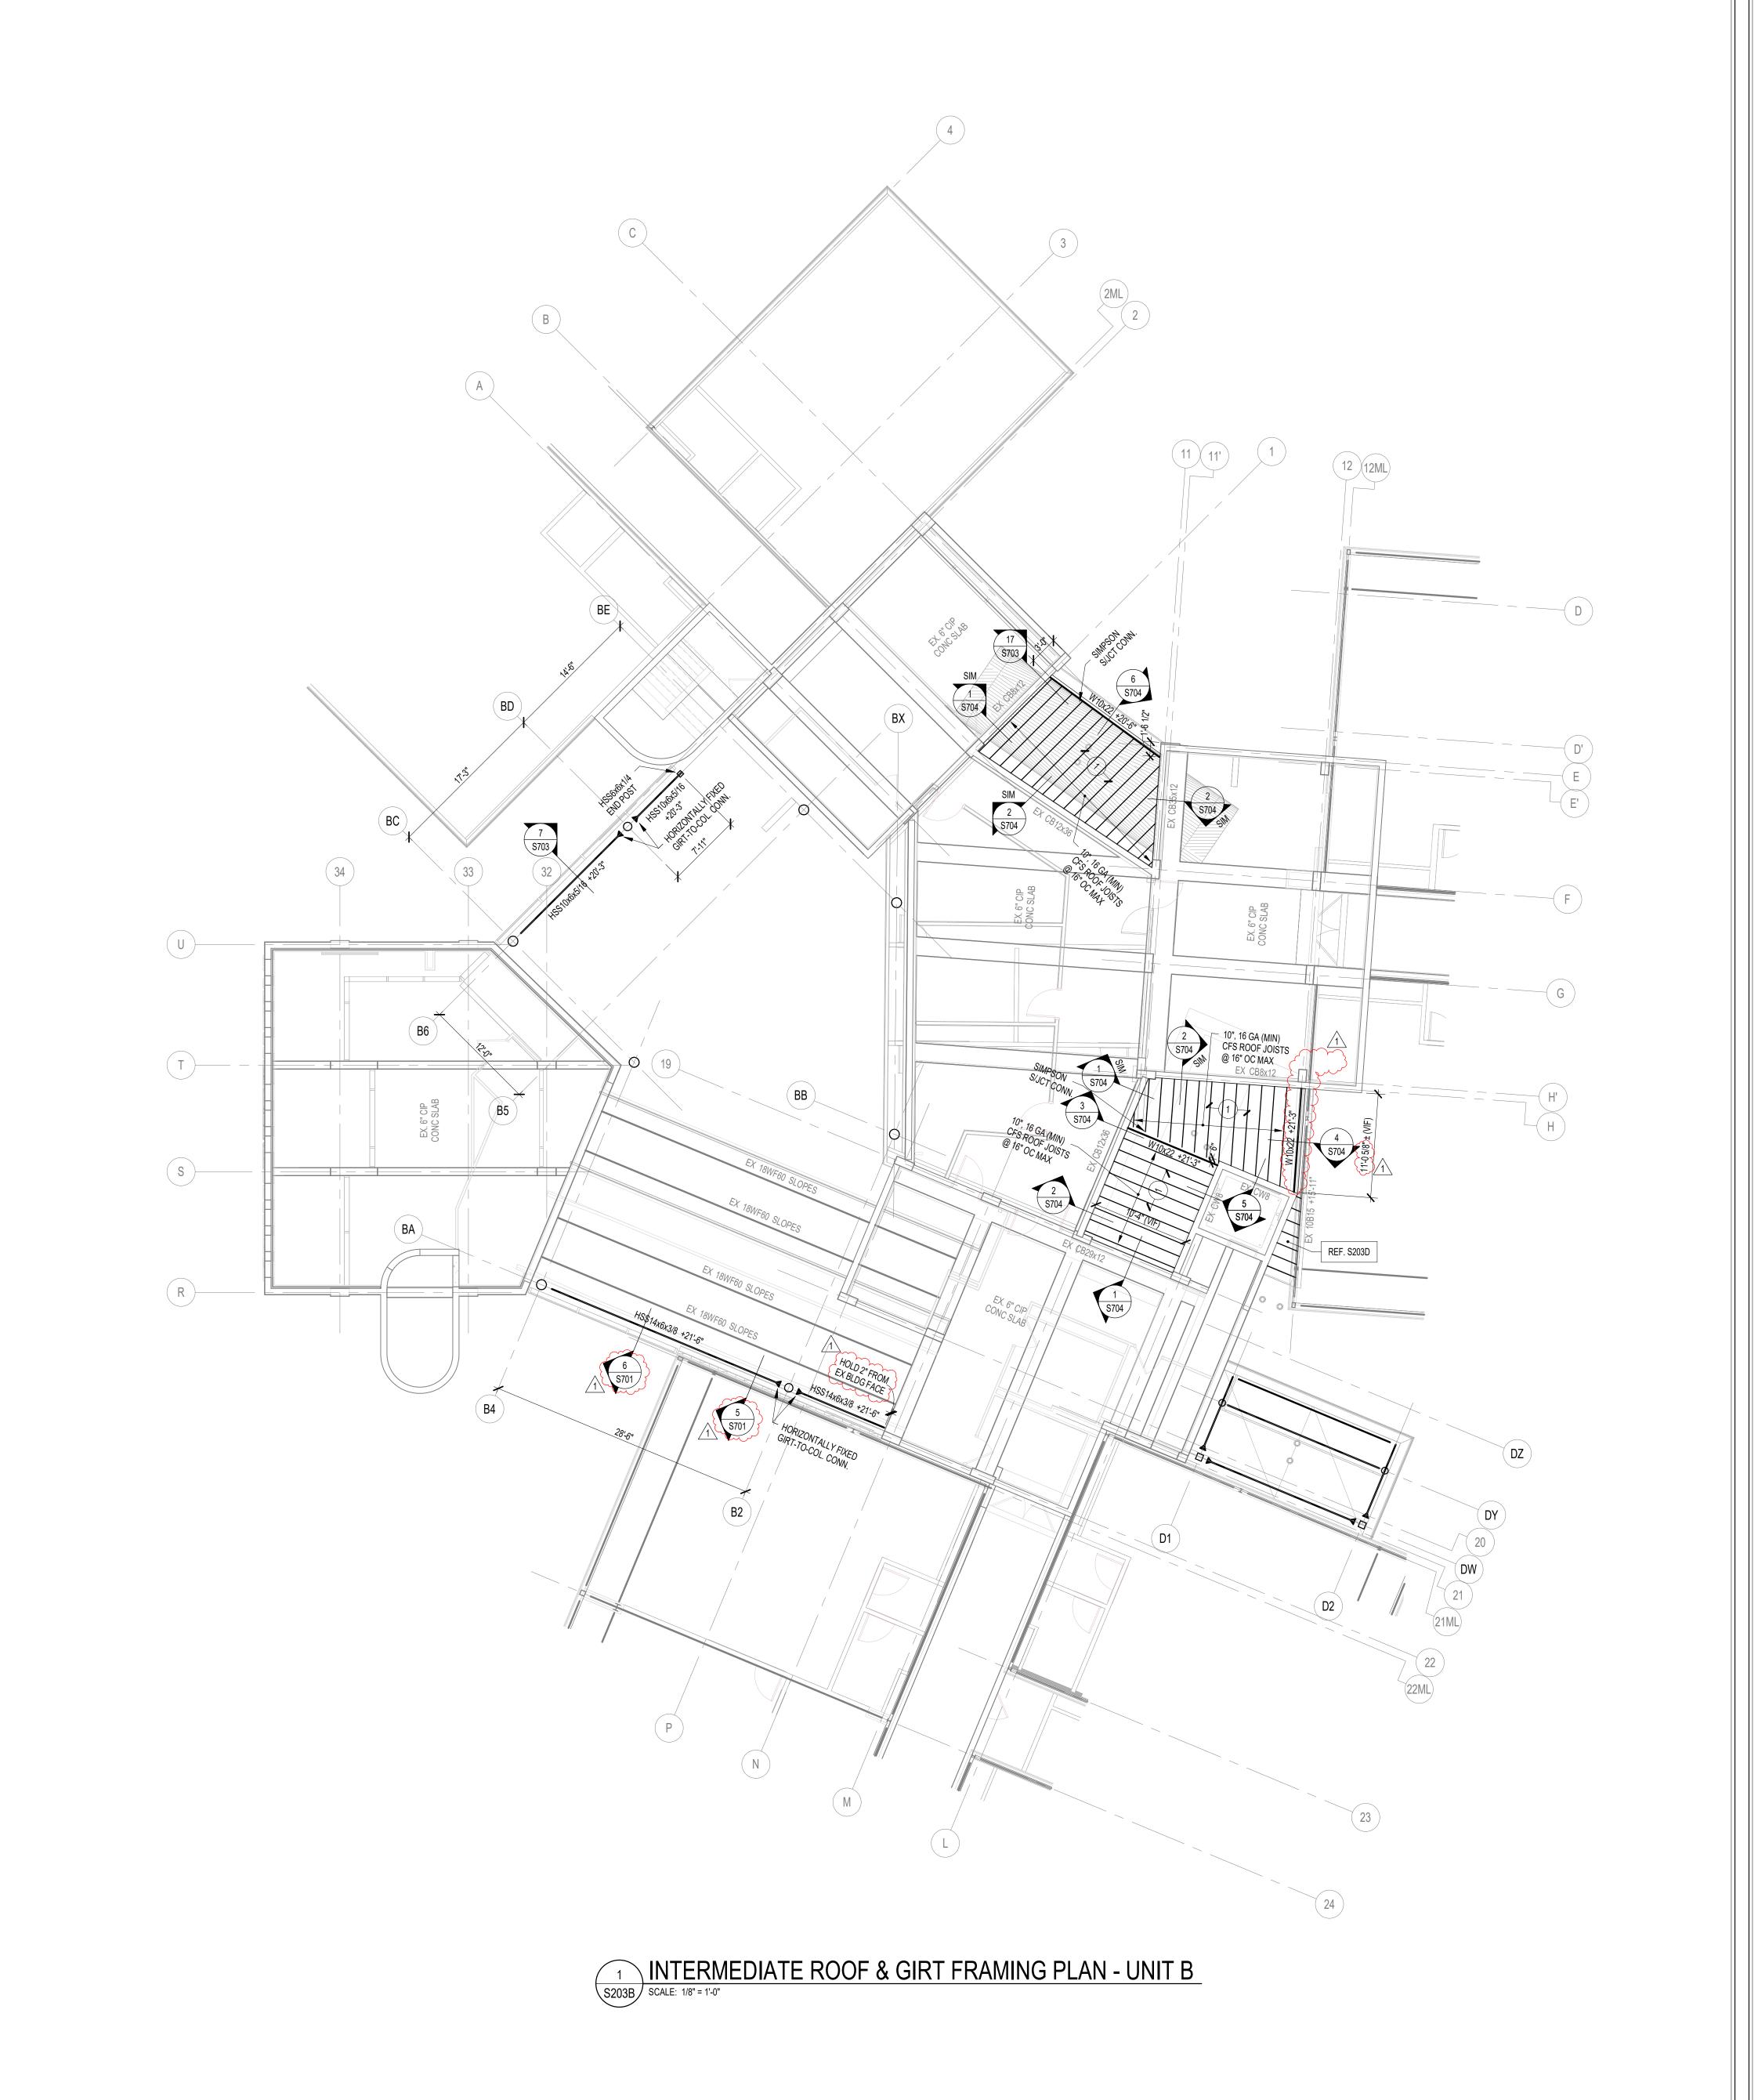
ISSUE DATE DRAWN BY CHECKED BY

DRAWING TITLE: LOW ROOF

01/15/2025 JRV



DRAWING NUMBER S202D



REF. S001 & S002 FOR STRUCTURAL NOTES, DESIGN DATA, SCHEDULES & LEGENDS.
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WWF, TOTAL 't' = 5½". REF. DETAIL 1/S404.

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NO. OF 3/4" DIA. x 43/4" LONG
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FULL LENGTH OF BEAM

W16x31 (16) c = 3/4"

R = 24k

STEEL BEAM SIZE

DENOTES BEAM REACTION IN

TYPICAL COMPOSITE BEAM DIAGRAM

KEY PLAN

KIPS (SEE NOTES ABOVE)



Indianapolis, IN 46240

8831 Keystone Crossing, Indiana 317.848.7800 | csoind

Brumleve, Inc. P 317.423.1550 F 317.423.1551

550 Virginia Avenue Indianapolis, IN 46203

SCHOOL CORPORATION
RENOVATIONS AND ADDITIONS T
L. FRANCES SMITH ELEMENTA
4505 WAYCROSS DRIVE, COLUMBUS, IN 472

SCOPE DRAWINGS:

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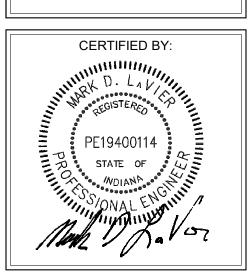
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REVISIONS:
ADDENDUM 01 2025-01-29


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01/15/2025 JRV

INTERMEDIATE
ROOF & GIRT
FRAMING PLAN UNIT B



S203B

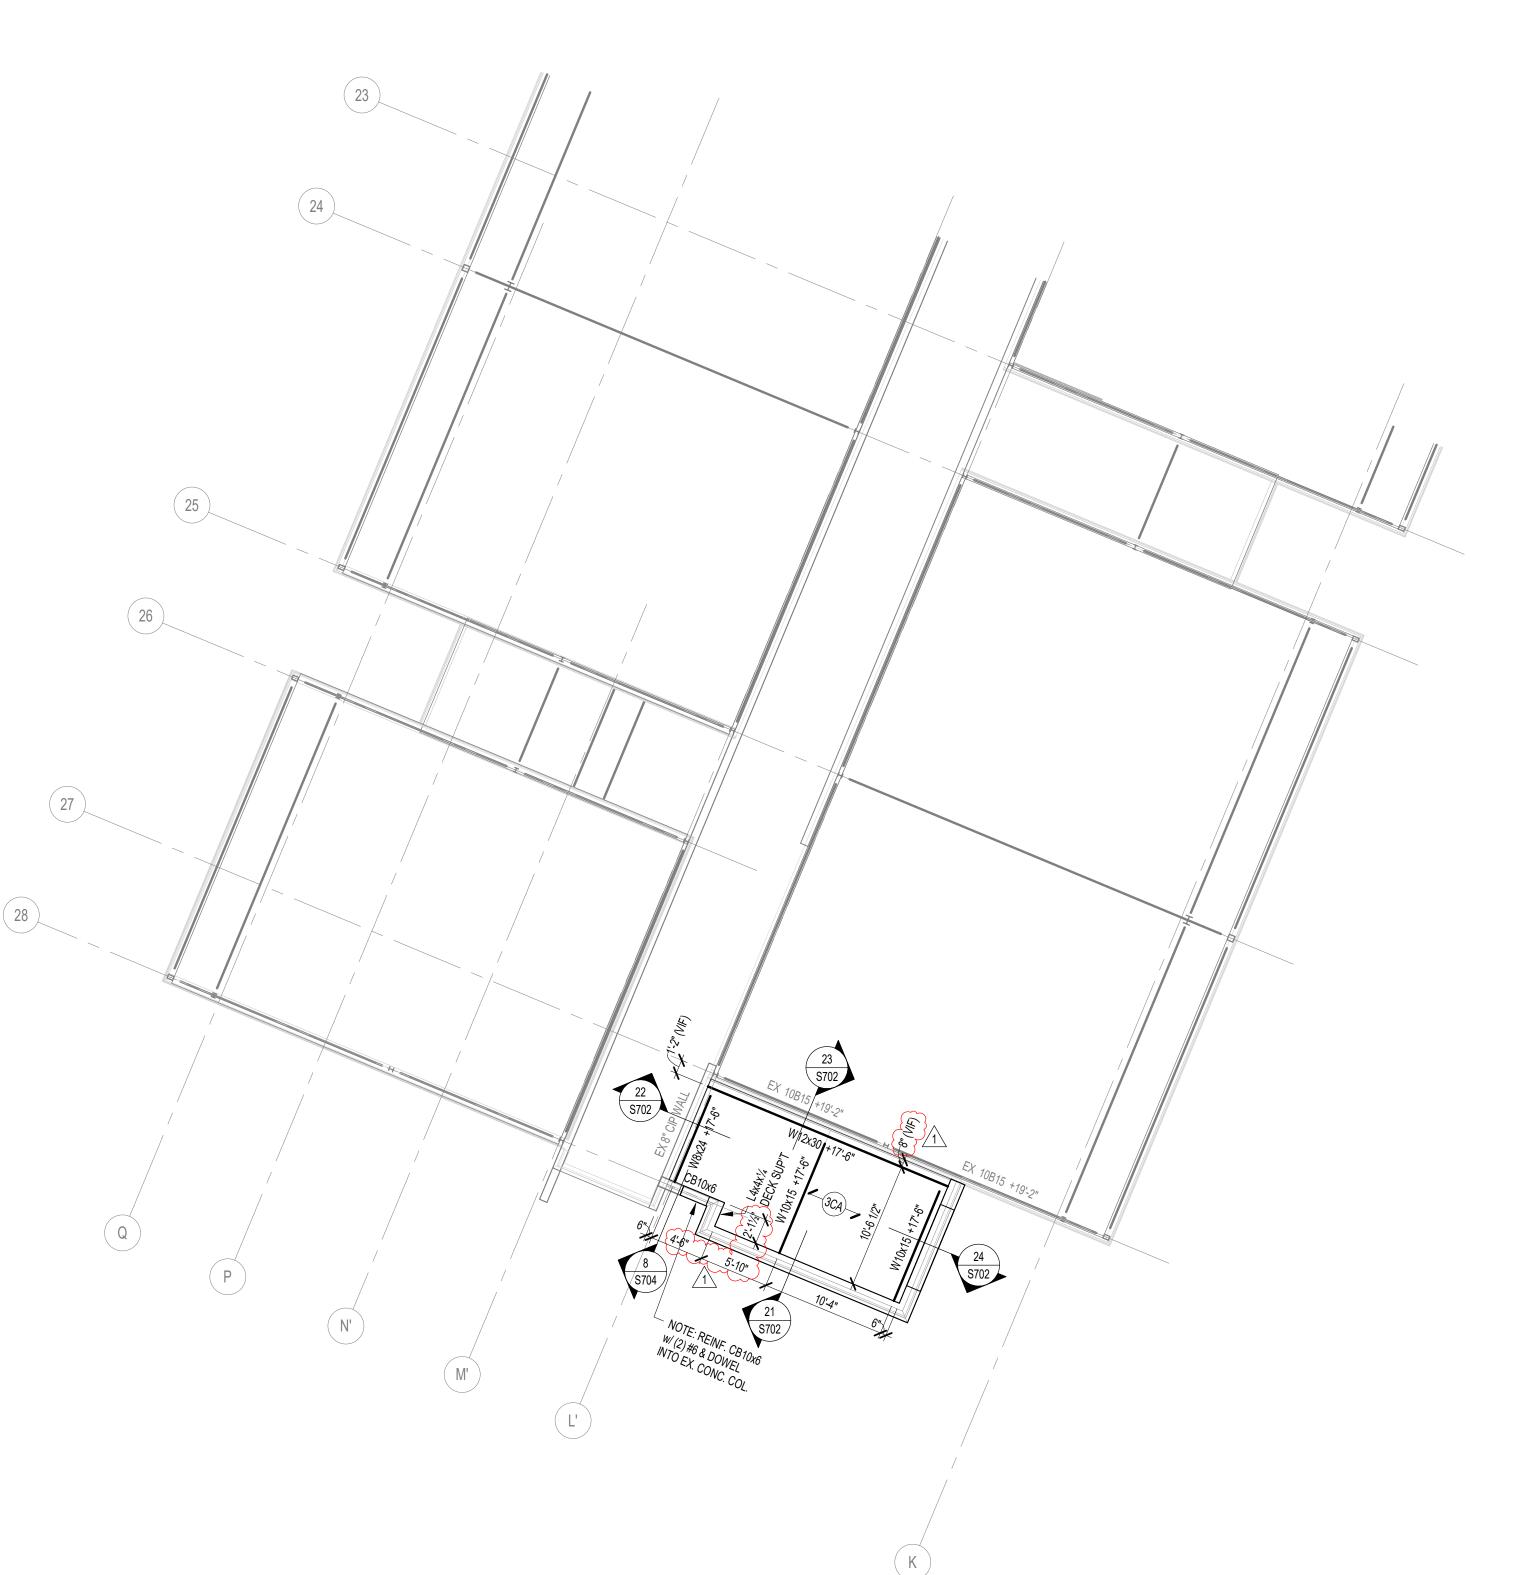

- REF. S001 & S002 FOR STRUCTURAL NOTES, DESIGN DATA, SCHEDULES & LEGENDS.
 REF. THE S400 SERIES FOR TYPICAL FRAMING AND MASONRY DETAILS.
 ALL CONTRACTORS ARE REQUIRED TO COORDINATE THEIR WORK WITH ALL PROCEDURES TO A VIOLE CONTRACTOR. THE MECHANICAL PLEASURE. AND
- ALL CONTRACTORS ARE REQUIRED TO COORDINATE THEIR WORK WITH ALL DISCIPLINES TO AVOID CONFLICTS. THE MECHANICAL, ELECTRICAL, AND PLUMBING ASPECTS ARE NOT IN THE SCOPE OF THESE DRAWINGS. THEREFORE, ALL REQUIRED MATERIALS AND WORK MAY NOT BE INDICATED.
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ON THE DRAWINGS AND ACTUAL CONDITIONS, IMMEDIATELY CONTACT THE ARCHITECT/ENGINEER FOR DIRECTION BEFORE PROCEEDING WITH

- THE WORK.

 5. ALL ELEVATIONS ARE REFERENCED FROM THE EXISTING FIRST FLOOR FIN. FLOOR ELEVATION +0'-0". VERIFY USGS ELEVATION WITH CIVIL DWGS.
- 6. ALL WALLS SHALL BE LAID OUT FROM THE ARCHITECTURAL DRAWINGS.
 7. REF. ARCH. DRAWINGS. FOR ALL DIMENSIONS NOT SHOWN. CONTRACTOR
- SHALL VERIFY ALL DIMENSIONS PRIOR TO CONSTRUCTION AND IMMEDIATELY NOTIFY ARCHITECT/ENGINEER OF ANY DISCREPANCIES.

 8. COORDINATE EXACT SIZE & LOCATION OF ANY MECHANICAL OPENINGS IN FLOOR SLAB, ROOF DECK, OR WALLS WITH THE MEP CONTRACTOR(S). LOCATION & SIZE OF ALL DUCT OPENINGS, GRILLES, ETC. SHALL BE
- VERIFIED PRIOR TO CONSTRUCTION.

 9. ALL ELEVATIONS SHOWN ON PLAN INDICATE TOP OF STEEL BEAM UNLESS NOTED OTHERWISE
- NOTED OTHERWISE.

 10. PROVIDE CHANNEL FRAMES AT ALL SUPPORTED SLAB OPENINGS PER TYPICAL DETAIL ON S404. COORDINATE EXACT NUMBER, LOCATIONS & DIMENSIONS WITH THE APPROPRIATE CONTRACTORS & THE ARCH. & MEP DRAWINGS.
- PROVIDE FRAMES AT ALL ROOF DRAINS, ROOF HATCHES & OTHER ROOF OPENINGS PER TYPICAL DETAILS ON \$404. COORD. EXACT NUMBER, LOCATIONS & DIMENSIONS WITH THE APPROPRIATE CONTRACTORS & THE ARCH. & MEP DWGS.
 PROVIDE CMU REINFORCING AS NOTED ON PLANS. IF NOT SHOWN ON PLANS,
- MINIMUM CMU WALL REINFORCING TO BE #5 VERTS @ 48" O.C. PROVIDE OPEN-CORE BOND BEAMS AT TOPS OF WALLS, AT CHANGES IN CMU THICKNESS, AND WHERE INDICATED ON PLANS & SECTIONS (10'-0" O.C. MAX VERTICAL SPACING). PROVIDE 1/2 OF INTERRUPTED VERTICALS AT JAMBS OF OPENINGS AND PROVIDE ADDITIONAL VERT'S. AT ENDS OF WALLS.
- ALL MASONRY BOND BEAMS, OTHER THAN BOND BEAM LINTELS OVER
 OPENINGS, SHALL BE "OPEN-CORE" BOND BEAMS TO ALLOW VERTICAL
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 REF. ARCH. DWGS. FOR MASONRY CONTROL & EXPANSION JOINT LOCATIONS.
- 15. FOR ESTIMATING AND BIDDING PURPOSES ONLY, ASSUME AN ADDITIONAL 1/2" THICKNESS OF CONCRETE WILL BE NECESSARY FOR ALL ELEVATED SLABS ON METAL DECK. THE INTENT OF THIS REQUIREMENT IS TO ACCOUNT FOR ANTICIPATED DEAD LOAD DEFLECTIONS IN THE SUPPORTING STRUCTURE. THE FINISHED SLAB SHALL MEET THE FLATNESS REQUIREMENTS DEFINED IN THE SPECIFICATION.
 16. PLAN LEGEND:
 - DENOTES FIN. FLOOR
 DENOTES TOP OF STEEL, SLAB, ETC.
 DENOTES BOTTOM OF LINTEL, ETC.
 DENOTES SLAB EDGE DIMENSION MEASURED
 FROM BEAM OR COLUMN CENTERLINE
 DENOTES DECK EDGE ANGLE DIMENSION
 MEASURED FROM BEAM OR COLUMN CENTERLINE
 DENOTES BEAM BEARING PLATE ON CMU WALL

WWF, TOTAL 't' = 4". REF. DETAIL 2/S404.

- DENOTES 2", 20 GA. GALVANIZED COMPOSITE DECK w/ 3½" NW CONC SLAB w/ 6x6-W2.1xW2.1 WWF, TOTAL 't' = 5½". REF. DETAIL 1/S404.

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- DENOTES 3", 18 GA. GALVANIZED COMPOSITE DECK w/ 2½" NW CONC SLAB w/ 6x6-W1.4xW1.4 WWF, TOTAL 't' = 5½". REF. DETAIL 9/S405.
- DENOTES 1½", 20 GA. GALVANIZED & PRIME-PAINTED WIDE RIB STEEL ROOF DECK. REF. DETAIL 3/S404.
- DENOTES 3", 18 GA. GALVANIZED & PRIME-PAINTED DEEP RIB STEEL ROOF DECK. REF. DETAIL 8/S405.
- DENOTES 3", 20/20 GA. GALVANIZED & PRIME-PAINTED DEEP RIB CELLULAR ACOUSTIC STEEL ROOF DECK W/ INSULATION, NRC=0.95. REF. DETAIL 4/S404.
- DENOTES BEAM-TO-COLUMN MOMENT CONNECTION.
 REF. DETAILS ON \$405.

 DENOTES BEAM-THRU-BEAM MOMENT
 CONNECTION. REF. DETAILS ON \$404.
- DENOTES BRACED FRAME OR KICKER LOCATION

 DENOTES APPROX. LOCATION OF OPENING IN
 DECK/SLAB. REF. DETAILS ON \$404 FOR TYPICAL
 OPENING FRAMES.

17. WIDE-FLANGE BEAM & GIRDER NOTATION:

BEAM REACTIONS SHOWN IN KIPS TO BE USED FOR

DESIGN OF SHEAR CONNECTION BY STEEL FABRICATOR'S

SSE (ALLOWABLE STRESS DESIGN / LOADS UNFACTORED).

REF. THE STEEL CONNECTION NOTES ON S001 FOR DESIGN OF

CONNECTIONS AT BEAMS & GIRDERS WITH NO REACTION SHOWN.

THE MIN. SHEAR CONNECTION DESIGN LOAD SHALL BE 15 KIPS.

THE MIN. SHEAR CONNECTION DESIGN LOAD SHALL BE 15 KIPS.

NO. OF 3/4" DIA. x 43/8" LONG
SHEAR CONNECTOR STUDS
SPACED UNIFORMLY ALONG
FULL LENGTH OF BEAM

W16x31 (16) c = 3/4"

R = 24k

STEEL BEAM SIZE

DENOTES BEAM REACTION IN

KEY PLAN

TYPICAL COMPOSITE BEAM DIAGRAM

KIPS (SEE NOTES ABOVE)



, Indianapolis, IN 46240 | csoinc.net

8831 Keystone Cross 317.848.78

Virginia Avenue P 317.423.14 ianapolis, IN 46203 F 317.423.14

SCHOOL CORPORATION
SCHOOL CORPORATION
RENOVATIONS AND ADDITIONS TO
FRANCES SMITH ELEMENTARY
4505 WAYCROSS DRIVE, COLUMBUS, IN 47201

SCOPE DRAWINGS:

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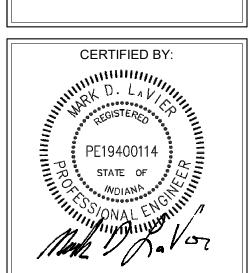
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REVISIONS:


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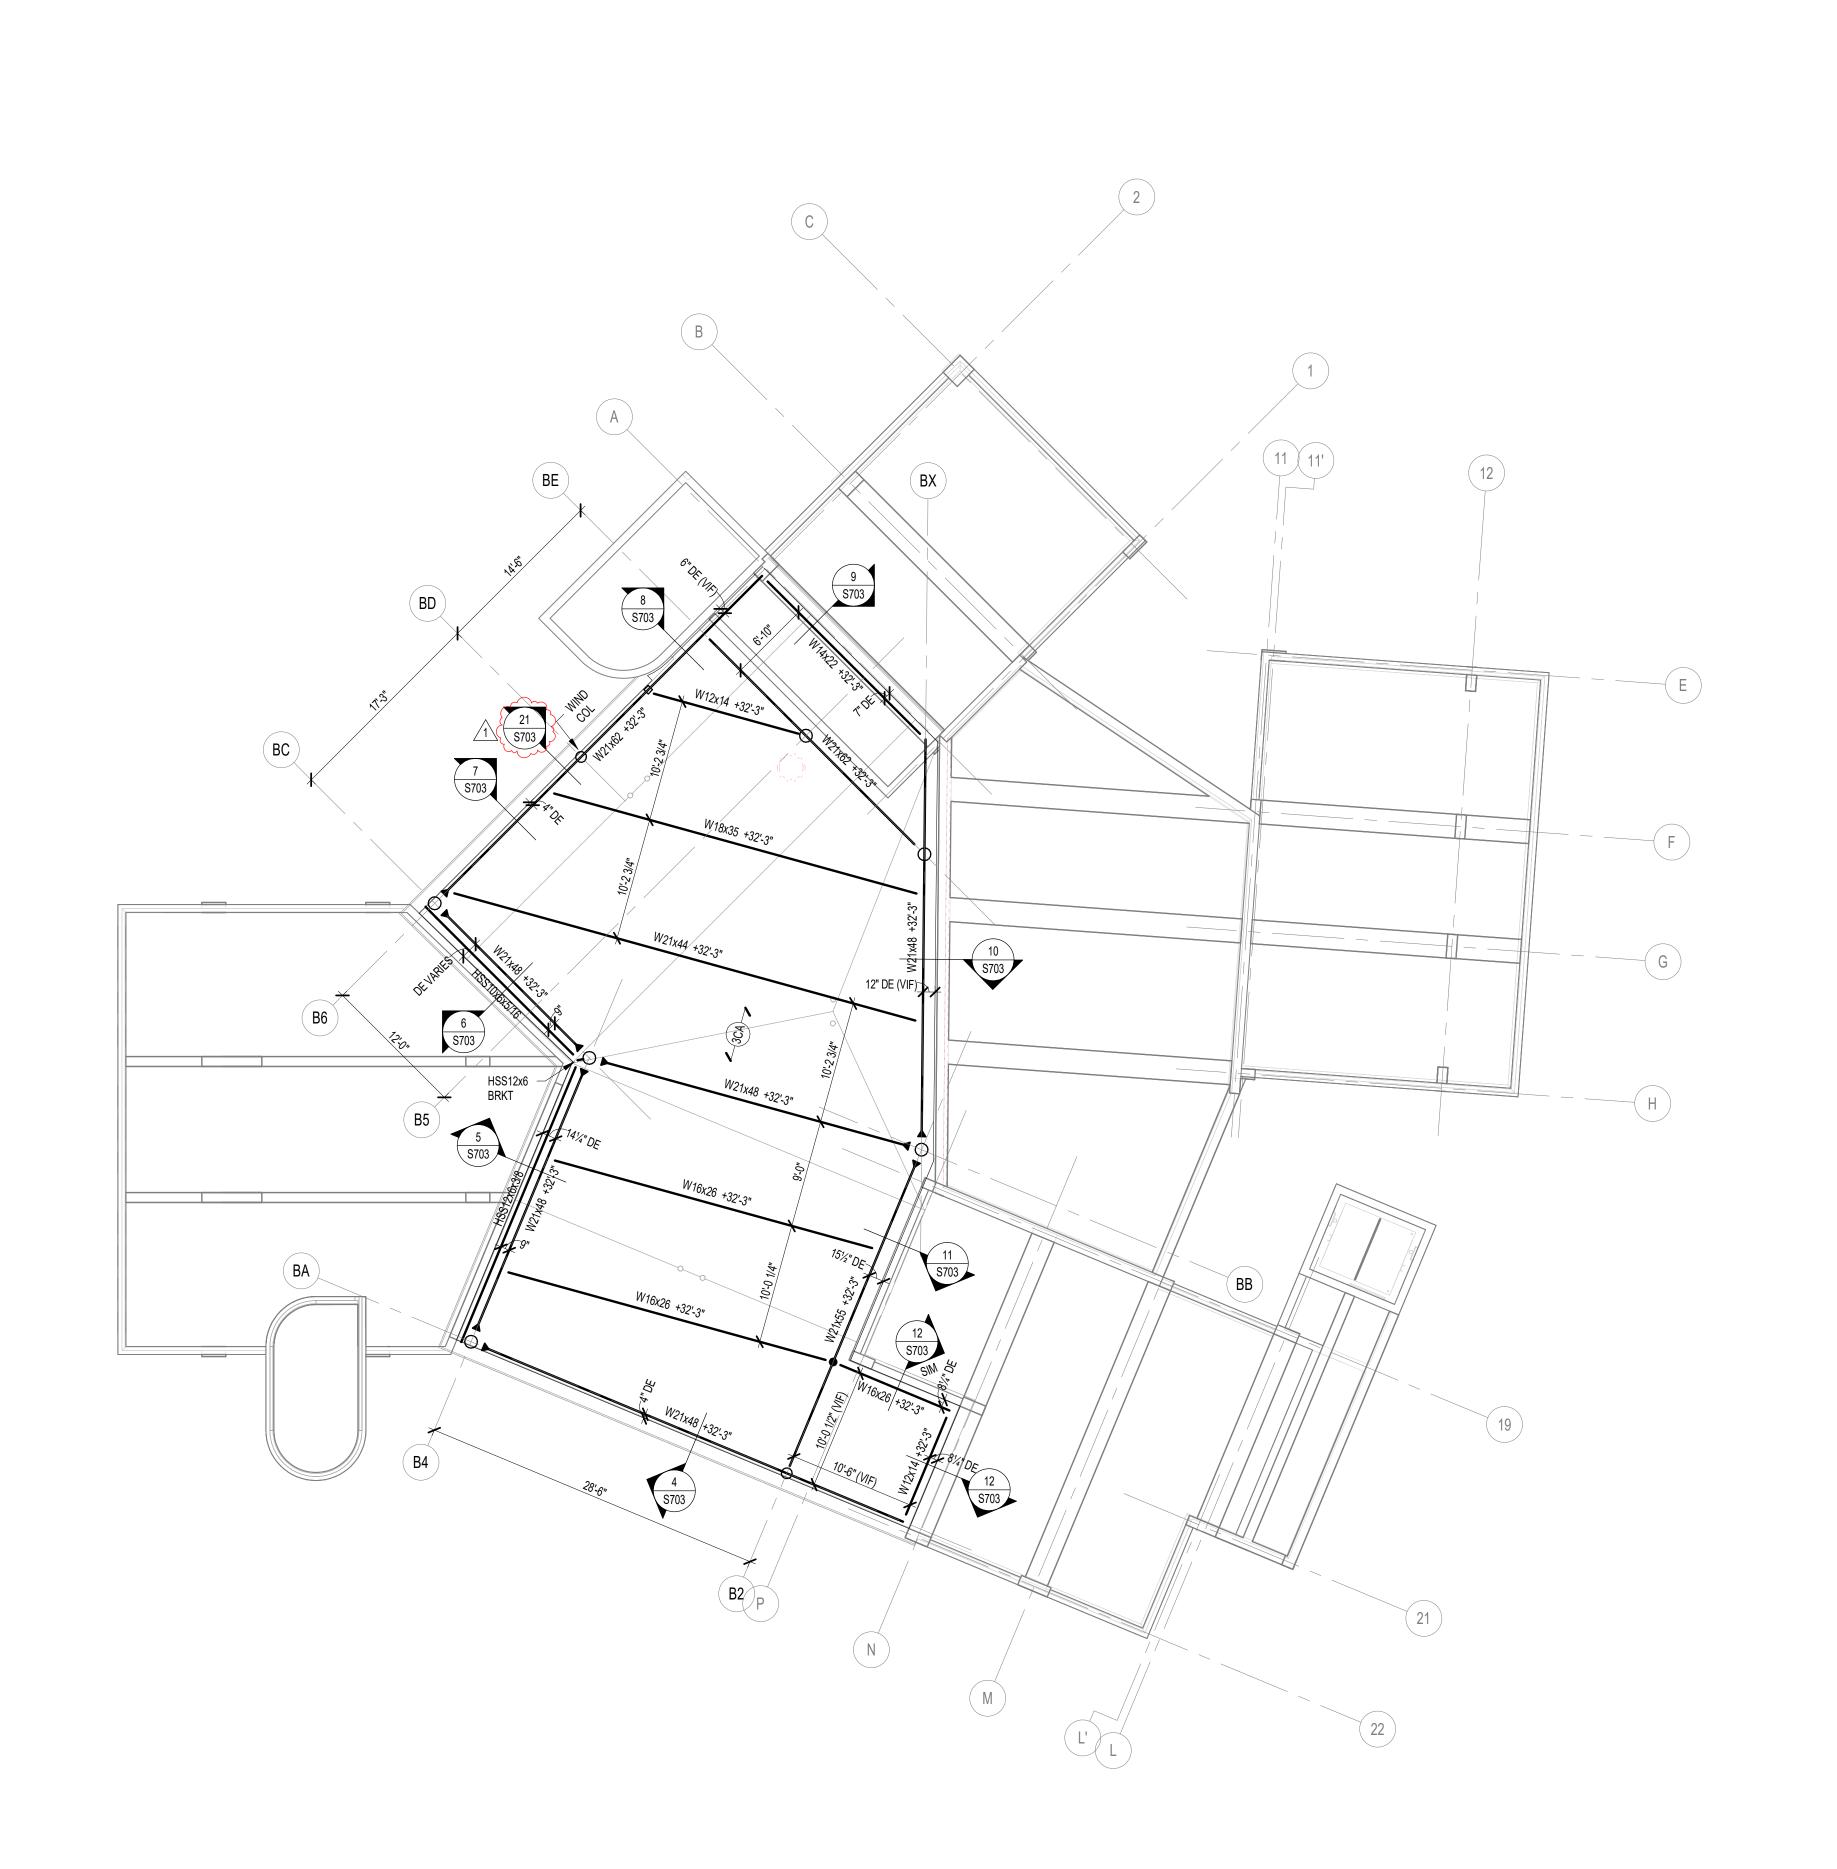
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ROOF FRAMING PLAN - UNIT C



S203C



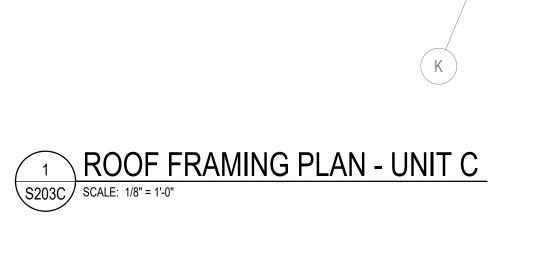

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- FLOOR ELEVATION +0'-0". VERIFY USGS ELEVATION WITH CIVIL DWGS.

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W16x31 (16) c = 3/4"

DENOTES BEAM REACTION IN
KIPS (SEE NOTES ABOVE)

KEY PLAN

TYPICAL COMPOSITE BEAM DIAGRAM



Indianapolis, IN 46240

8831 Keystone Crossing 317.848.7800

Harrison

Harrison

Brumleve

Rainia Avenue

P 317.423.155

apolis, IN 46203

F 317.423.155

CES SMITH ELEMENTARY
CROSS DRIVE, COLUMBUS, IN 47201

SCOPE DRAWINGS:

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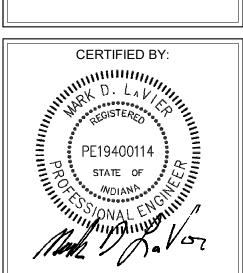
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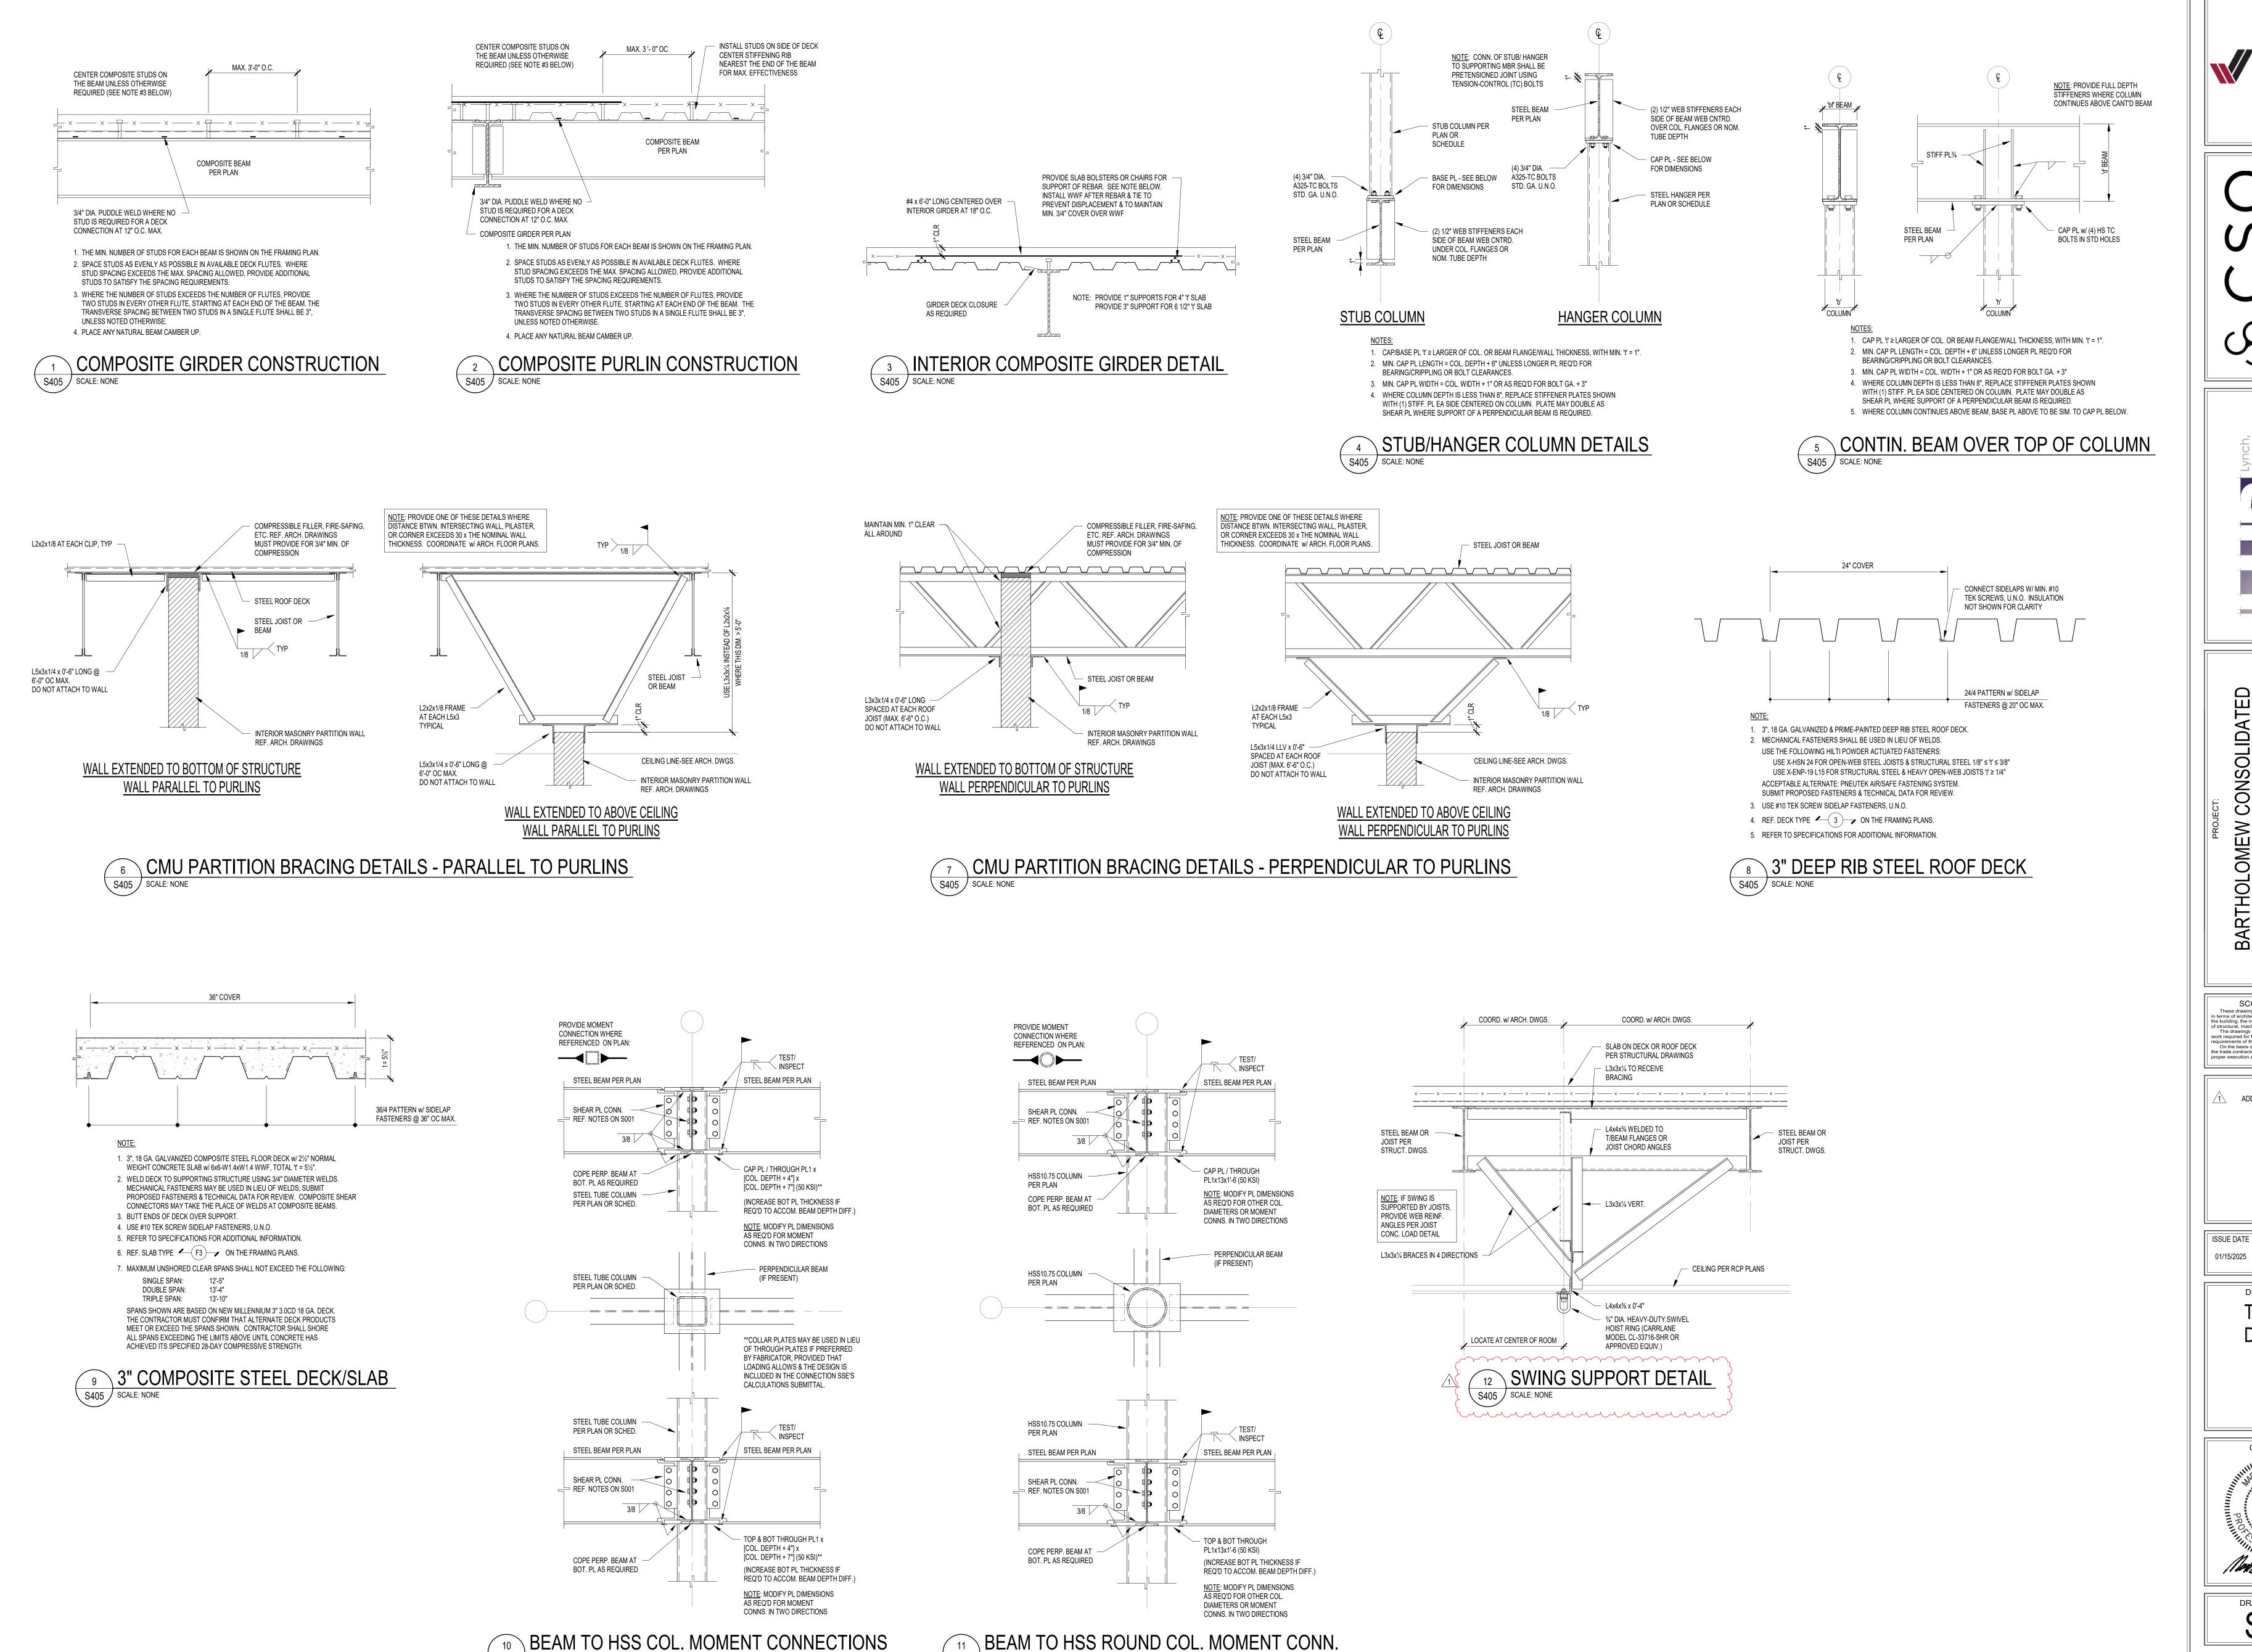
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01/15/2025 JRV

ROOF FRAMING
PLAN - UNIT B



DRAWING NUMBER
S204B



S405 SCALE: NONE

S405 SCALE: NONE



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Lynch,
Harrison &
Harrison &
Brumleve,
Inc.
Inc.
P 317.423.1550
olis, IN 46203
F 317.423.1551

SCHOOL CORPORATION
OVATIONS AND ADDITIONS TO
ANCES SMITH ELEMENTARY

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TYPICAL DETAILS

CERTIFIED BY:

PE19400114


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STATE OF

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WOJAN

S405



WBCSC TOGETHER WE LEARN

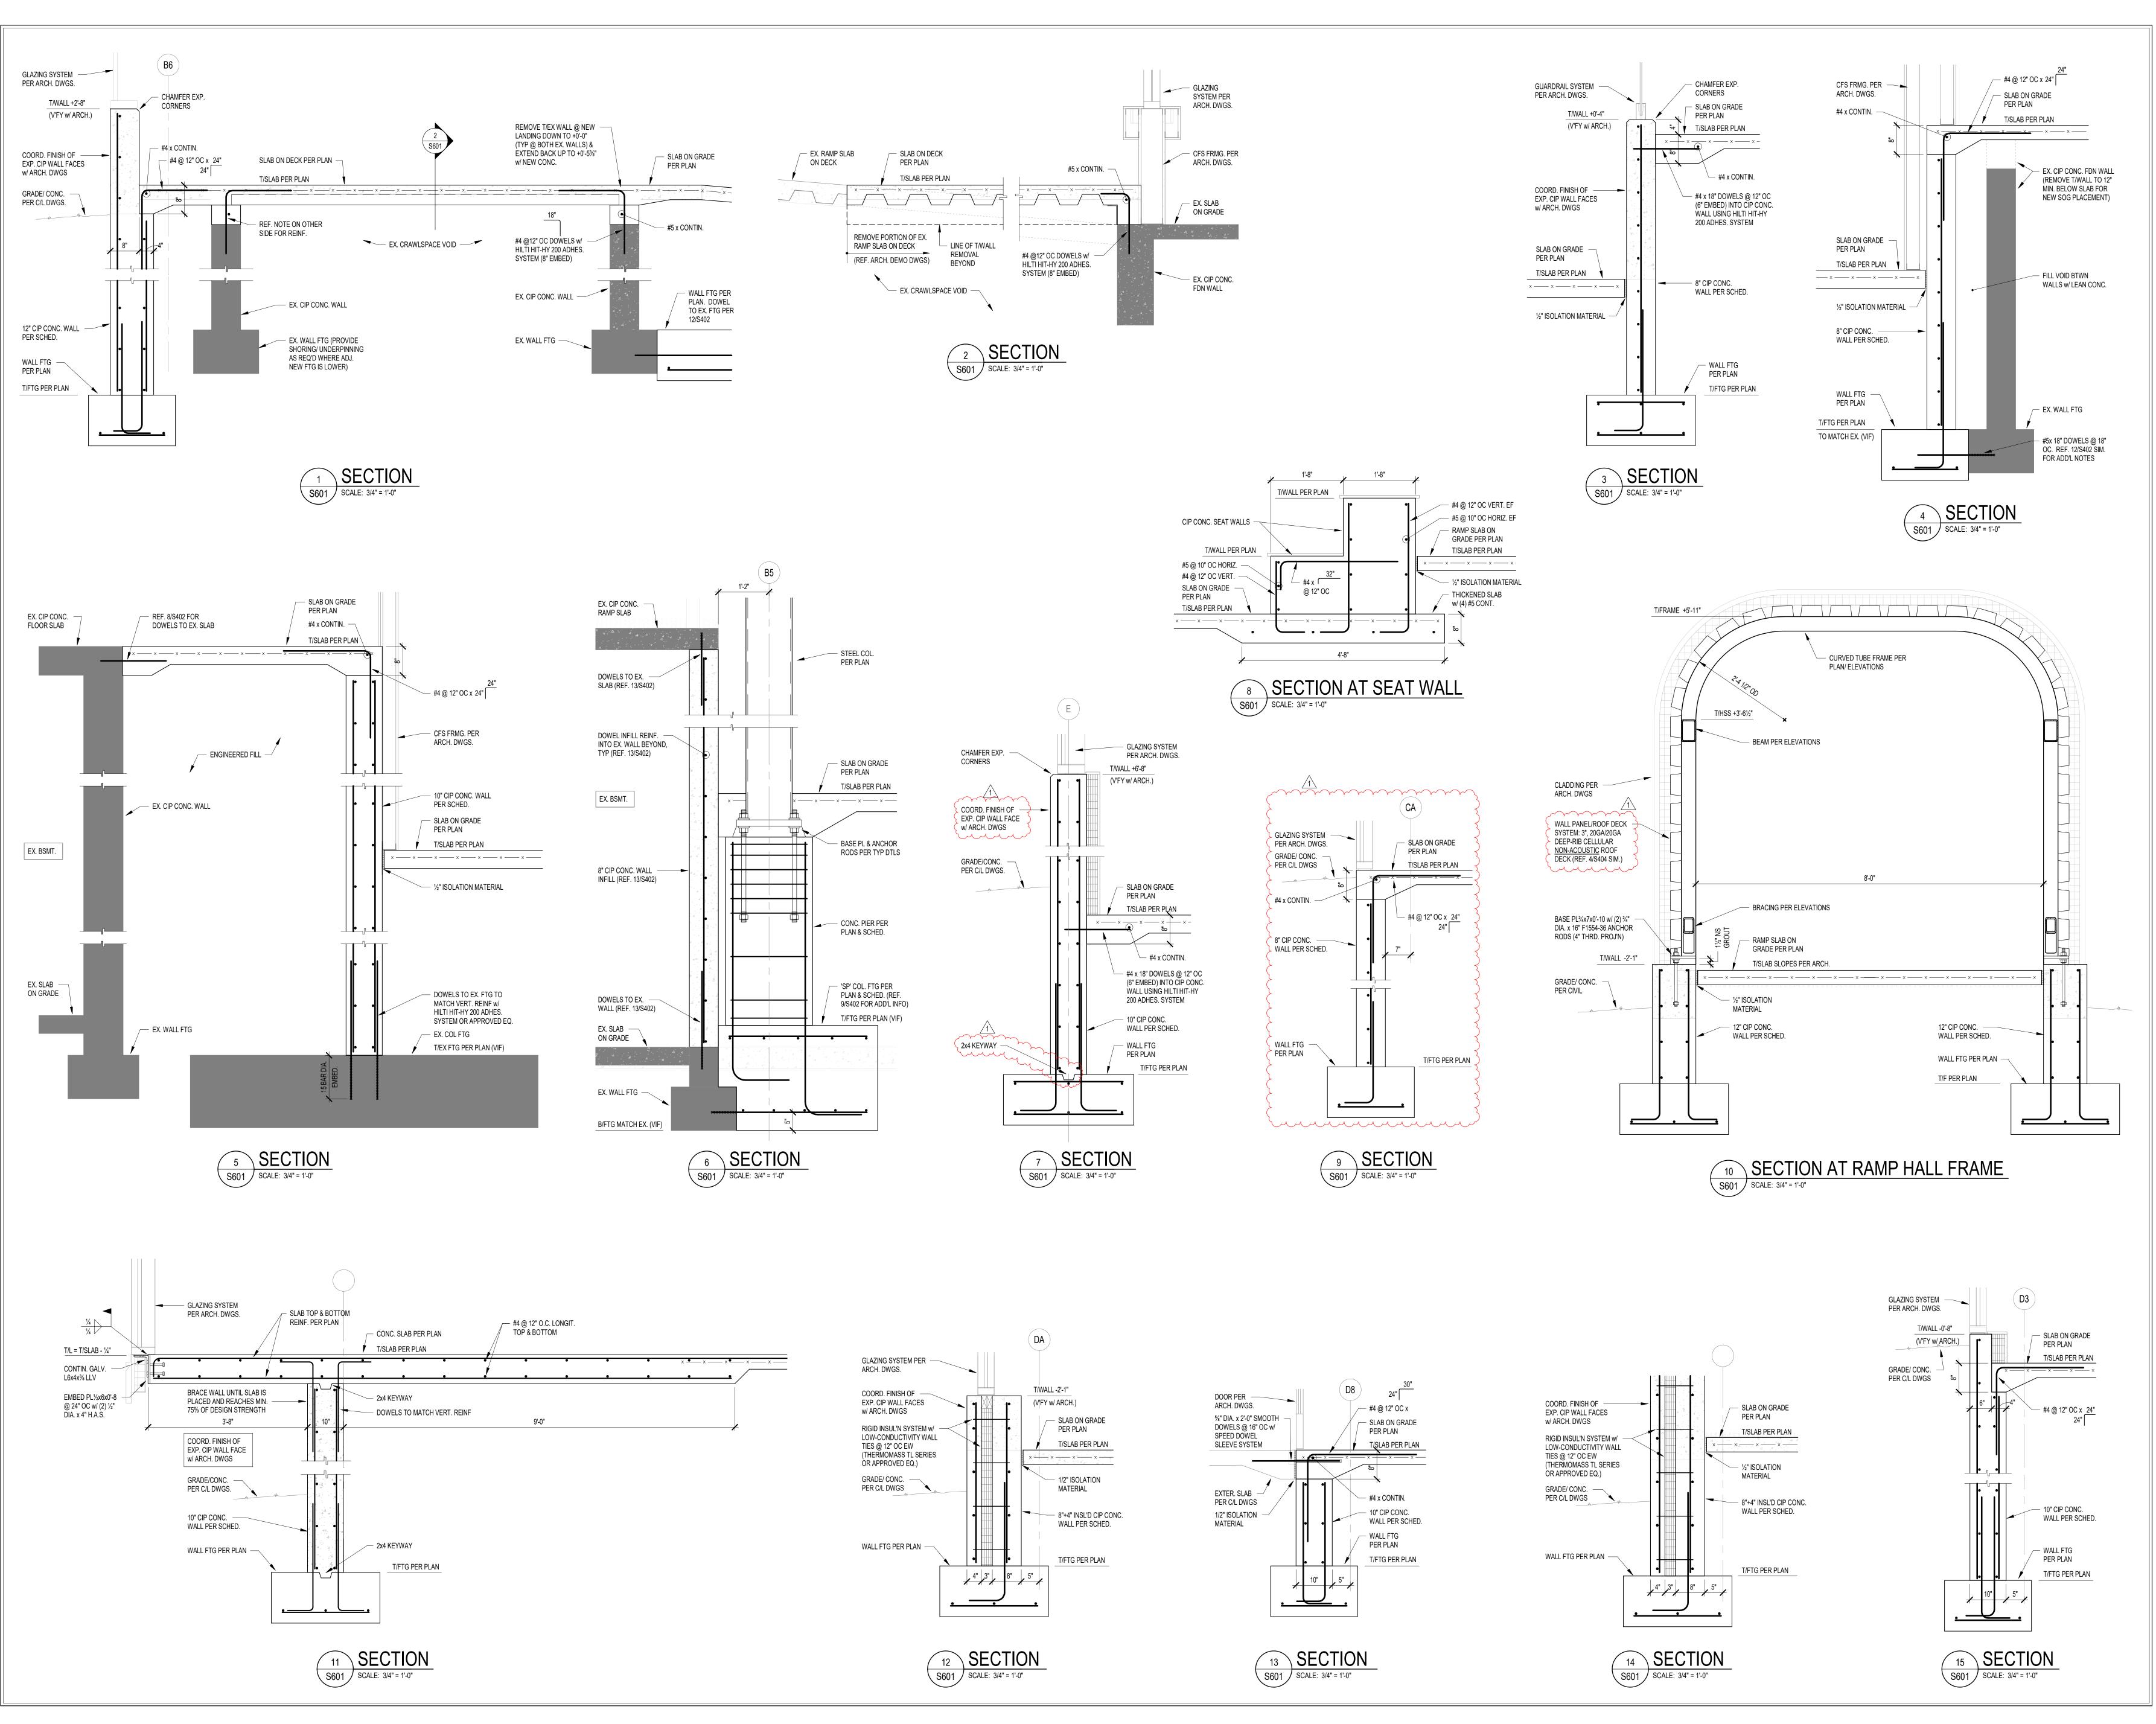SCSO

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Harrison &
Brumleve,
Inc.
P 317.423.1550
F 317.423.1551

Lynck Harris Bruml Bruml Bruml Bruml Bruml Indianapolis, IN 46203 F 317.423

BARTHOLOMEW CONSOLIDATED
SCHOOL CORPORATION
RENOVATIONS AND ADDITIONS TO
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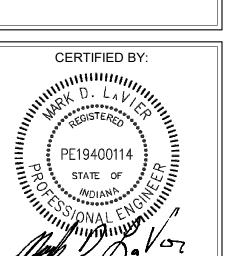
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FOUNDATION SECTIONS AND DETAILS




DRAWING NUMBER

S601

PROJECT NUMBER

2024023

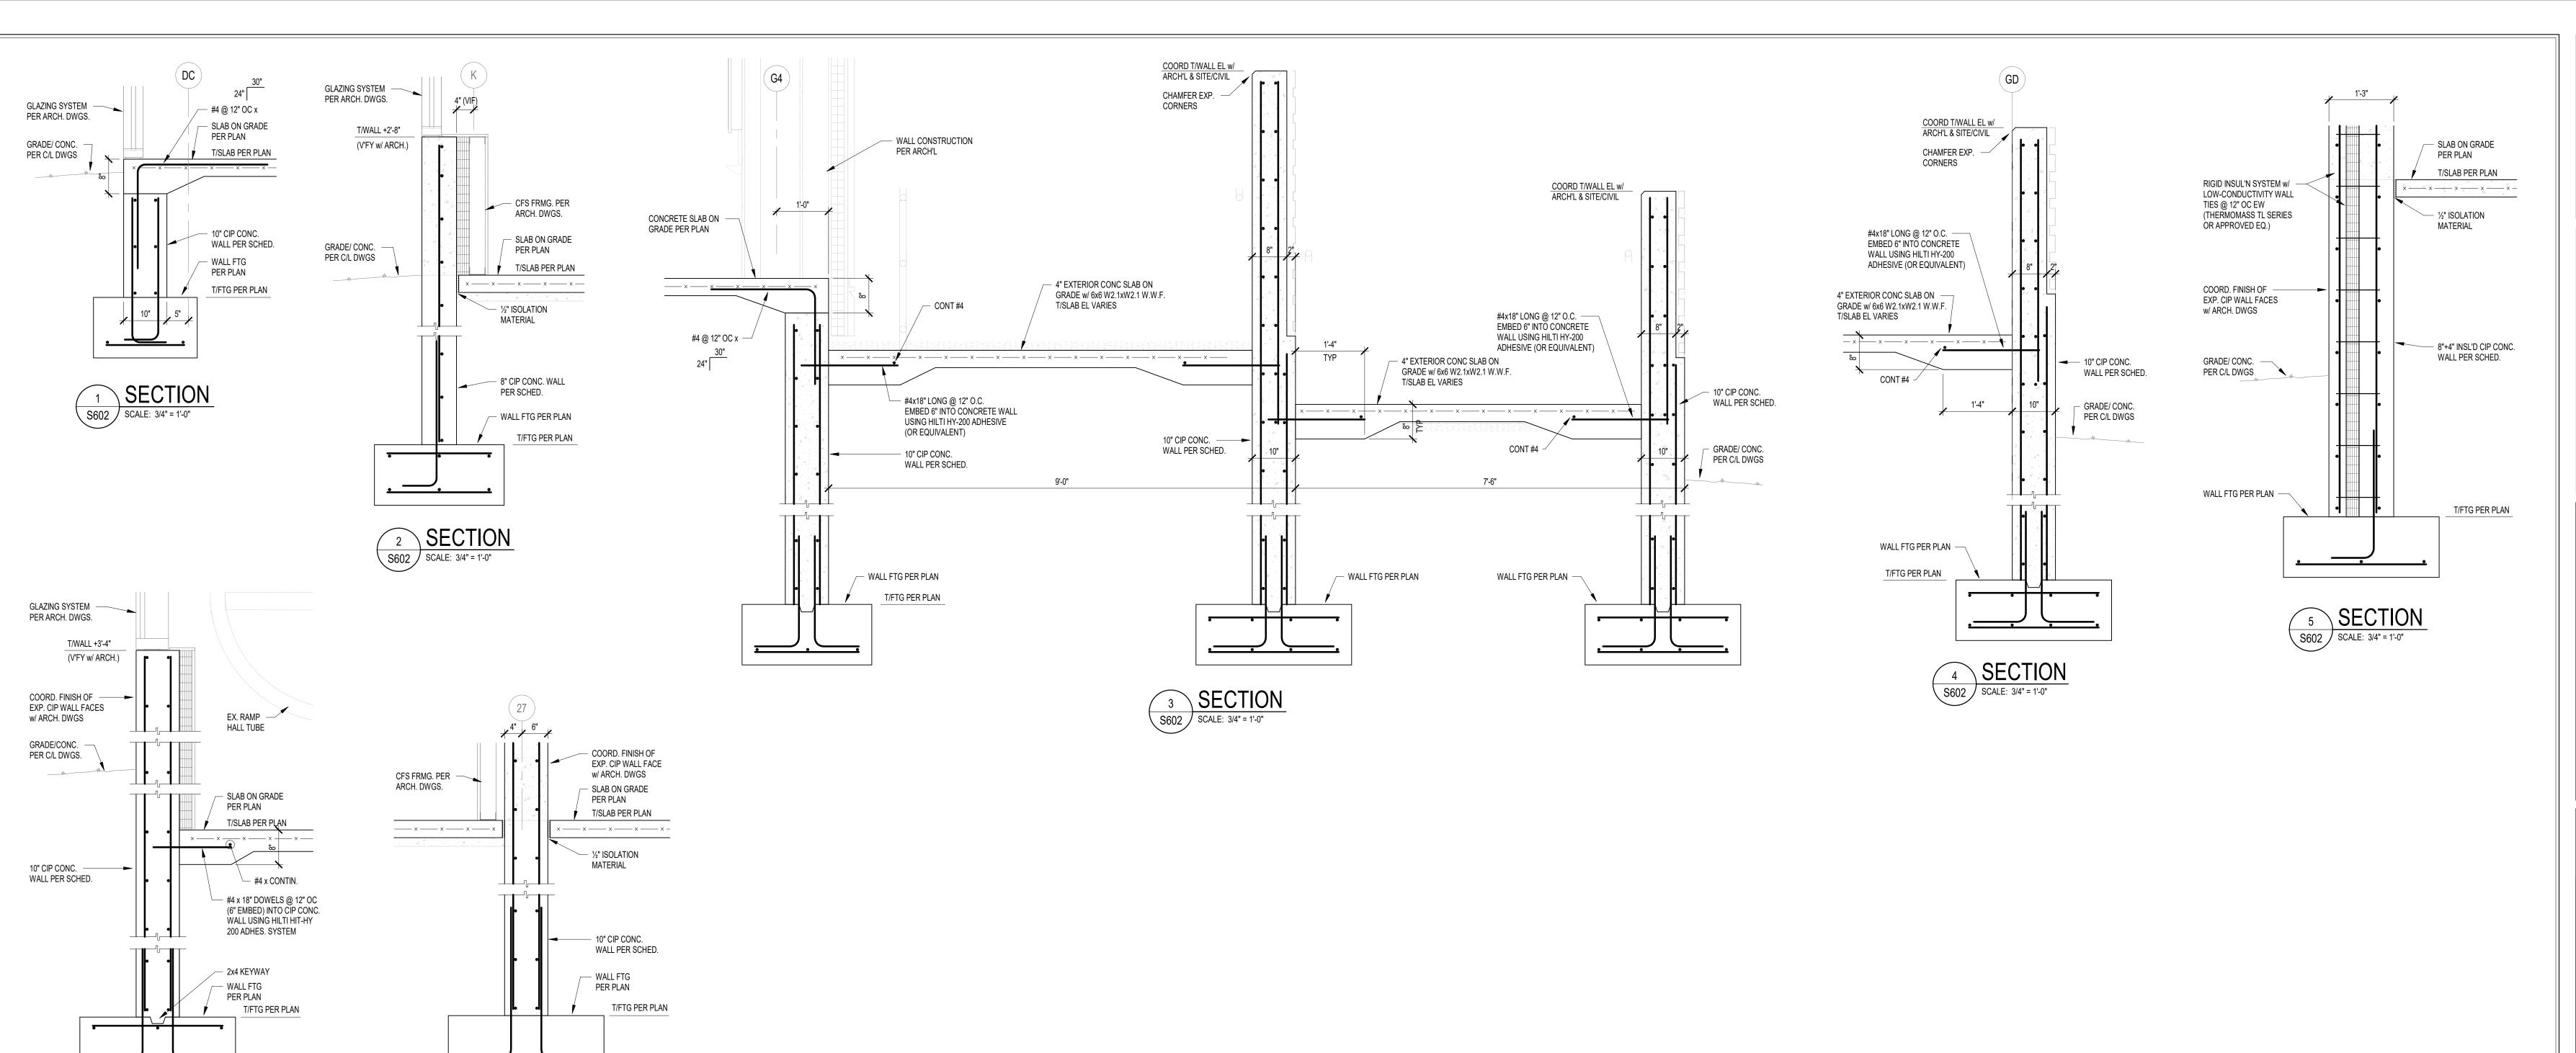

7 SECTION S602 SCALE: 3/4" = 1'-0"

6 SECTION

S602 SCALE: 3/4" = 1'-0"

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S831 Keystone Crossing, Indianapolis, IN 4624

Eynch,
Harrison &
Harrison &
Brumleve,
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550 Virginia Avenue
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Indianapolis, IN 46203
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BARTHOLOMEW CONSOLIDATED
SCHOOL CORPORATION
RENOVATIONS AND ADDITIONS TO
L. FRANCES SMITH ELEMENTARY

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PE19400114

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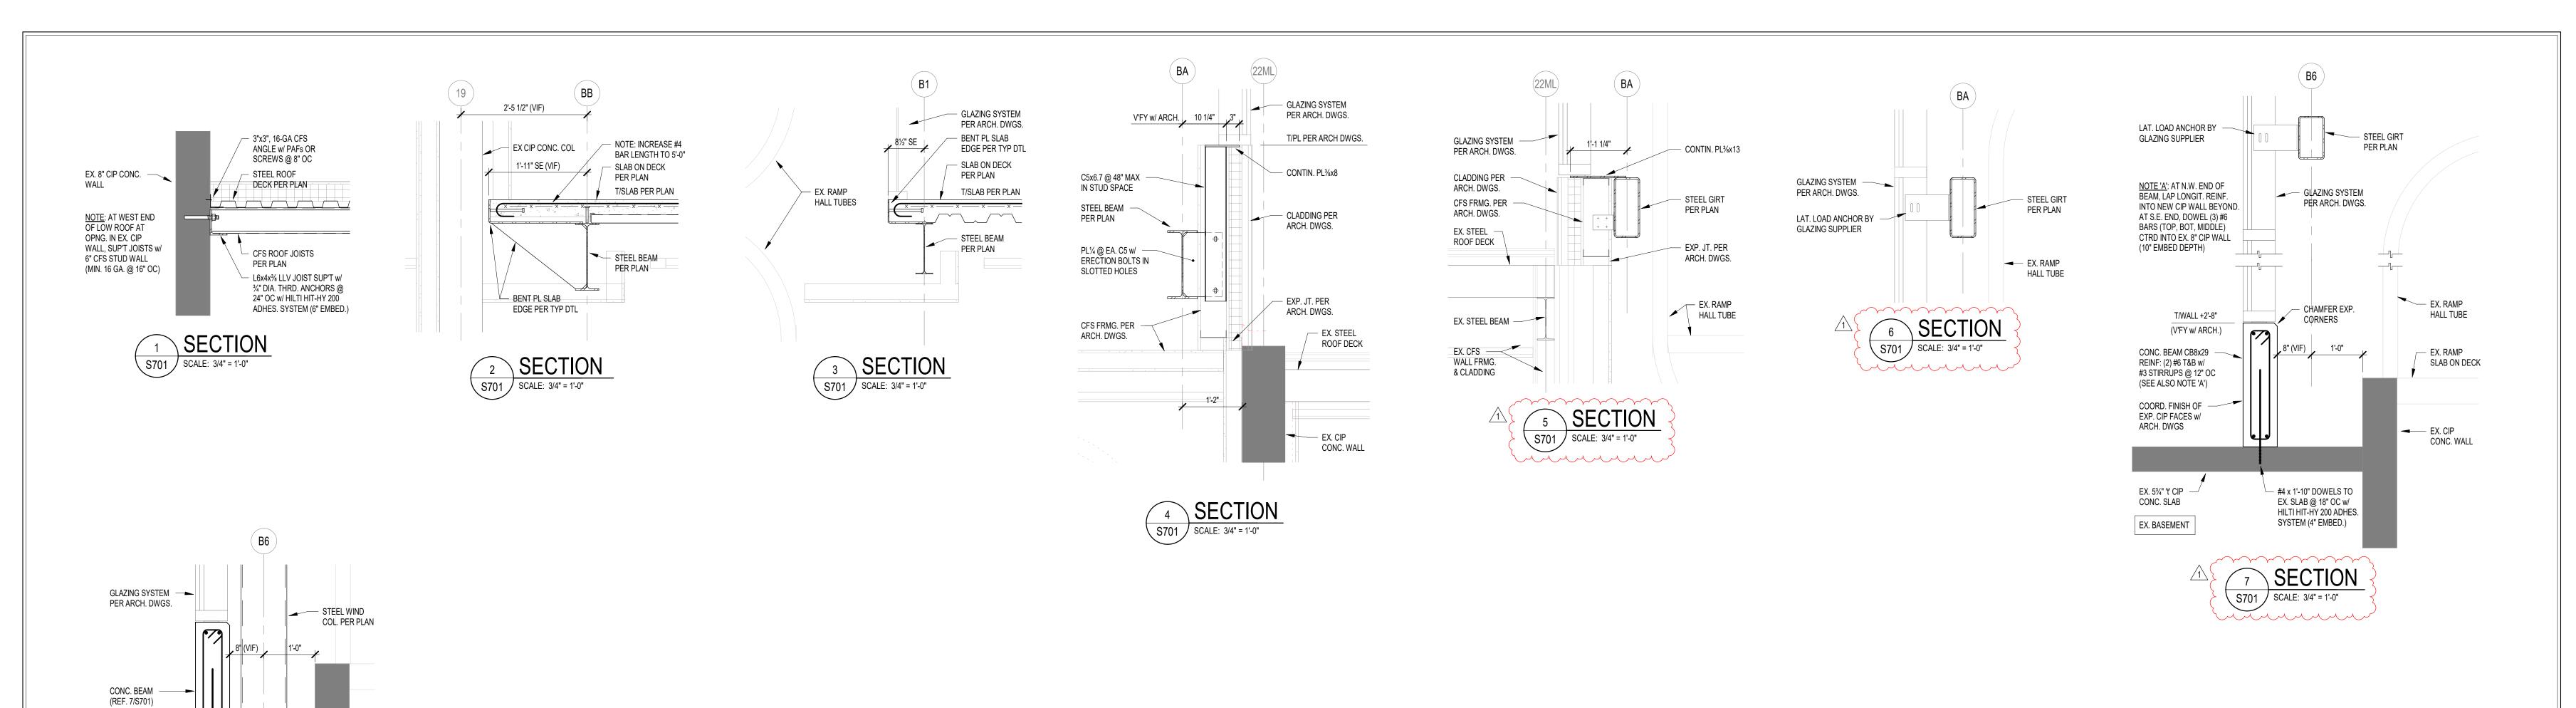
STATE OF

ANDIANA

ONAL ENGLISH

INTERIOR

S602



EX. 5¾" 't' CIP CONC. SLAB

EX. BASEMENT

S701 SCALE: 3/4" = 1'-0"

BASE PL1x14x1'-2 w/ (4) ¾"x5" SIMPSON TITEN HD ANCHORS

EX. CIP CONC. WALL

8 WIND COL. BASE DETAIL



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Eynch, Harrison & Harrison & Brumleve, Inc. 550 Virginia Avenue P 317.423.1550 Indianapolis, IN 46203 F 317.423.1551

BARTHOLOMEW CONSOLIDATED
SCHOOL CORPORATION
RENOVATIONS AND ADDITIONS TO
L. FRANCES SMITH ELEMENTARY
4505 WAYCROSS DRIVE, COLUMBUS, IN 47201

SCOPE DRAWINGS:


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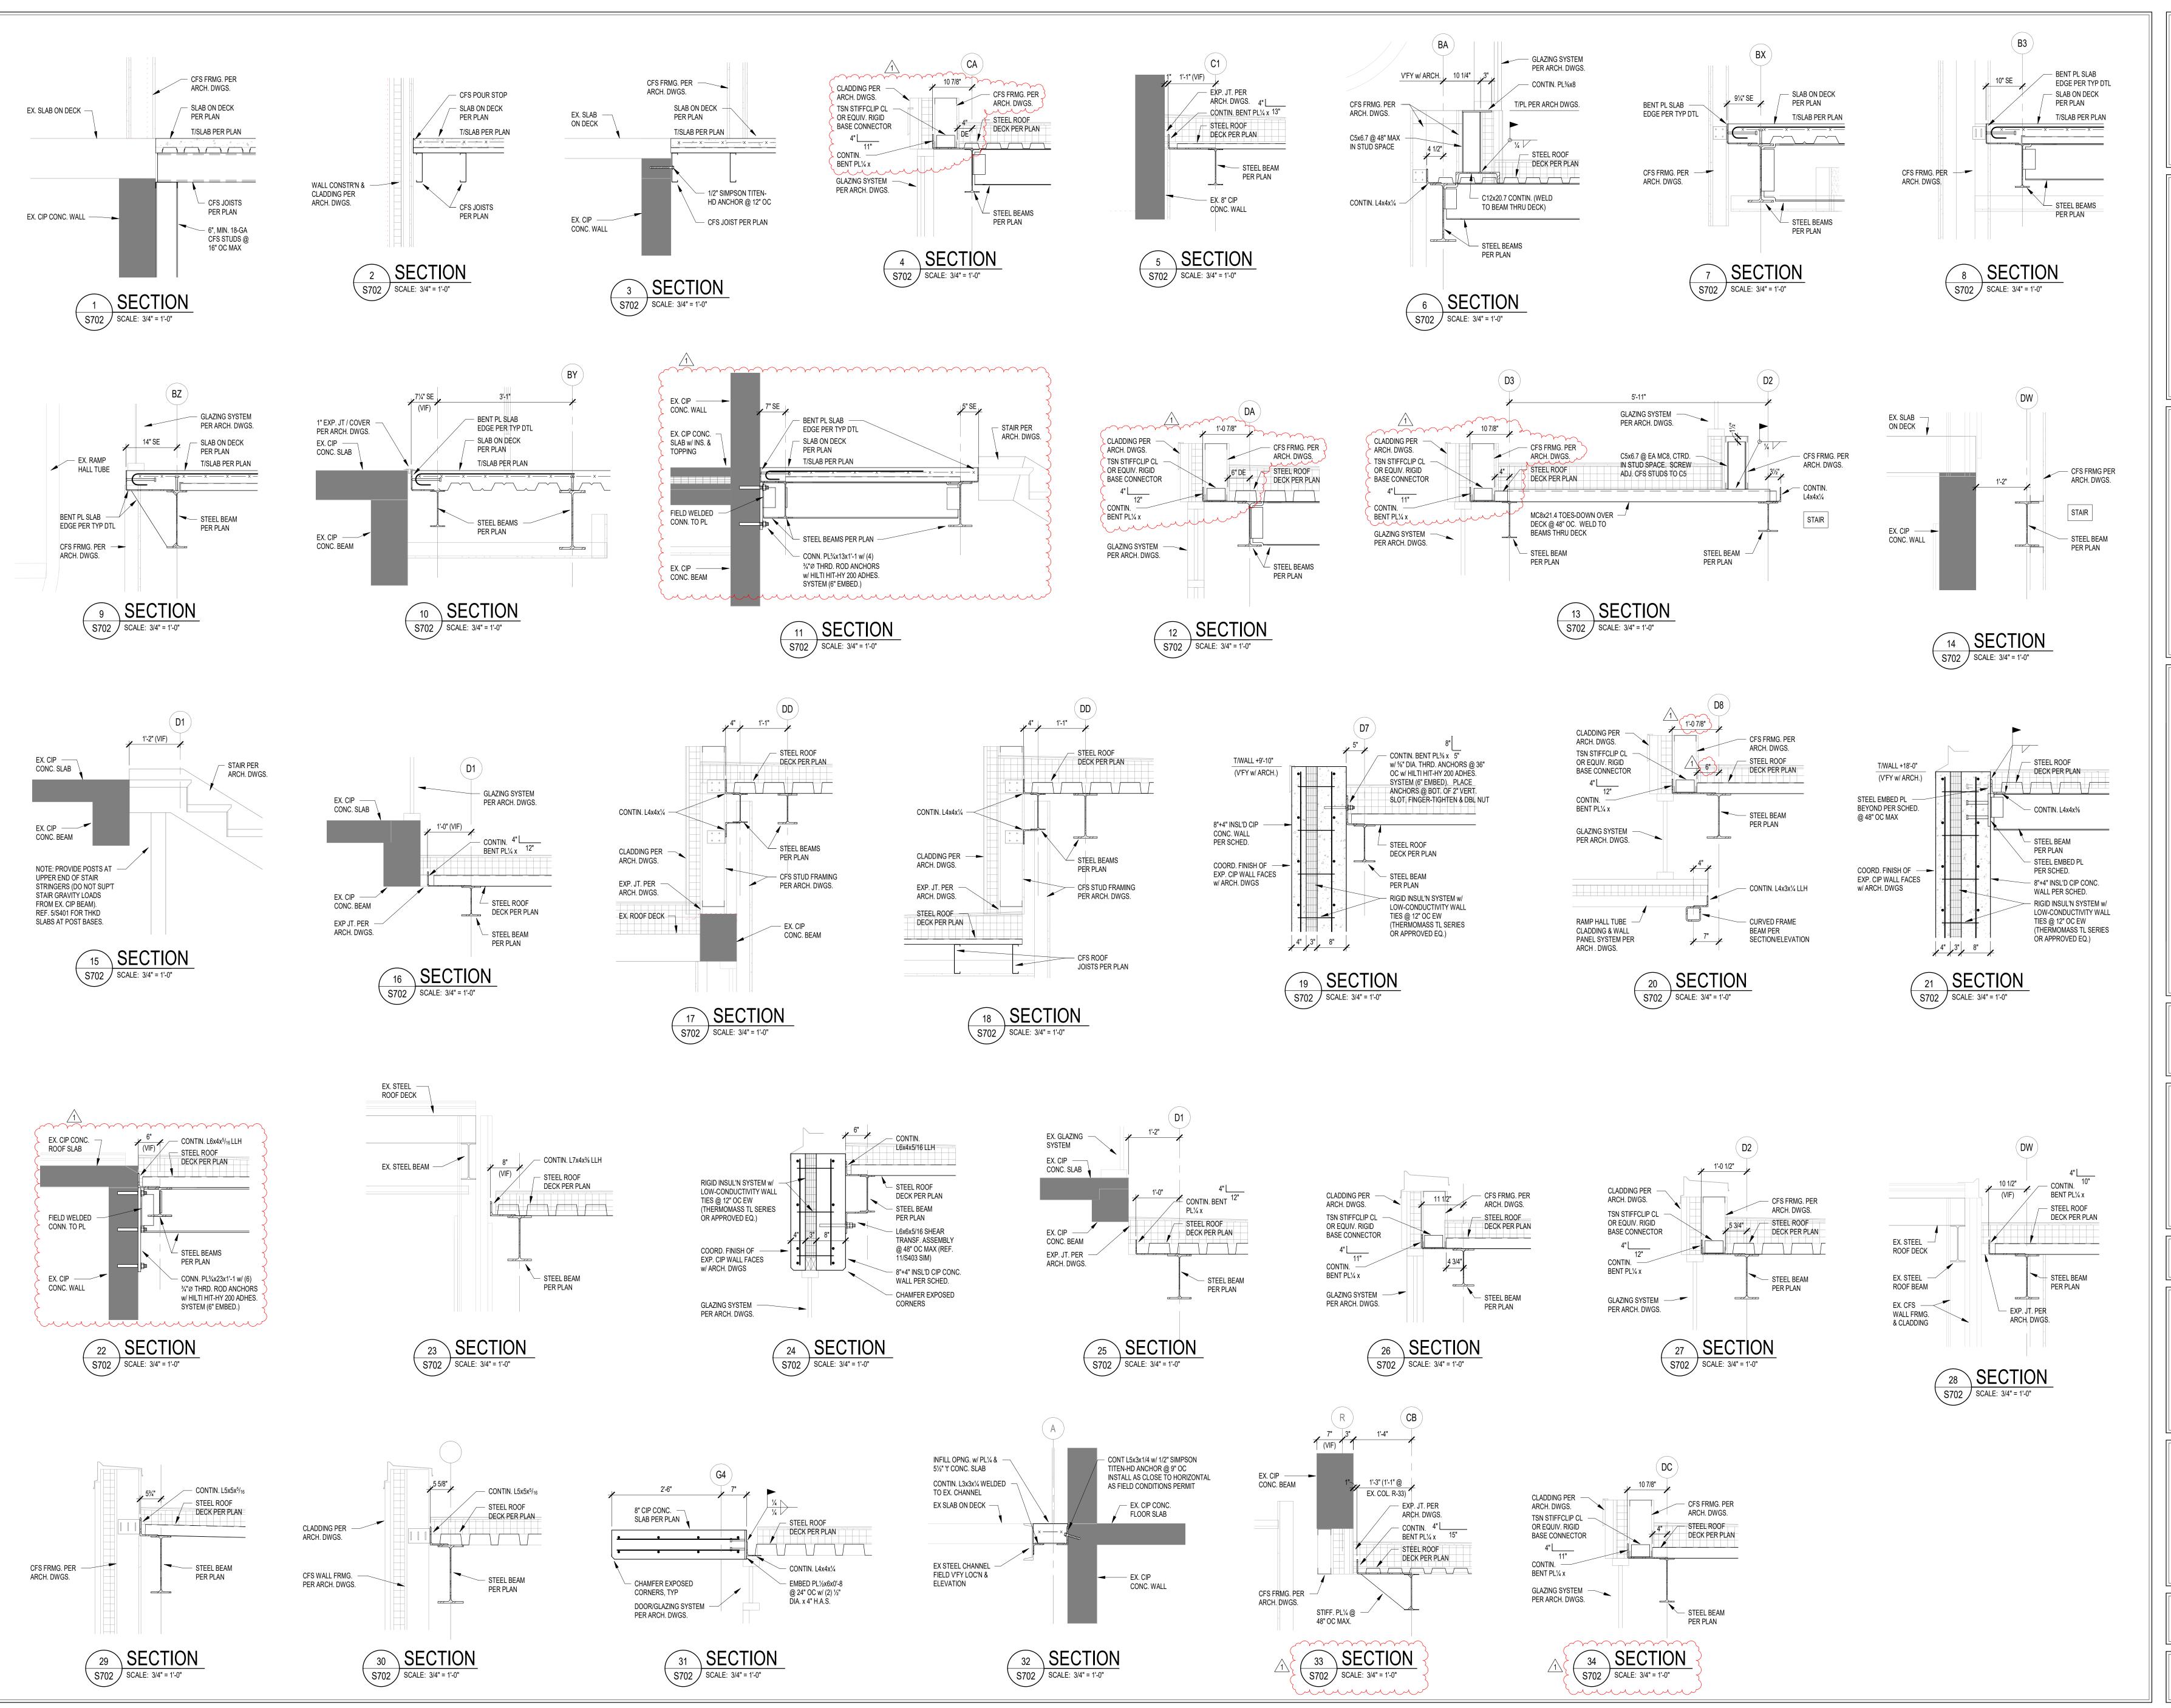
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FRAMING SECTIONS AND DETAILS



S701



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BARTHOLOMEW CONSOLIDATED
SCHOOL CORPORATION
RENOVATIONS AND ADDITIONS TO
L. FRANCES SMITH ELEMENTARY
4505 WAYCROSS DRIVE, COLUMBUS, IN 47201
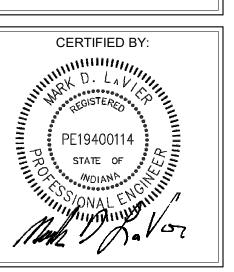
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FRAMING
SECTIONS AND
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CERTIFIED BY:

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PE19400114


STATE OF

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WOJANA

STATE OF

DRAWING NUMBER S702

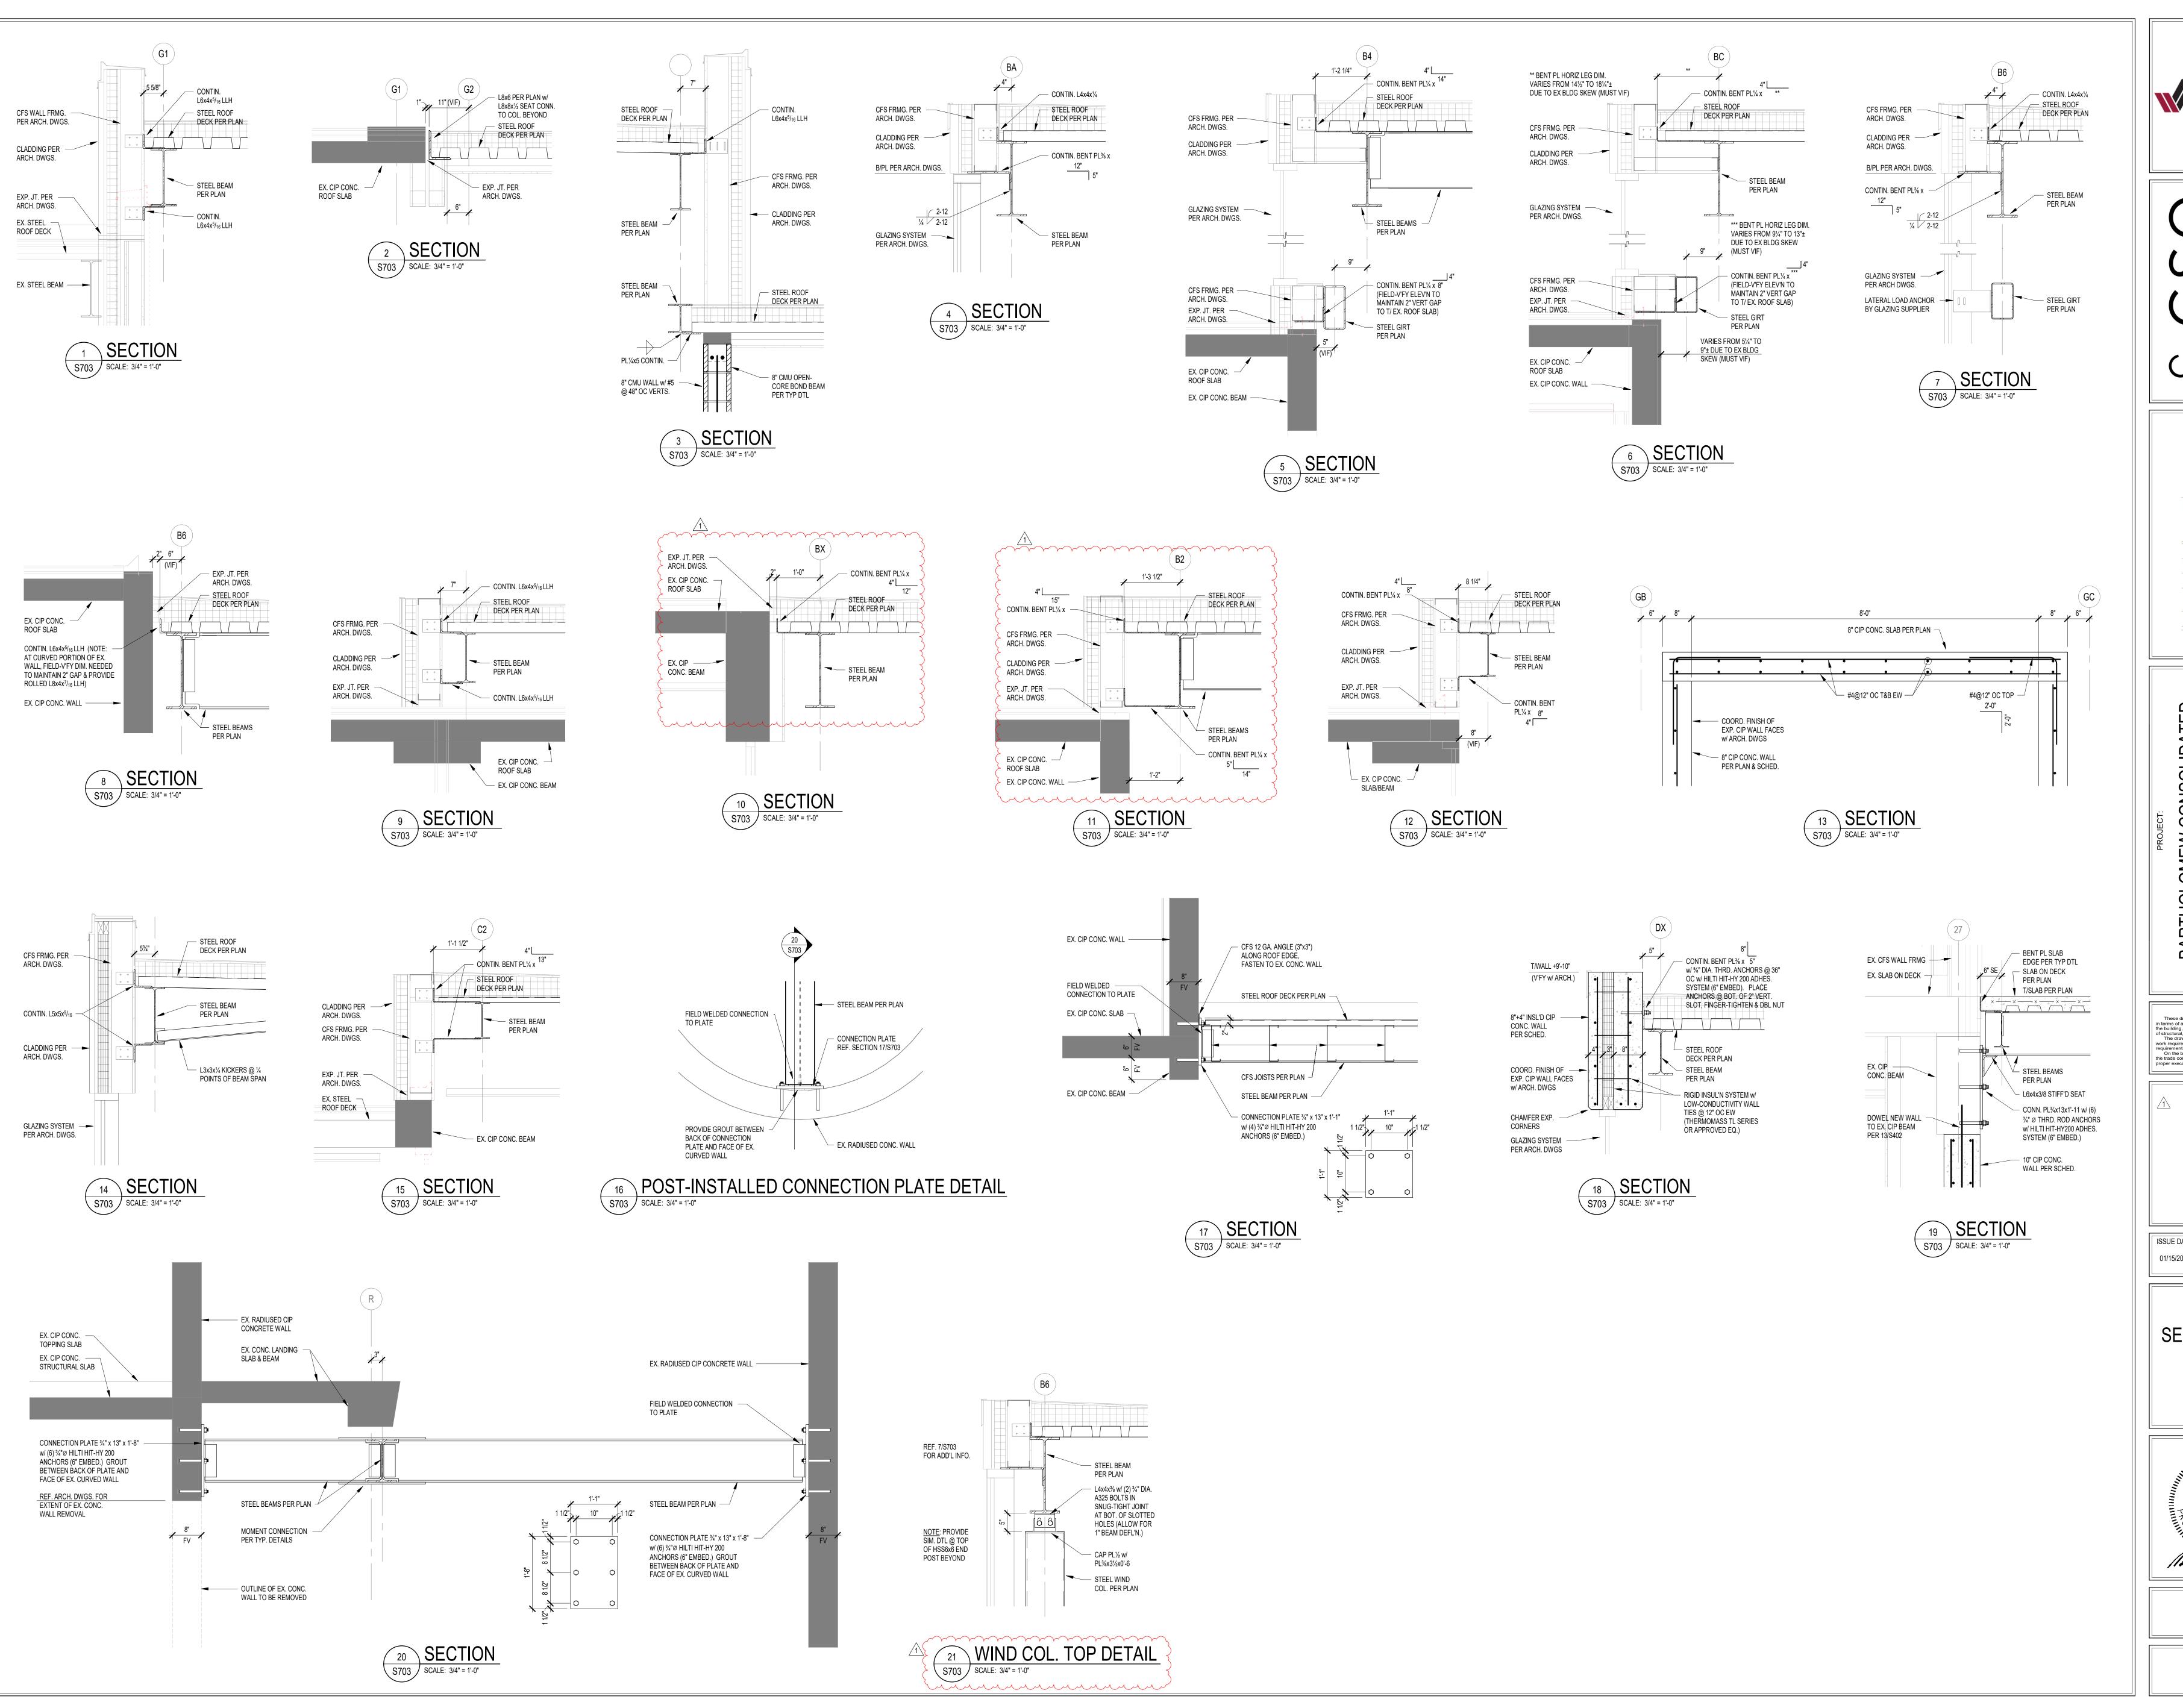

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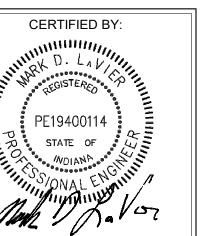
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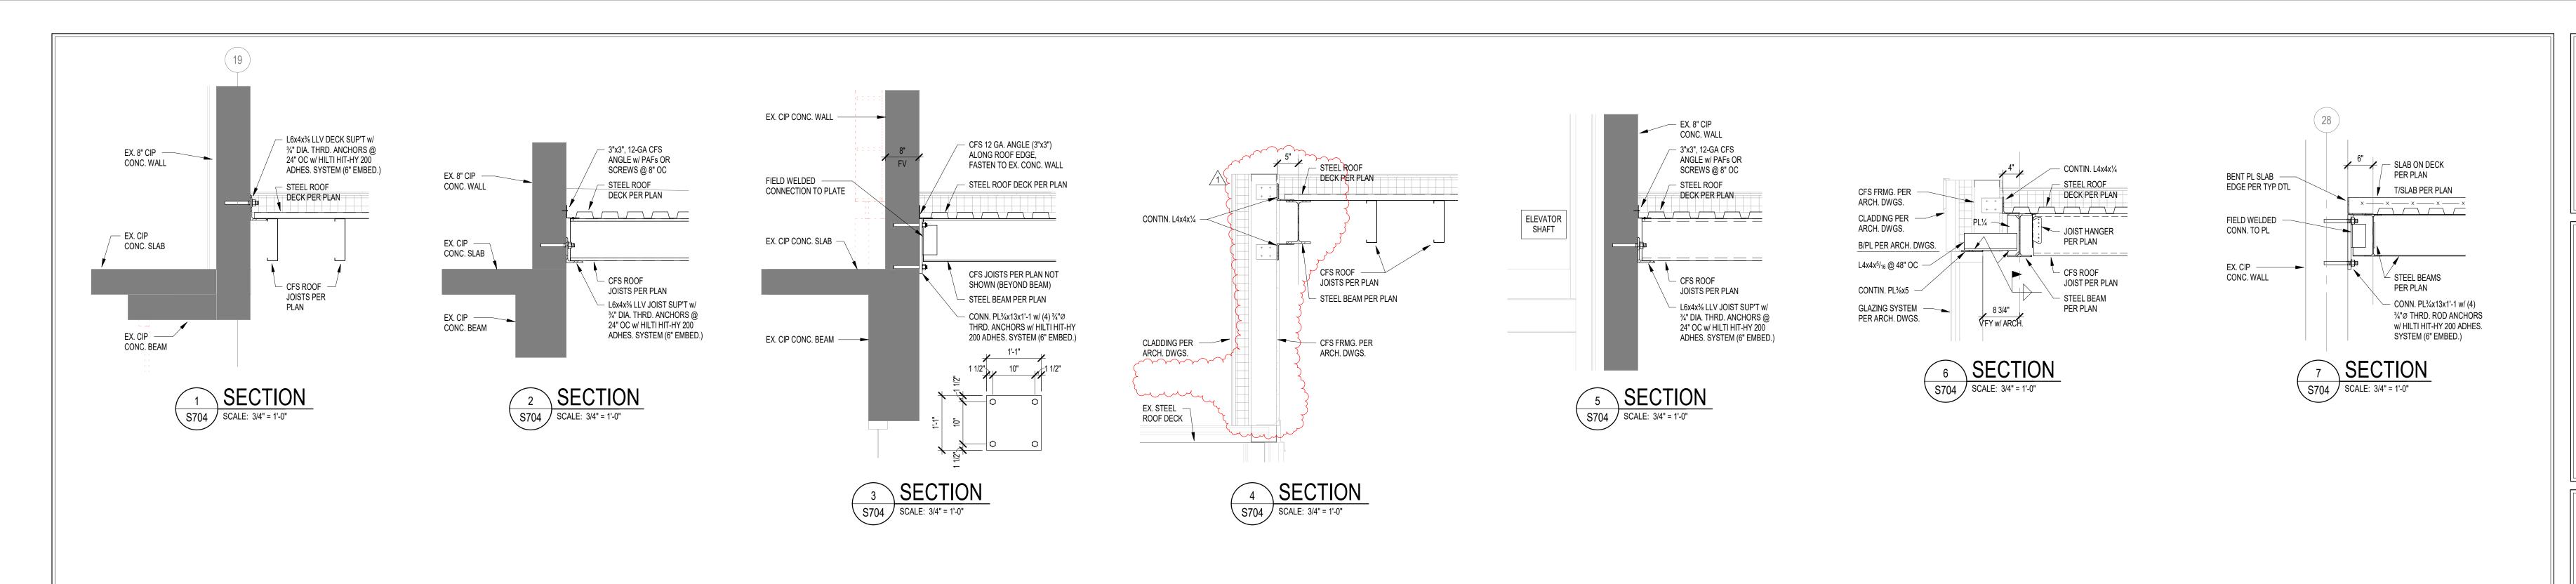
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FRAMING SECTIONS AND DETAILS



S703



CONTIN. L4x4x%

STEEL ROOF

DECK PER PLAN

STEEL BEAMPER PLAN

8 SECTION S704 SCALE: 3/4" = 1'-0"

- CONN. PL%x13x1'-1 w/ (4) %"Ø THRD. ANCHORS w/ HILTI HIT-HY 200 ADHES. SYSTEM (6" EMBED.)

FIELD WELDED -CONN. TO PL

EX. CIP — — — CONC. COL.



SCHOOL CORPORATION
SCHOOL CORPORATION
SENOVATIONS AND ADDITIONS
- FRANCES SMITH ELEMENT
4505 WAYCROSS DRIVE, COLUMBUS, IN

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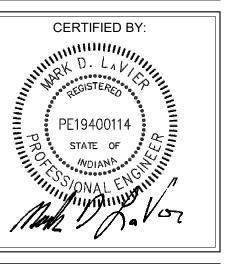
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On the basis of the general scope indicated or described, the trade contractors shall furnish all items required for the proper execution and completion of the work.


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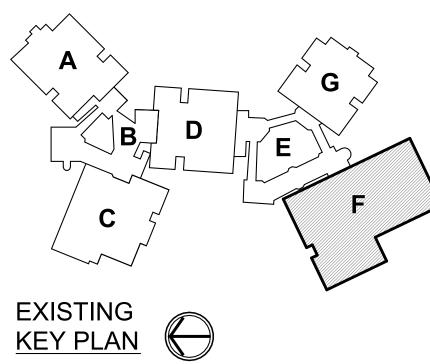
FRAMING
ECTIONS AND
DETAILS



S704





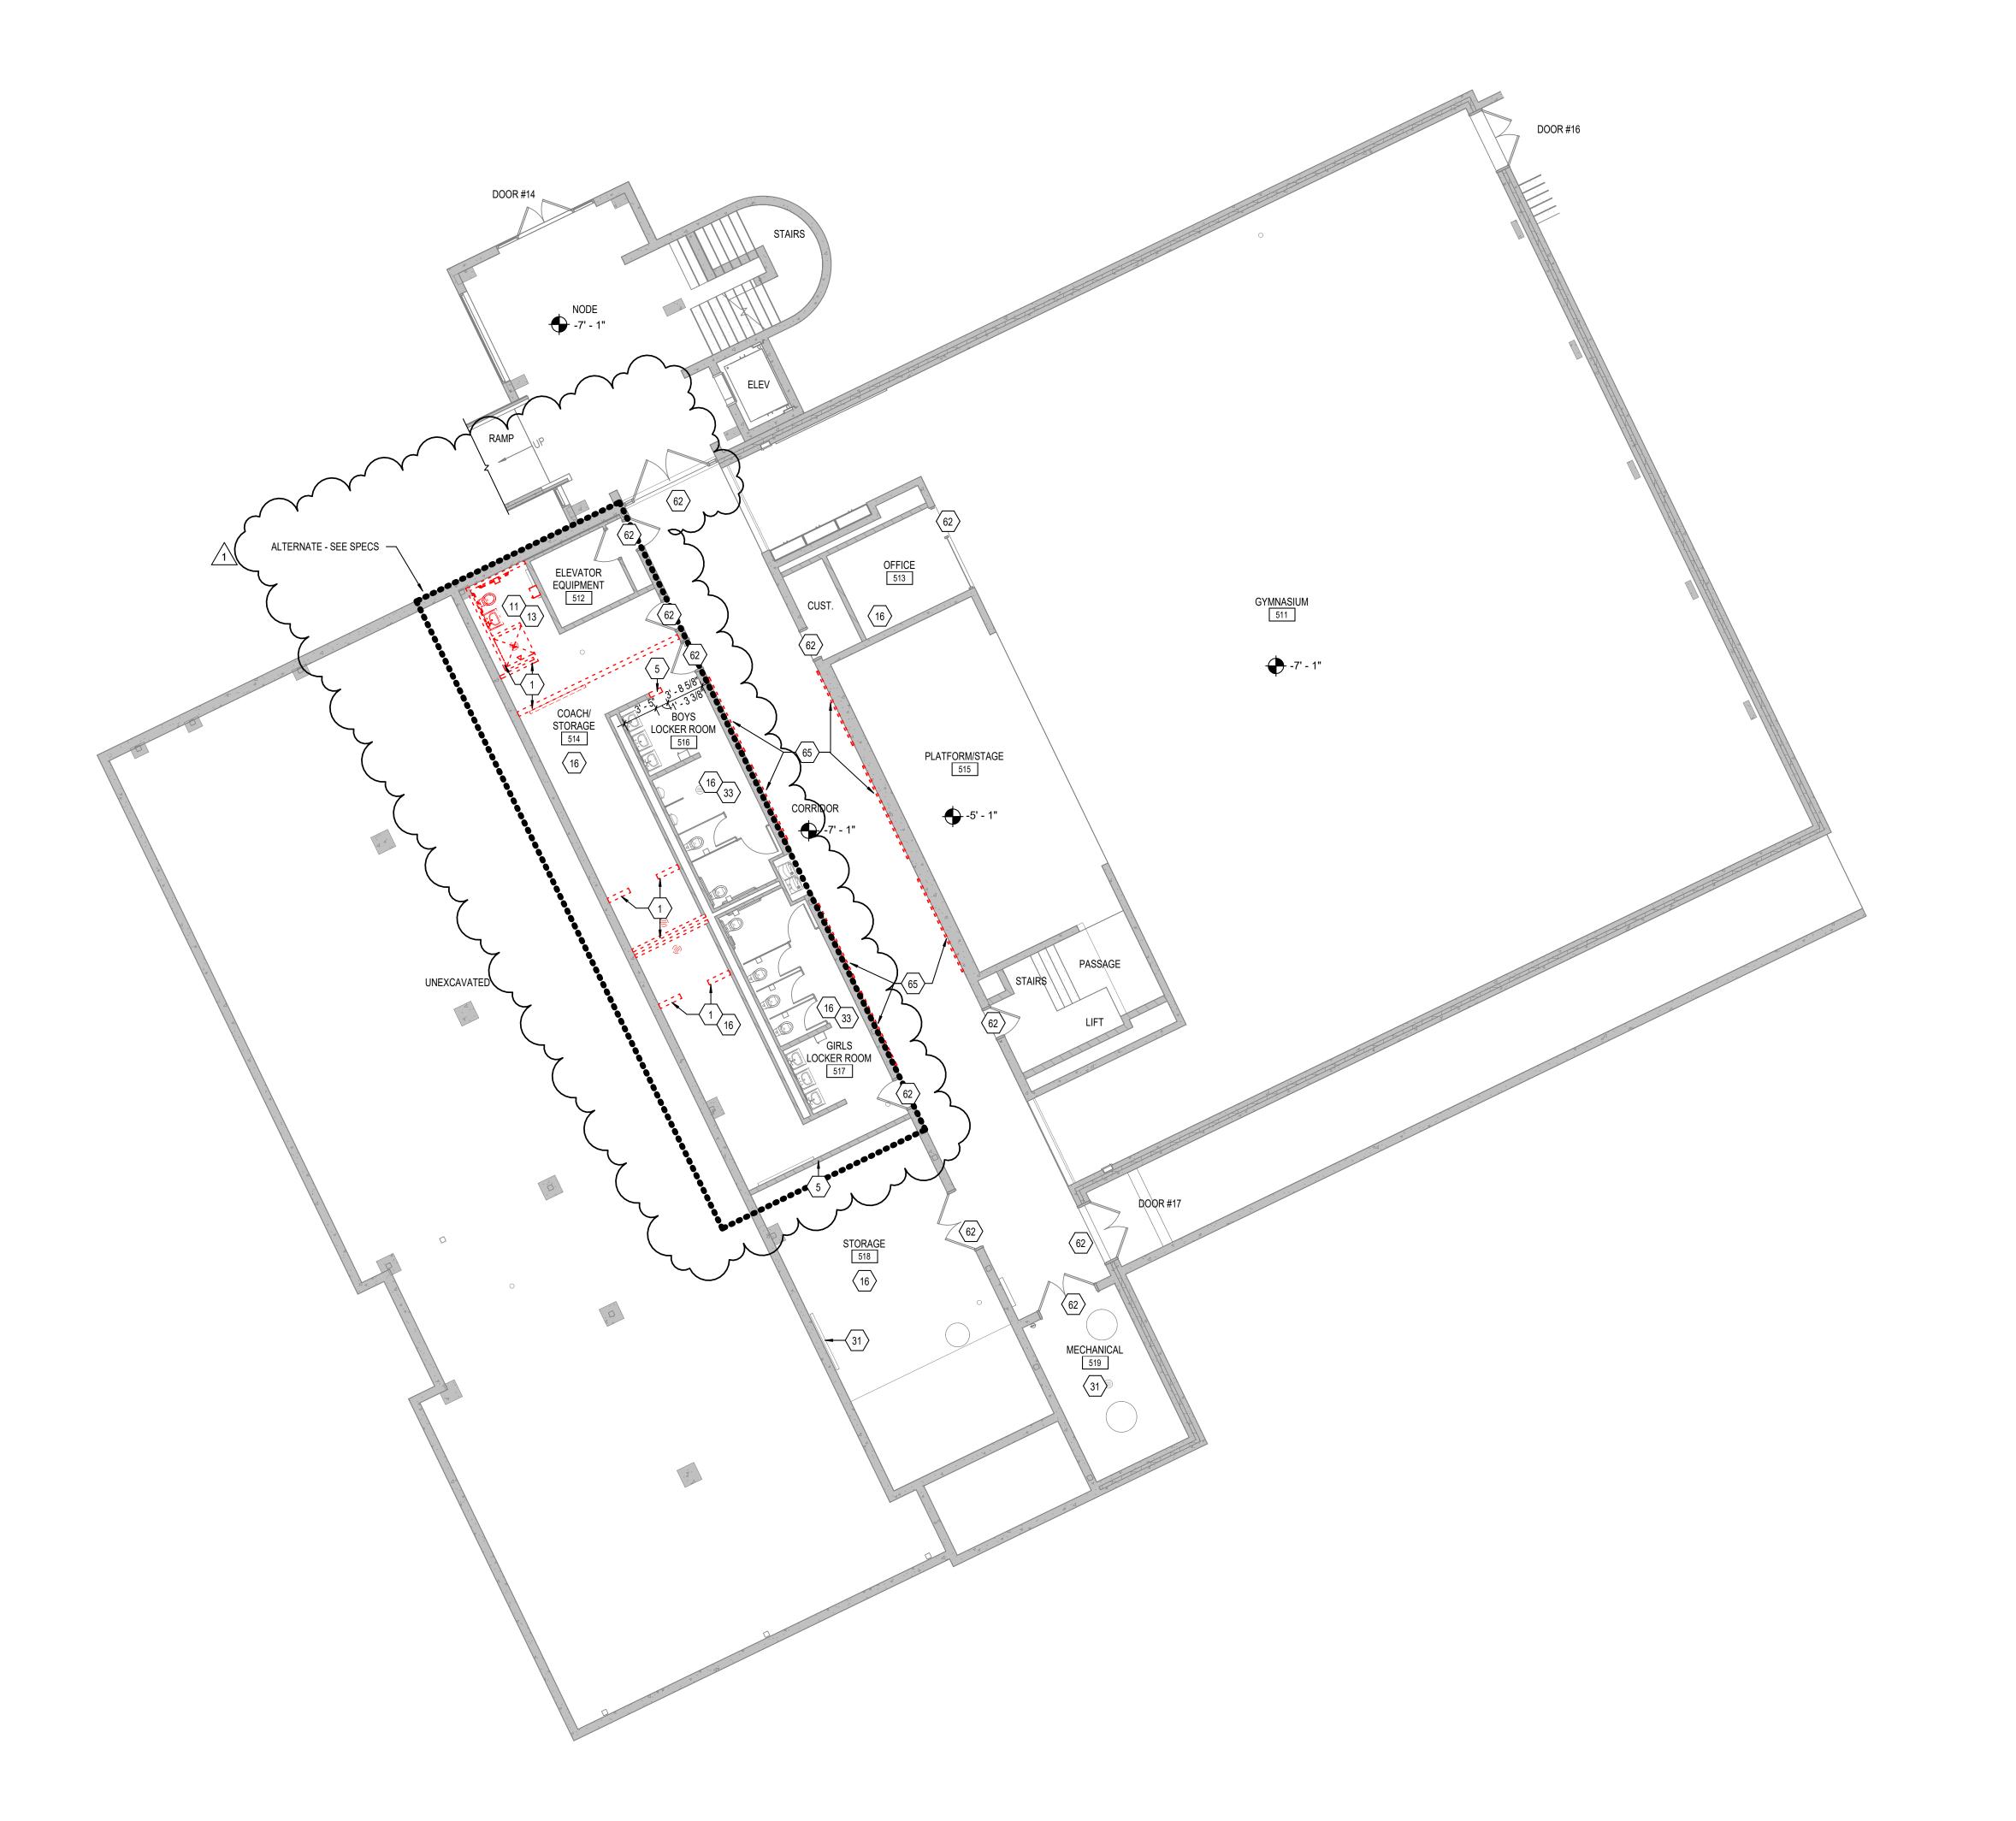

***** KEYED DEMOLITION NOTES

- REMOVE CONCRETE / MASONRY WALL AS REQUIRED / INDICATED FOR NEW WORK. REMOVE METAL STUD AND GYPSUM BOARD WALL CONSTRUCTION AS REQUIRED / INDICATED FOR NEW WORK.
- REMOVE WOOD STUD AND PLASTER AND LATH WALL CONSTRUCTION AS REQUIRED INDICATED FOR NEW WORK.
- 4 REMOVE PORTION OF EXISTING CAST-IN-PLACE CONCRETE WALL AND FURRED STUD WALL AS REQUIRED / INDICATED FOR INSTALLATION OF NEW BORROWED LITE IN
- HOLLOW METAL FRAME.. REMOVE PORTION OF CONCRETE MASONRY UNIT AND FURRED STUD WALL AS
- REQUIRED / INDICATED FOR INSTALLATION OF NEW DOOR AND / OR BORROWED LITE REMOVE EXISTING CAST-IN-PLACE CONCRETE CONSTRUCTION AS REQUIRED /
- INDICATED FOR INSTALLATION OF NEW WORK REMOVE DOOR AND HOLLOW METAL FRAME COMPLETE, INCLUDING HARDWARE,
- TRANSOM PANELS, SIDELITES, ANCHORS, GLAZING, ETC. 8 REMOVE DOOR(S) AND HARDWARE COMPLETE PATCH AND REPAIR EXISTING HOLLOW
- METAL FRAME TO LIKE-NEW CONDITION AND PREPARE OPENING TO RECEIVE NEW DOOR AND HARDWARE AS SCHEDULED. REMOVE DOOR AND STOREFRONT / CURTAINWALL FRAMING SYSTEM COMPLETE AND
- PREPARE OPENING TO RECEIVE NEW WORK WHERE APPLICABLE. 10 REMOVE STOREFRONT / CURTAINWALL FRAMING SYSTEM COMPLETE WHERE
- APPLICABLE AND PREPARE OPENING TO RECEIVE NEW WORK. 1 REMOVE PLUMBING FIXTURE(S) COMPLETE. COORDINATE WITH PLUMBING DRAWINGS.
- (SEE PLUMBING DRAWINGS FOR REUSE / RELOCATION / REINSTALLATION OF EXISTING 'NEWER' WATER COOLERS). 12 REMOVE ALL TOILET PARTITIONS / URINAL SCREENS COMPLETE, INCLUDING ANCHORS,
- HARDWARE, ACCESSORIES, ETC.
- 13 REMOVE ALL TOILET ACCESSORIES IN THIS ROOM COMPLETE. PATCH AND PREPARE AS REQUIRED / INDICATED FOR NEW WORK. 14 CAREFULLY REMOVE, STORE, AND PROTECT EXISTING CASEWORK FOR REUSE.
- REINSTALL IN NEW WORK (TYPICAL CLASSROOM CASEWORK CUBBIES AND STORAGE CABINETS) AS INDICATED IN NEW CONSTRUCTION DRAWINGS. PATCH AND REPAIR DAMAGED WALL, FLOOR AND CEILING FINISHES AS REQUIRED TO RECEIVE NEW
- 15 EXISTING CASEWORK TO REMAIN PROTECT AS REQUIRED DURING CONSTRUCTION. 16 REMOVE FLOORING, BASE FINISHES, AND ADHESIVES COMPLETELY. PATCH AND PREPARE SURFACES AS REQUIRED / INDICATED FOR NEW FINISHES
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- 19 CAREFULLY REMOVE VISUAL DISPLAY SURFACES INCLUDING MARKER BOARDS, TV SCREEN, CHALKBOARDS, TACKBOARDS, AND ALL ANCHORS / ADHESIVES COMPLETE. PATCH AND PREPARE EXISTING WALL SURFACES TO REMAIN AS REQUIRED FOR NEW WORK. SALVAGE, STORE AND REINSTALL EXISTING DISPLAY BOARDS INDICATED AS
- 'RELOCATED' PER TYPE AND SIZE AS LISTED ON A900 SERIES SHEETS. 20 REMOVE SMARTBOARDS INCLUDING ALL ACCESSORIES, ANCHORS / ADHESIVES COMPLETE. PATCH AND PREPARE EXISTING DAMAGED SURFACES FOR NEW WORK AS
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- 22 SEE ELECTRICAL DRAWINGS FOR NEW AND EXISTING ELECTRICAL ITEMS TO REMAIN INCLUDING CONDUIT RUN IN WALLS AND WIRE MOLD AS INDICATED IN ELECTRICAL
- 23 REMOVE EXISTING LIGHT FIXTURES, TO BE REPLACED WITH NEW LIGHT FIXTURES. SEE
- ELECTRICAL DRAWINGS FOR FULL EXTENT OF WORK. 24 PROTECT EXISTING ELECTRICAL PANEL TO REMAIN. SEE ELECTRICAL DRAWINGS. 25 DEMOLISH EXISTING CONCRETE SLAB, PLANT MATERIAL, ROCK, BENCHES, ANY AND ALL HARDSCAPING AND EXTERIOR AMENITIES AT EXISTING EXTERIOR COURTYARD AND
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- 36 REMOVE EXISTING COILING COUNTER DOOR COMPLETE INCLUDING FRAME, SILL, HOOD, BLOCKING, ETC. 37 REMOVE PORTION OF EXISTING CAST-IN-PLACE CONCRETE WALL AS REQUIRED FOR
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A900 SHEETS AND A600 SHEETS FOR ADDITIONAL INFORMATION.

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- 50 CAREFULLY REMOVE, STORE, AND PROTECT EXISTING CONFERENCE ROOM MARKERBOARD CASE FOR REUSE. INSTALL IN NEW WORK AS DIRECTED BY OWNER.
- PATCH AND REPAIR EXISTING DAMAGED WALL AS REQUIRED. 51 REMOVE EXTERIOR CAST IN PLACE CONCRETE STAIR CONSTRUCTION COMPLETE
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- 54 REMOVE EXISTING CHAIN LINK FENCE AND GATE COMPLETE. 55 REMOVE EXISTING CASEWORK. PATCH AND REPAIR DAMAGED WALL, FLOOR AND
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- 57 REMOVE EXISTING MECHANICAL LOUVER, CONCRETE SURROUND AND AREAWAY (WHERE APPLICABLE) AS REQUIRED FOR INSTALLATION OF NEW CONSTRUCTION.
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- 64 REMOVE UPPER PORTION OF TUBE STRUCTURE COMPLETE. LINE OF DEMOLITION TO HAPPEN AT NEW SLAB LOCATION. ABOVE SLAB TO REMOVED; BELOW SLAB TO REMAIN. SEE DETAILS. PATCH AND PREPARE AS REQUIRED / INDICATED FOR NEW WORK. 65 REMOVE EXISTING CORRIDOR, TACKBOARDS INCLUDING ALL ANCHORS / ADHESIVES
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- 69 EXISTING APPLIANCE OR VENDING MACHINE TO BE REMOVED. VERIFY WITH OWNER REUSE OR REMOVAL.
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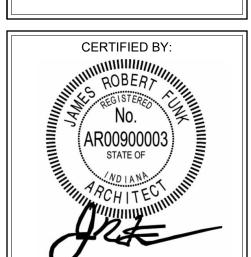
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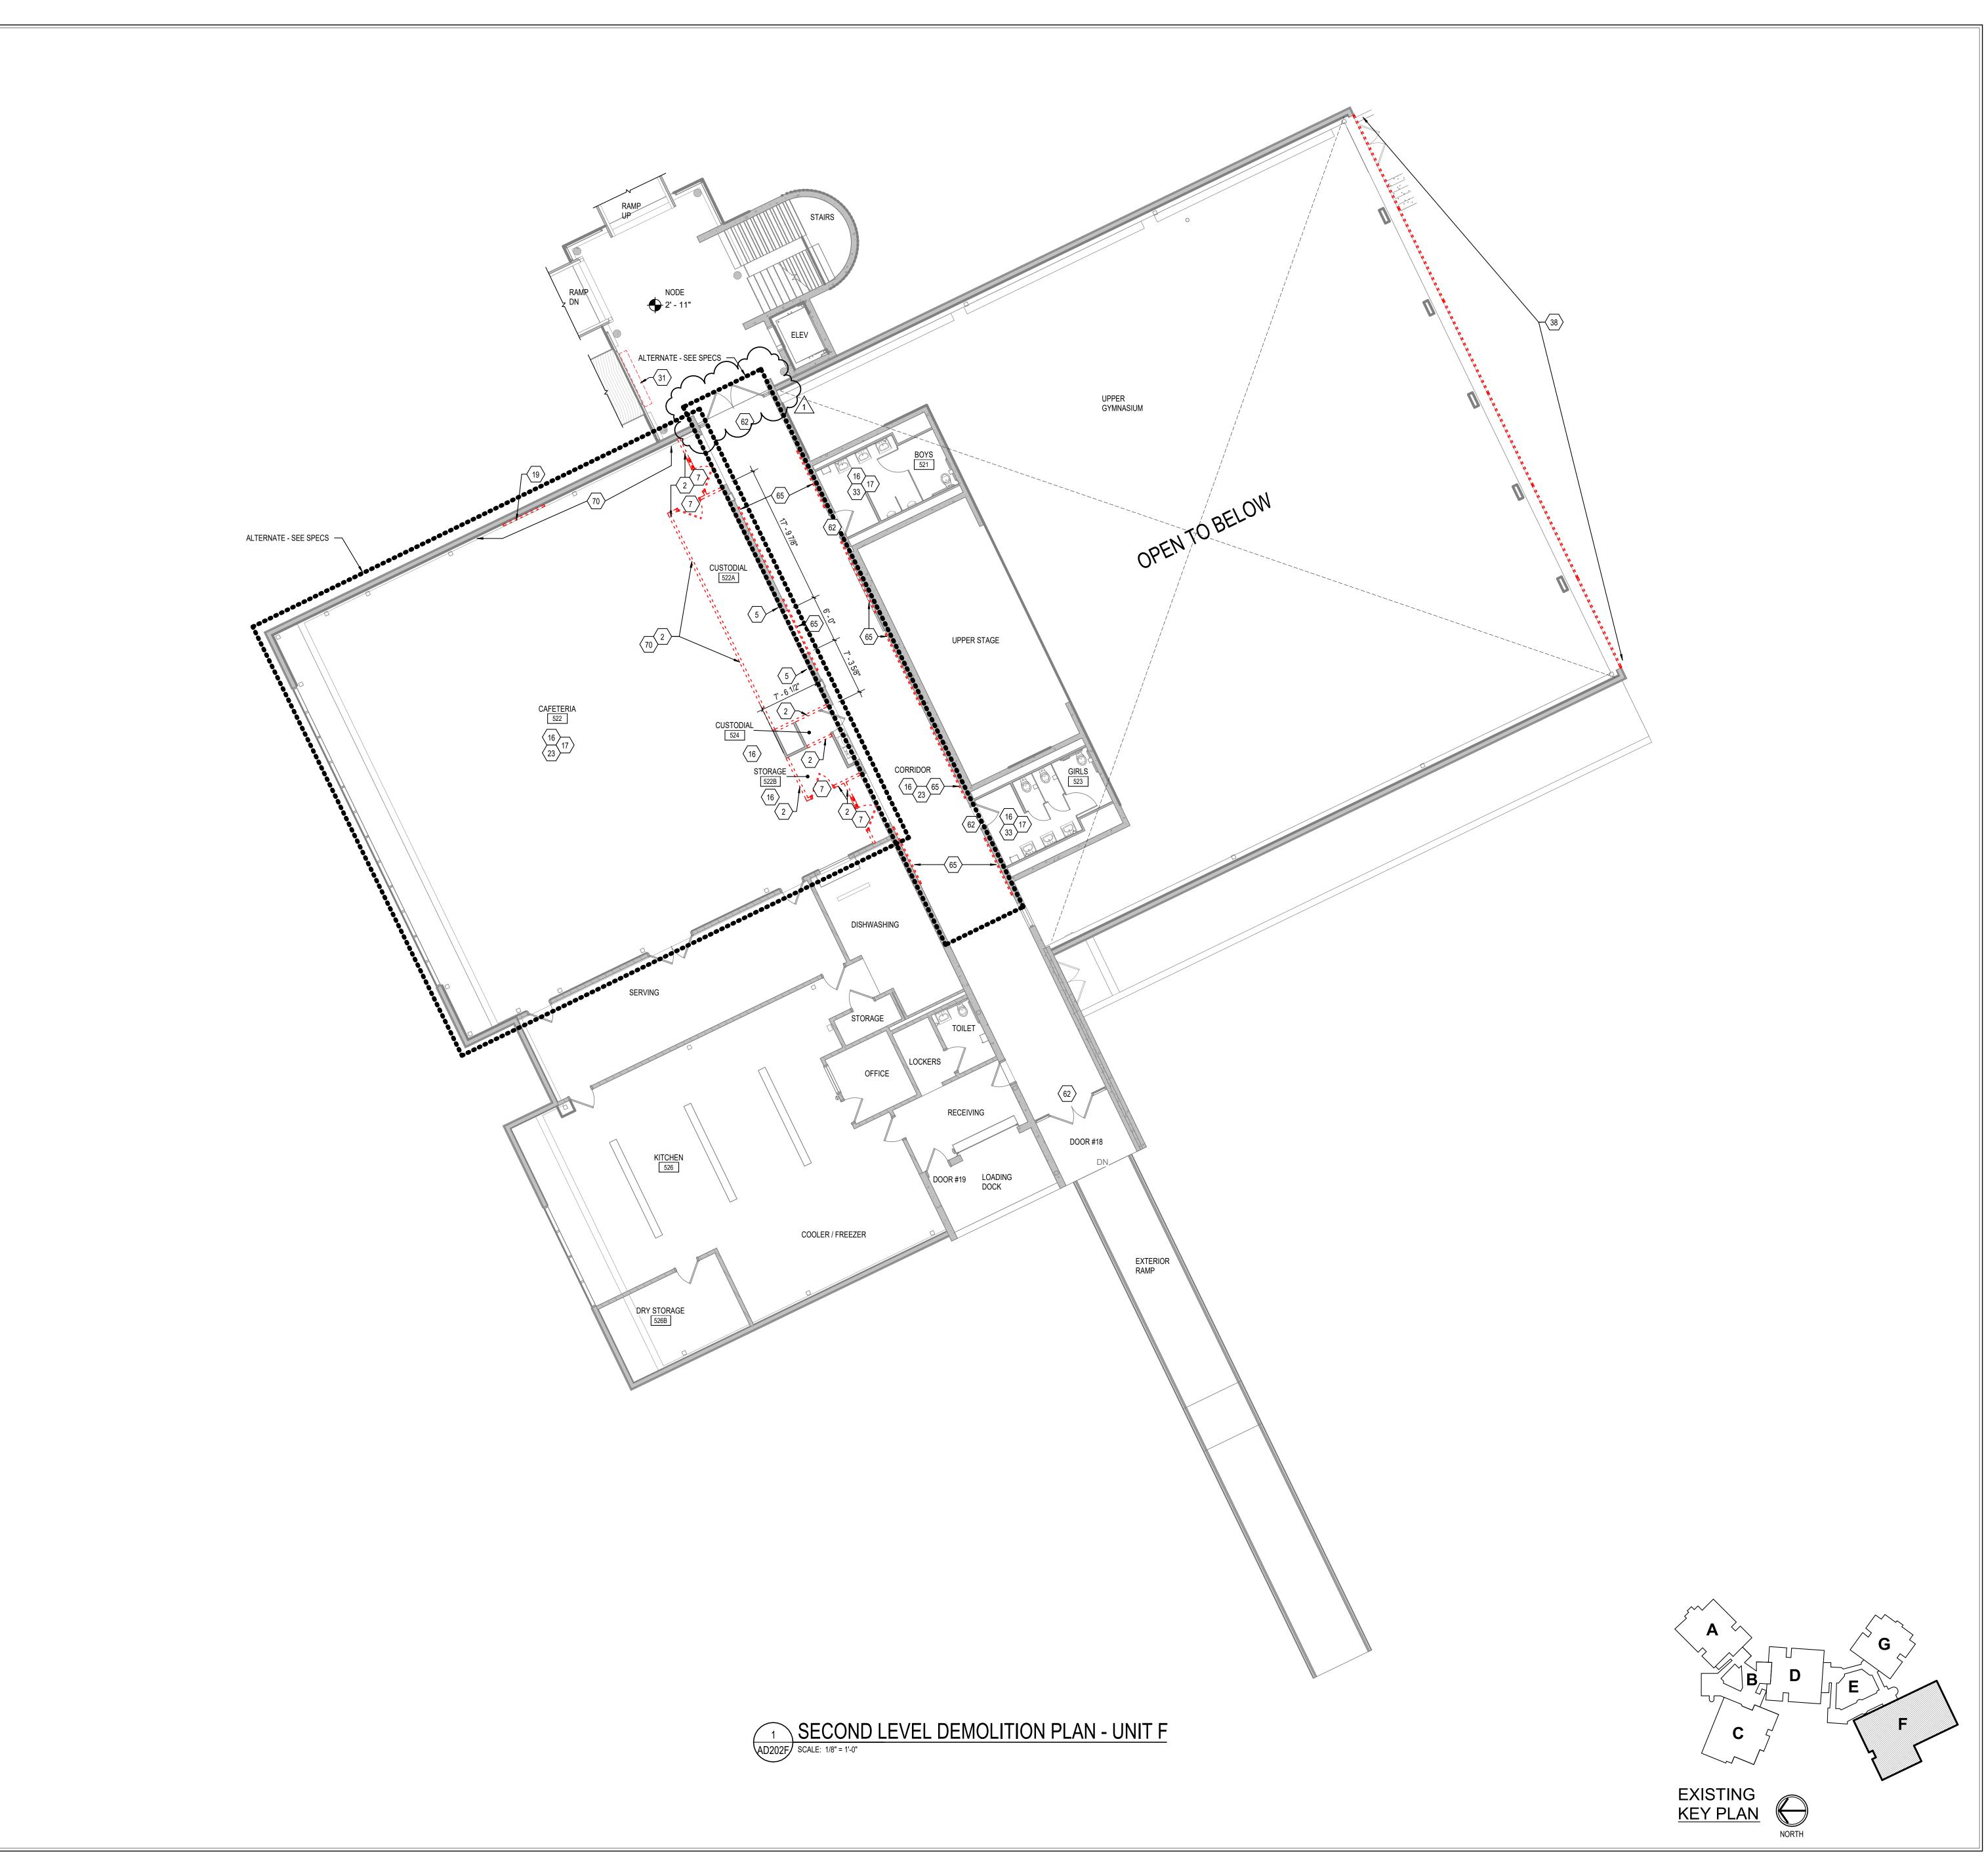
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PLAN - UNIT F

DRAWING TITLE:





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- REMOVE CONCRETE / MASONRY WALL AS REQUIRED / INDICATED FOR NEW WORK. REMOVE METAL STUD AND GYPSUM BOARD WALL CONSTRUCTION AS REQUIRED / INDICATED FOR NEW WORK.
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INSTALL NEW CEILINGS PER REFLECTED CEILING PLAN SHEETS A210A THRU A213B.




SCOPE DRAWINGS: work required for full performance and completion of the requirements of the Contract.


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ADDENDUM #1 01/29/2025

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> DRAWING TITLE: PLAN - UNIT F





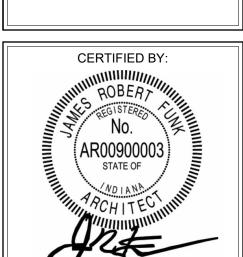

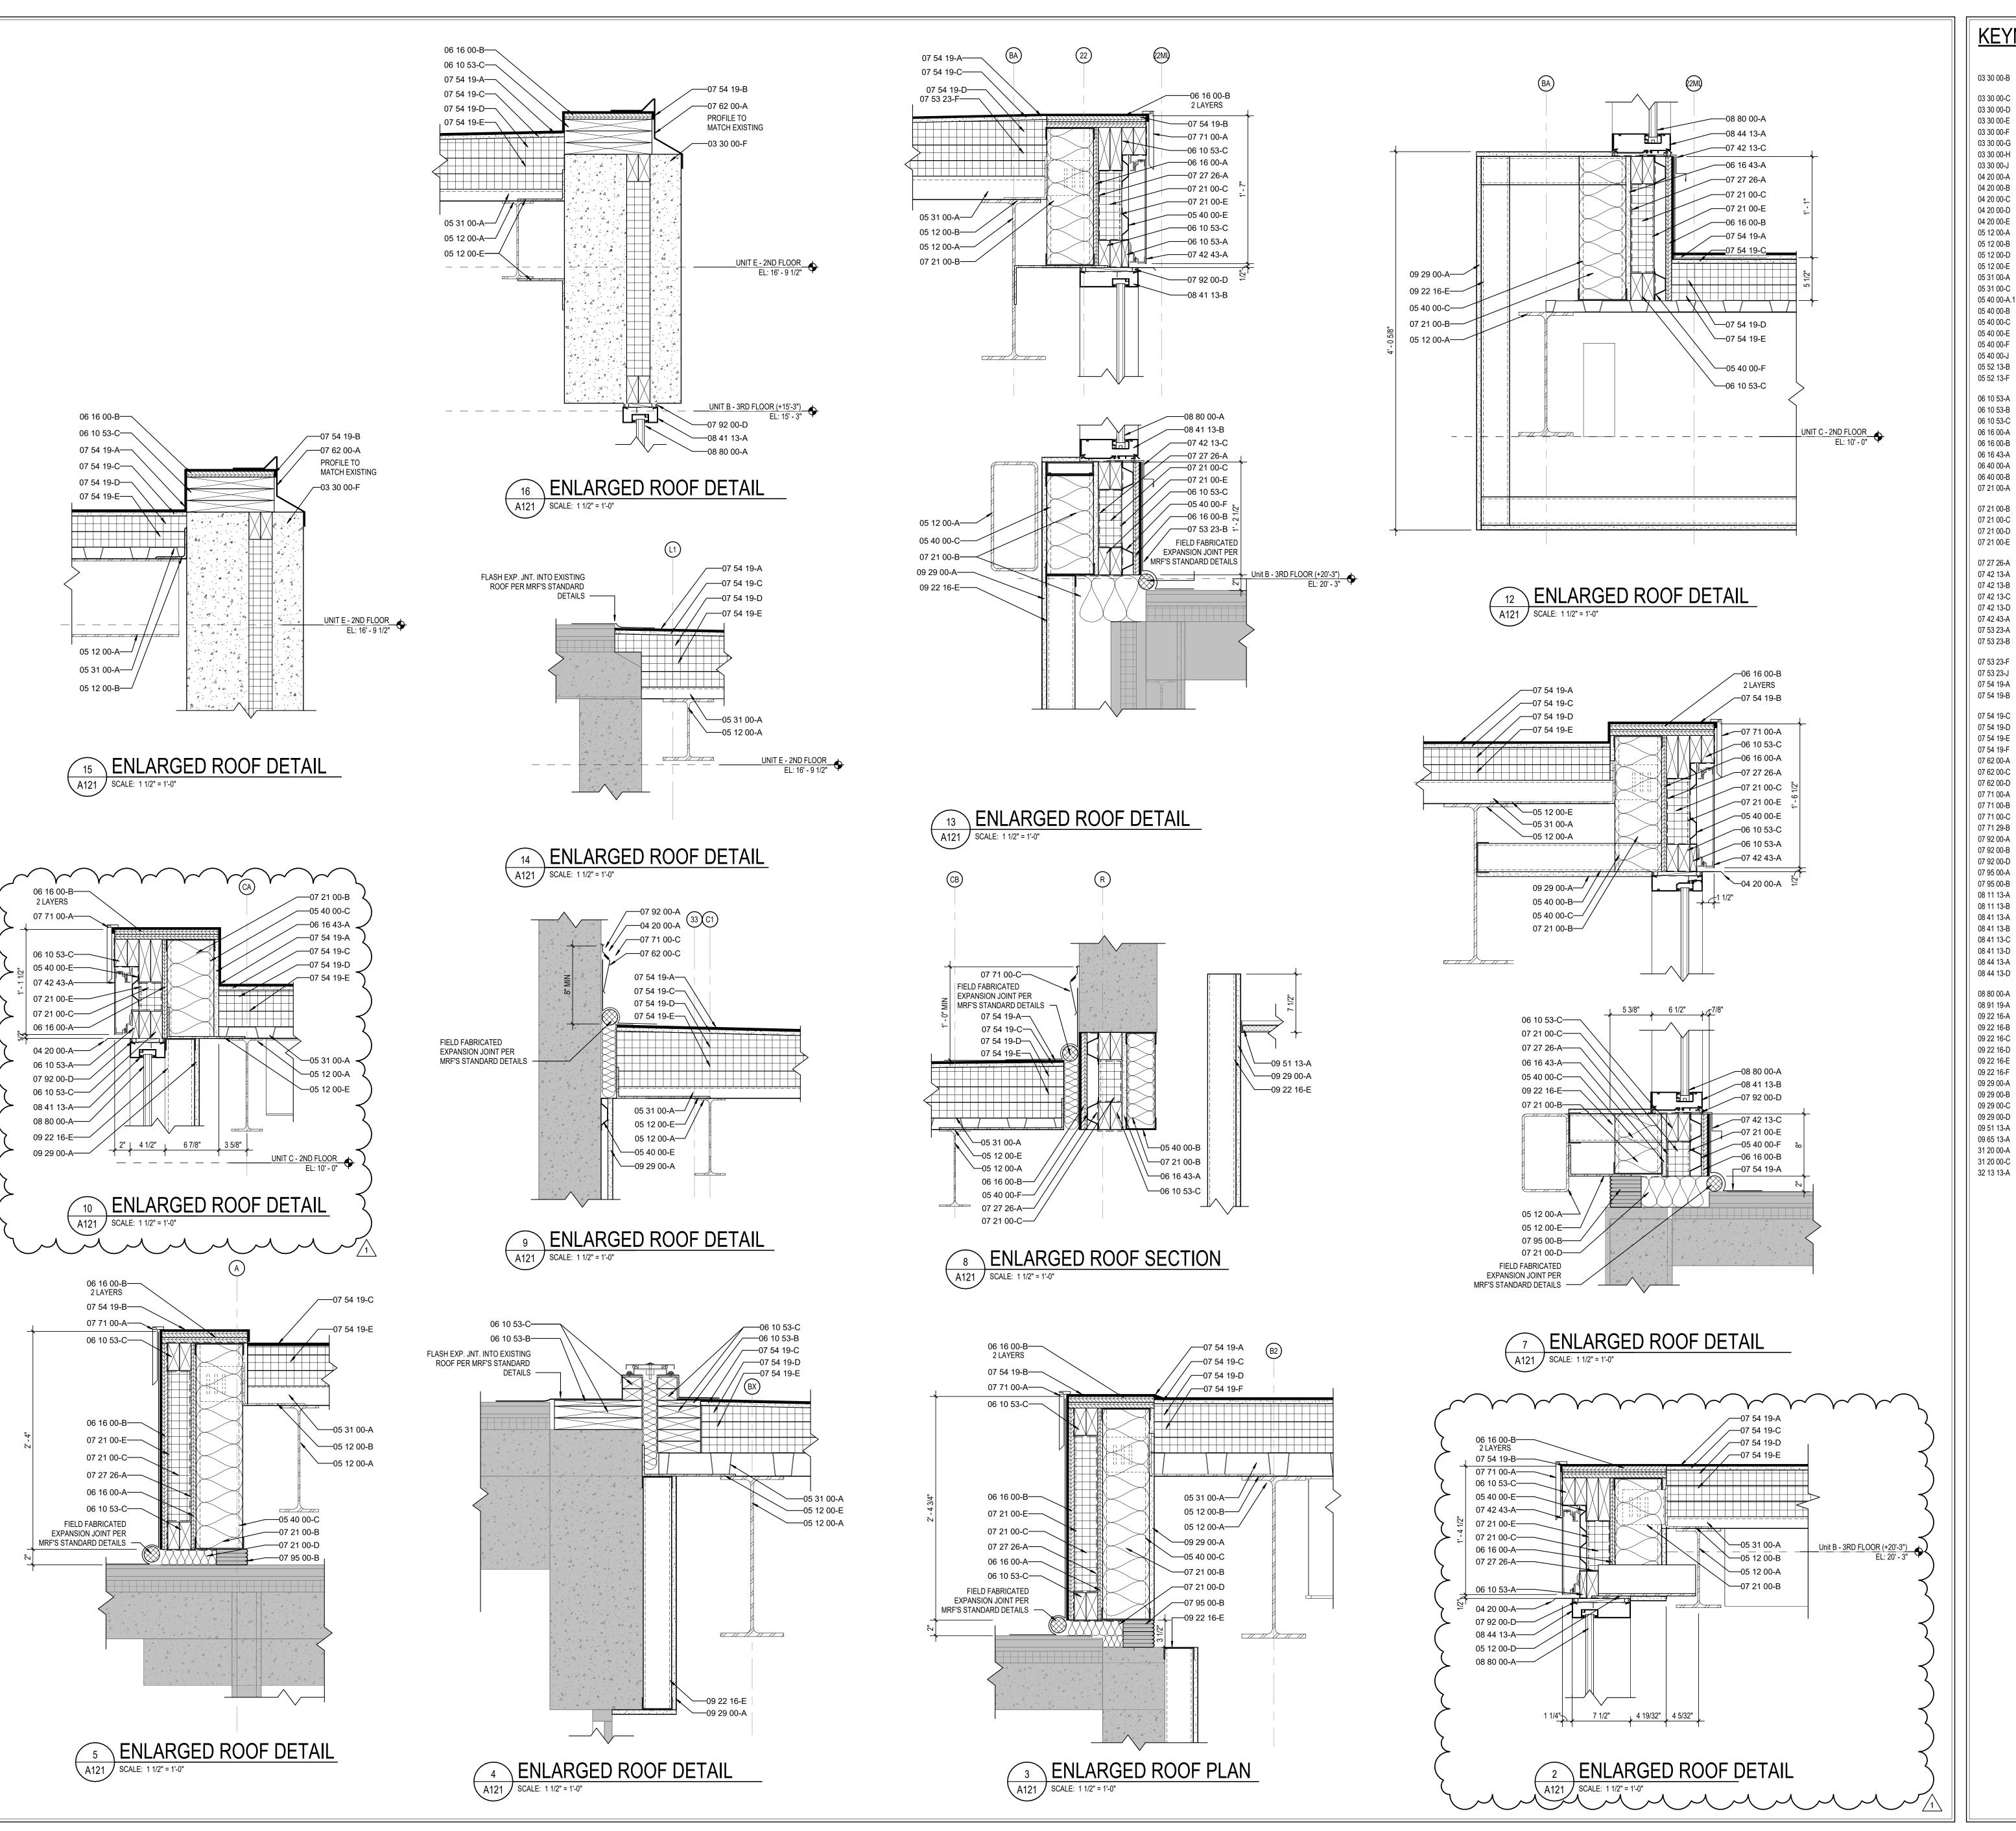THROUGH WALL FLASHING W/ STAINLESS STEEL DRIP EDGE

STRUCTURAL STEEL FRAMING MEMBER- SEE STRUCTURAL

CONCRETE MASONRY UNIT

BOND BEAM MASONRY UNIT

STEEL ANGLE- SEE STRUCTURAL

STEEL PLATE- SEE STRUCTURAL

2 1/2" STEEL STUD (20 GA. MIN.)

3 5/8" STEEL STUD (16 GA. MIN.)

6" STEEL STUD (16 GA. MIN.)

CLIP ANGLE

SHIM AS REQUIRED

1X WOOD BLOCKING

2X WOOD BLOCKING

5/8" EXTERIOR GRADE PLYWOOD

3/4" EXTERIOR GRADE PLYWOOD

5/8" EXTERIOR GYPSUM SHEATHING

5/8" MEDIUM DENSITY FIBERBOARD

1/2" MEDIUM DENSITY FIBERBOARD

MINERAL WOOL BATT INSULATION

PRE-FINISHED METAL WALL PANEL

BRAKE METAL FLASHING/TRIM

COMPOSITE METAL WALL PANEL

TAPERED POLYISO INSULATION BOARD

2" POLYISO INSULATION BOARD (R-11.8)

ROOF EXPANSION JOINT METAL COVER

MANUFACTURED FASCIA CLADDING

EXPANSION JOINT COVER - SEE SPECS.

4 1/2" ALUMINUM-FRAMED STOREFRONT

6 1/2" ALUMINUM-FRAMED STOREFRONT

GLAZING - SEE SCHEDULE/ELEVATIONS

FIXED LOUVER - MATCH EXISTING

SOUND ATTENUATION INSULATION

FINISH GRADE- SEE CIVIL SHEETS

DRAINING GRANULAR FILL

SIDEWALK- SEE CIVIL SHEETS

7/8" FURRING CHANNEL

1 5/8" STEEL STUD

2 1/2" STEEL STUD

3 5/8" STEEL STUD

METAL J- MOULD

RESILIENT BASE

6" STEEL STUD

1 1/2" FURRING CHANNEL

WIDE STILE ALUMINUM ENTRANCE DOOR

7 1/2" DEEP ALUMINUM CURTAINWALL SYSTEM

5/8" GYPSUM WALL BOARD (SEE SPECS FOR TYPE)

SUSPENDED GYPSUM BOARD CEILING ASSEMBLY

ACOUSTICAL CEILING SUSPENSION ASSEMBLY

EXTERIOR WALL EXPANSION JOINT COVER

SEALANT EACH SIDE, TYPICAL

MANUFACTURED GRAVEL STOP/DRIP EDGE

MANUFACTURED COUNTERFLASHING SYSTEM

ALUMINUM ROOF EXPANSION JOINT ASSEMBLY

BACKER ROD AND SEALANT EACH SIDE, TYPICAL

HOLLOW METAL DOOR/BORROWED LIGHT FRAME

ALUMINUM BRAKE METAL FLASHING/TRIM TO MATCH STOREFRONT

ALUMINUM BRAKE METAL FLASHING/TRIM TO MATCH CURTAINWALL

1/2" COVER BOARD

COPING - CUSTOM TERMINATION BAR

SEALANT, TYPICAL

GLAZING STOP

PRE-FINISHED METAL SOFFIT PANEL

TOP OF FOOTING OR 48" MAX VERTICAL)

FLUID APPLIED MEMBRANE AIR BARRIER

PACK FULL WITH GLASS FIBER BATT INSULATION

DIRECTION WITH METAL PANEL MANUFACTURER

STEEL BENT PLATE- SEE STRUCTURAL

METAL ROOF DECKING- SEE STRUCTURAL

7/8" FURRING (HAT) CHANNEL (16 GA. MIN.)

1 1/2" FURRING (HAT) CHANNEL (16 GA. MIN.)

1-1/4" I.D. CLEAR ANODIZED ALUMINUM HANDRAIL

CORE DRILL AND SET RAILING POST W/NON-SHRINK, NON-METALLIC

SLAB PERIMETER RIGID INSULATION (R-15 FOR 24" HORIZONTAL R-10 TO

3" CAVITY WALL EXTRUDED POLYSTYRENE INSULATION (R-16.8)

THERMALLY BROKEN COMPOSITE Z-GIRT @ 16" O.C. COORDINATE

METAL HAT CHANNEL (16 GA. MIN.) - SEE SECTIONS FOR DEPTH

MEMBRANE ROOFING - EXTEND OVER AND ATTACH TO FRONT FACE OF

MEMBRANE ROOFING - EXTEND OVER AND ATTACH TO FRONT FACE OF

FULLY ADHERED MEMBRANE ROOFING (MATCH EXISTING)

POLYVINYL-CHLORIDE (PVC) MEMBRANE ROOFING SYSTEM

2 LAYERS OF 2" POLYISO INSULATION BOARD (R-22.8)

2 LAYERS OF 2" POLYISO INSULATION BOARD (R-22.8)

3" CELLULAR METAL ROOF DECK - SEE STRUCTURAL

PRE-CAST CONCRETE MASONRY LINTEL

BULLNOSE UNIT


CONCRETE SLAB OVER VAPOR BARRIER ON DRAINAGE FILL. SEE CONCRETE SLAB ON METAL DECK- SEE STRUCTURAL CONCRETE FOUNDATION- SEE STRUCTURAL CONCRETE FOOTING- SEE STRUCTURAL CAST-IN-PLACE CONCRETE WALL 1/2" EXPANSION MATERIAL CONCRETE RAMP CONCRETE STAIR - SEE STRUCTURAL

SCOPE DRAWINGS:


REVISIONS: ADDENDUM #1 01/29/2025

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DRAWING TITLE: **ENLARGED ROOF DETAILS**

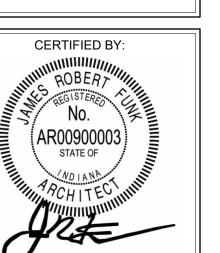

DRAWING NUMBER A121

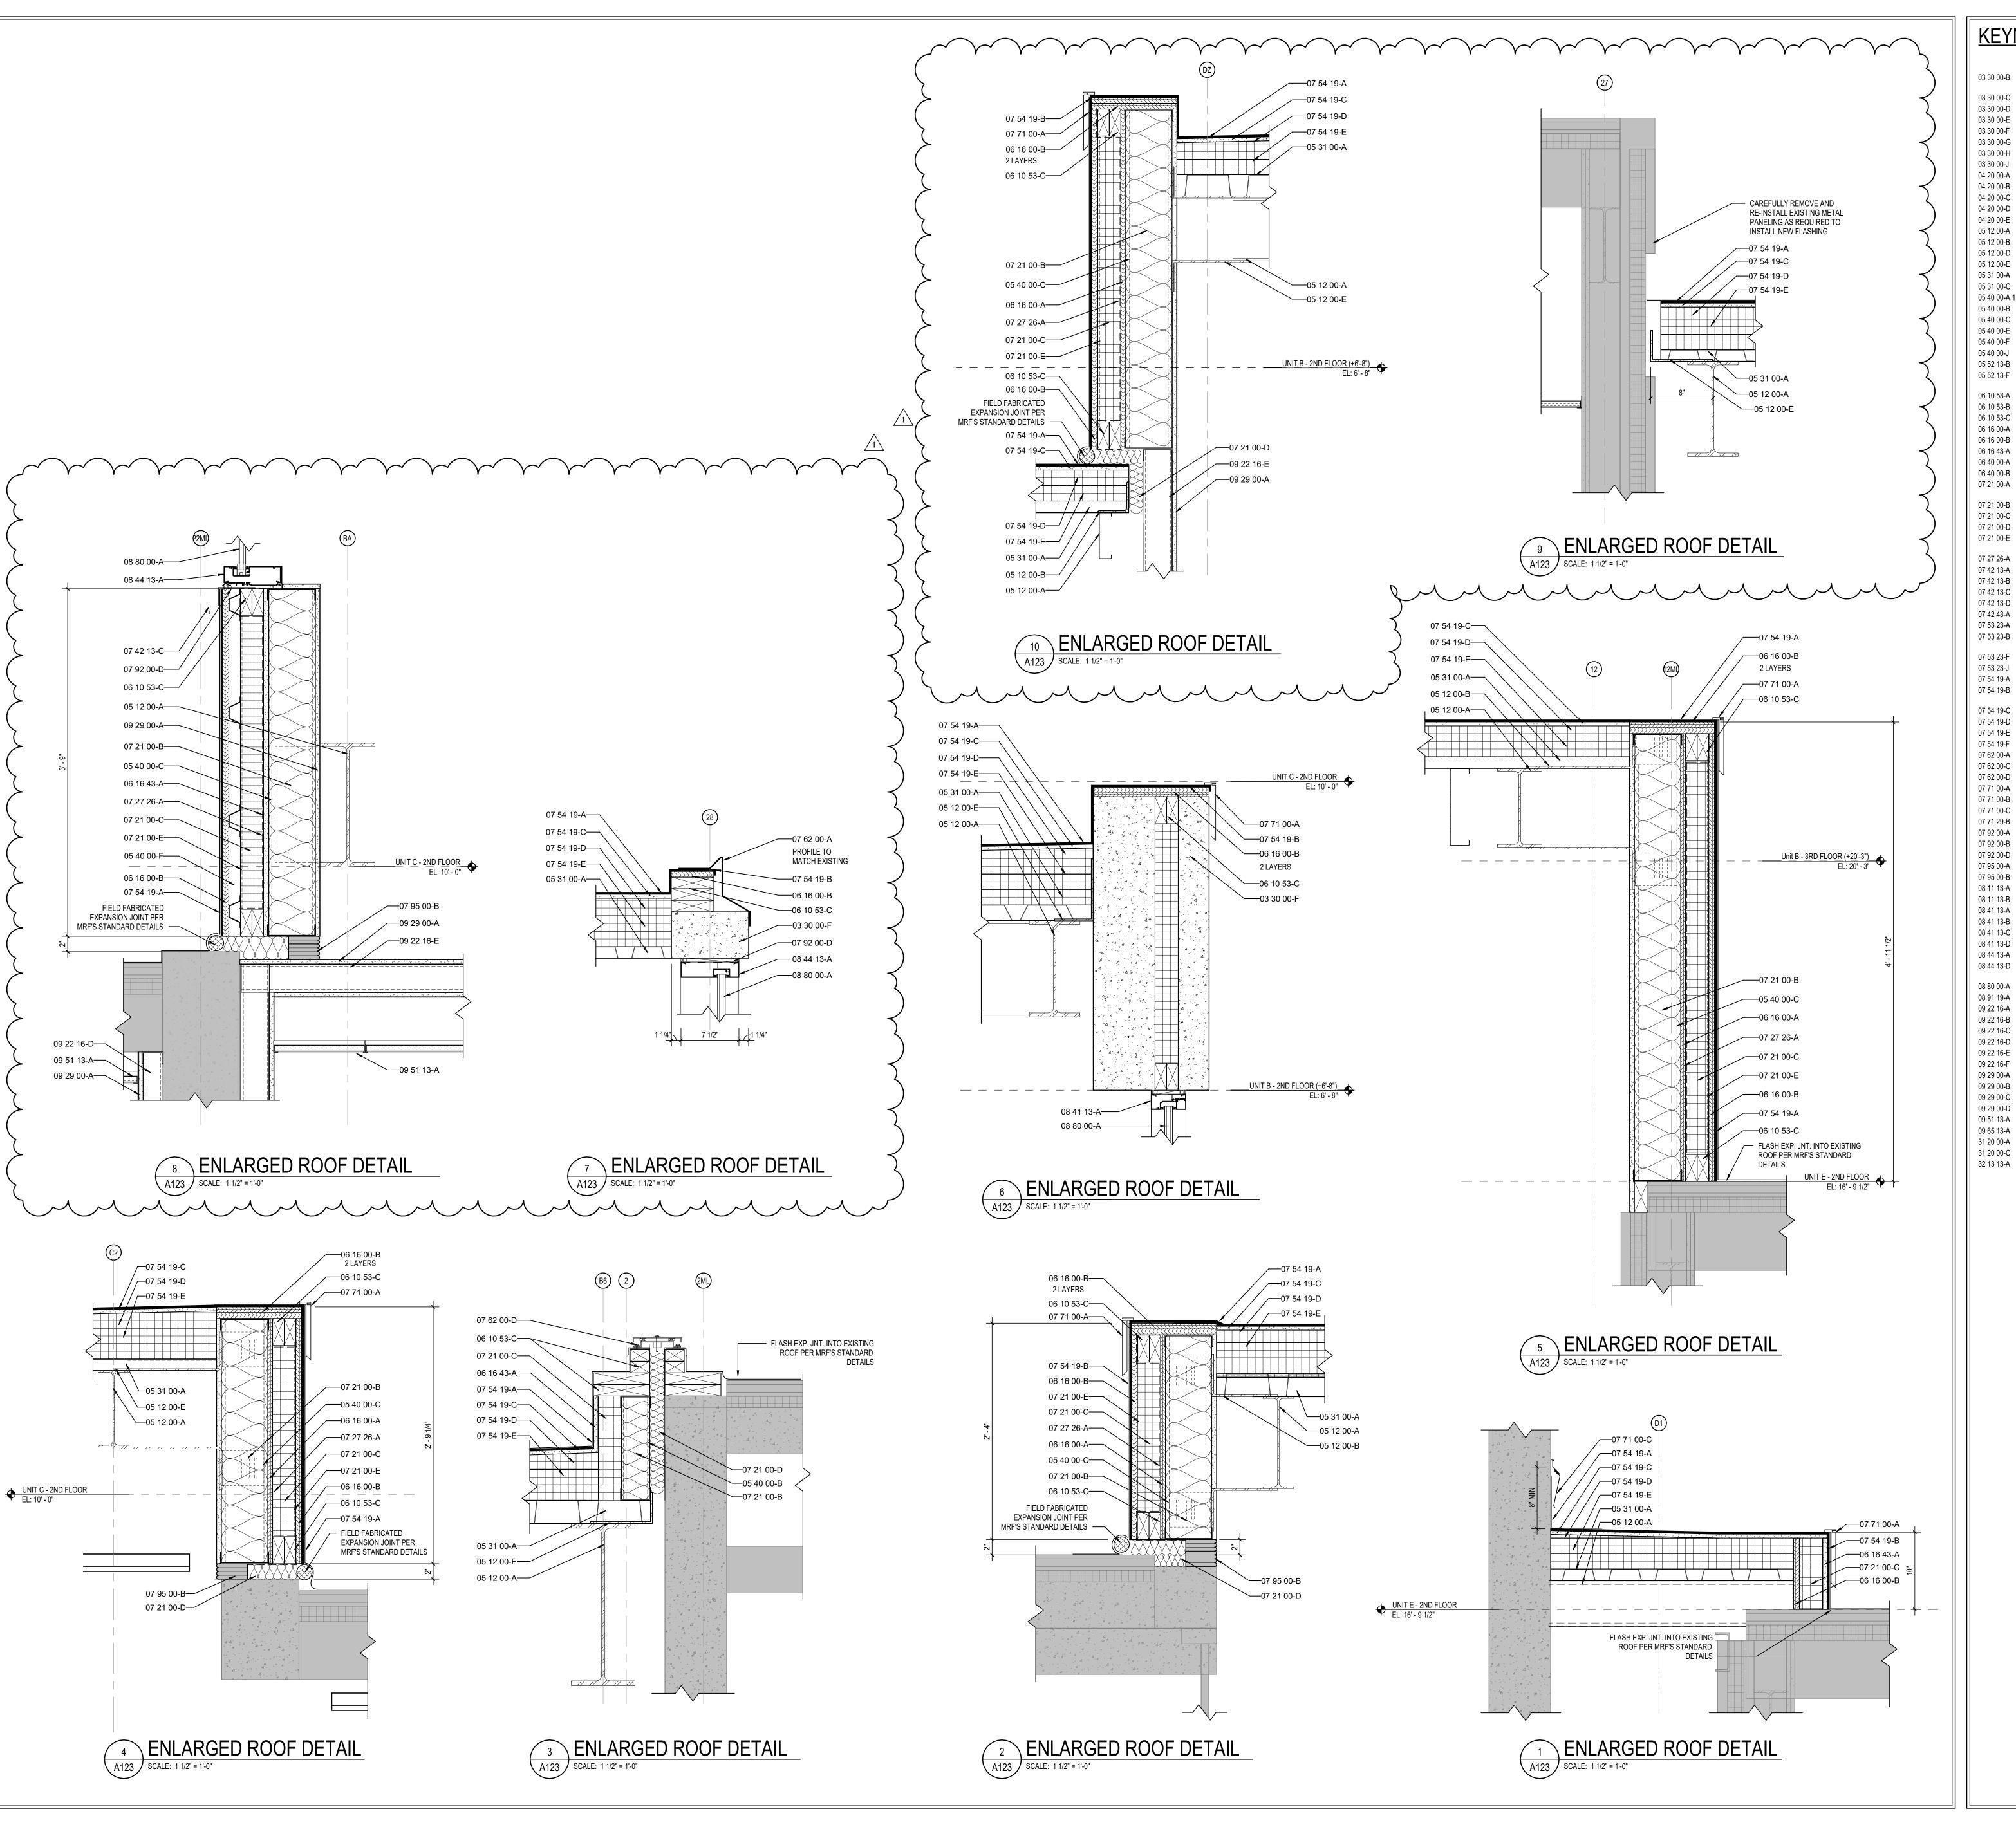

KEYNOTE LEGEND

CONCRETE SLAB OVER VAPOR BARRIER ON DRAINAGE FILL. SEE CONCRETE SLAB ON METAL DECK- SEE STRUCTURAL CONCRETE FOUNDATION- SEE STRUCTURAL CONCRETE FOOTING- SEE STRUCTURAL CAST-IN-PLACE CONCRETE WALL 1/2" EXPANSION MATERIAL CONCRETE RAMP CONCRETE STAIR - SEE STRUCTURAL

CONCRETE MASONRY UNIT BULLNOSE UNIT

THROUGH WALL FLASHING W/ STAINLESS STEEL DRIP EDGE PRE-CAST CONCRETE MASONRY LINTEL BOND BEAM MASONRY UNIT

STRUCTURAL STEEL FRAMING MEMBER- SEE STRUCTURAL STEEL ANGLE- SEE STRUCTURAL STEEL PLATE- SEE STRUCTURAL STEEL BENT PLATE- SEE STRUCTURAL METAL ROOF DECKING- SEE STRUCTURAL 3" CELLULAR METAL ROOF DECK - SEE STRUCTURAL

2 1/2" STEEL STUD (20 GA. MIN.) 3 5/8" STEEL STUD (16 GA. MIN.) 05 40 00-B 05 40 00-C 6" STEEL STUD (16 GA. MIN.) 05 40 00-E 7/8" FURRING (HAT) CHANNEL (16 GA. MIN.) 05 40 00-F 1 1/2" FURRING (HAT) CHANNEL (16 GA. MIN.) 05 40 00-J CLIP ANGLE

1-1/4" I.D. CLEAR ANODIZED ALUMINUM HANDRAIL CORE DRILL AND SET RAILING POST W/NON-SHRINK, NON-METALLIC SHIM AS REQUIRED 1X WOOD BLOCKING

06 10 53-B 2X WOOD BLOCKING 06 10 53-C 5/8" EXTERIOR GRADE PLYWOOD 06 16 00-A 06 16 00-B 3/4" EXTERIOR GRADE PLYWOOD 06 16 43-A 5/8" EXTERIOR GYPSUM SHEATHING 5/8" MEDIUM DENSITY FIBERBOARD 06 40 00-B 1/2" MEDIUM DENSITY FIBERBOARD

SLAB PERIMETER RIGID INSULATION (R-15 FOR 24" HORIZONTAL R-10 TO TOP OF FOOTING OR 48" MAX VERTICAL) PACK FULL WITH GLASS FIBER BATT INSULATION 3" CAVITY WALL EXTRUDED POLYSTYRENE INSULATION (R-16.8) 07 21 00-D MINERAL WOOL BATT INSULATION THERMALLY BROKEN COMPOSITE Z-GIRT @ 16" O.C. COORDINATE 07 21 00-E DIRECTION WITH METAL PANEL MANUFACTURER FLUID APPLIED MEMBRANE AIR BARRIER 07 27 26-A 07 42 13-A PRE-FINISHED METAL WALL PANEL

BRAKE METAL FLASHING/TRIM METAL HAT CHANNEL (16 GA. MIN.) - SEE SECTIONS FOR DEPTH 07 42 43-A COMPOSITE METAL WALL PANEL 07 53 23-A FULLY ADHERED MEMBRANE ROOFING (MATCH EXISTING) 07 53 23-B MEMBRANE ROOFING - EXTEND OVER AND ATTACH TO FRONT FACE OF 2 LAYERS OF 2" POLYISO INSULATION BOARD (R-22.8)

PRE-FINISHED METAL SOFFIT PANEL

POLYVINYL-CHLORIDE (PVC) MEMBRANE ROOFING SYSTEM MEMBRANE ROOFING - EXTEND OVER AND ATTACH TO FRONT FACE OF 1/2" COVER BOARD

07 54 19-D TAPERED POLYISO INSULATION BOARD 07 54 19-E 2 LAYERS OF 2" POLYISO INSULATION BOARD (R-22.8) 07 54 19-F 2" POLYISO INSULATION BOARD (R-11.8) 07 62 00-A COPING - CUSTOM TERMINATION BAR 07 62 00-D ROOF EXPANSION JOINT METAL COVER MANUFACTURED GRAVEL STOP/DRIP EDGE

07 71 00-B MANUFACTURED FASCIA CLADDING 07 71 00-C MANUFACTURED COUNTERFLASHING SYSTEM 07 71 29-B ALUMINUM ROOF EXPANSION JOINT ASSEMBLY SEALANT, TYPICAL 07 92 00-B SEALANT EACH SIDE, TYPICAL 07 92 00-D BACKER ROD AND SEALANT EACH SIDE, TYPICAL **EXPANSION JOINT COVER - SEE SPECS** 07 95 00-A

EXTERIOR WALL EXPANSION JOINT COVER HOLLOW METAL DOOR/BORROWED LIGHT FRAME GLAZING STOP 4 1/2" ALUMINUM-FRAMED STOREFRONT 6 1/2" ALUMINUM-FRAMED STOREFRONT WIDE STILE ALUMINUM ENTRANCE DOOR ALUMINUM BRAKE METAL FLASHING/TRIM TO MATCH STOREFRONT

08 44 13-A 7 1/2" DEEP ALUMINUM CURTAINWALL SYSTEM ALUMINUM BRAKE METAL FLASHING/TRIM TO MATCH CURTAINWALL 08 44 13-D GLAZING - SEE SCHEDULE/ELEVATIONS 08 80 00-A 08 91 19-A FIXED LOUVER - MATCH EXISTING 09 22 16-A 7/8" FURRING CHANNEL 09 22 16-B 1 1/2" FURRING CHANNEL

1 5/8" STEEL STUD 09 22 16-D 2 1/2" STEEL STUD 09 22 16-E 3 5/8" STEEL STUD 09 22 16-F 6" STEEL STUD 09 29 00-A 5/8" GYPSUM WALL BOARD (SEE SPECS FOR TYPE) 09 29 00-B SOUND ATTENUATION INSULATION SUSPENDED GYPSUM BOARD CEILING ASSEMBLY

09 29 00-D METAL J- MOULD ACOUSTICAL CEILING SUSPENSION ASSEMBLY 09 51 13-A 09 65 13-A RESILIENT BASE FINISH GRADE- SEE CIVIL SHEETS 31 20 00-A

DRAINING GRANULAR FILL SIDEWALK- SEE CIVIL SHEETS


SCOPE DRAWINGS: These drawings indicate the general scope of the proje n terms of architectural design concept, the dimensions of he building, the major architectural elements and the type

ADDENDUM #1 01/29/2025


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DRAWING TITLE: **ENLARGED ROOF DETAILS**



DRAWING NUMBER A123

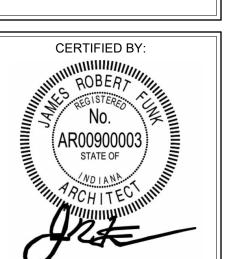

GENERAL PLAN NOTES

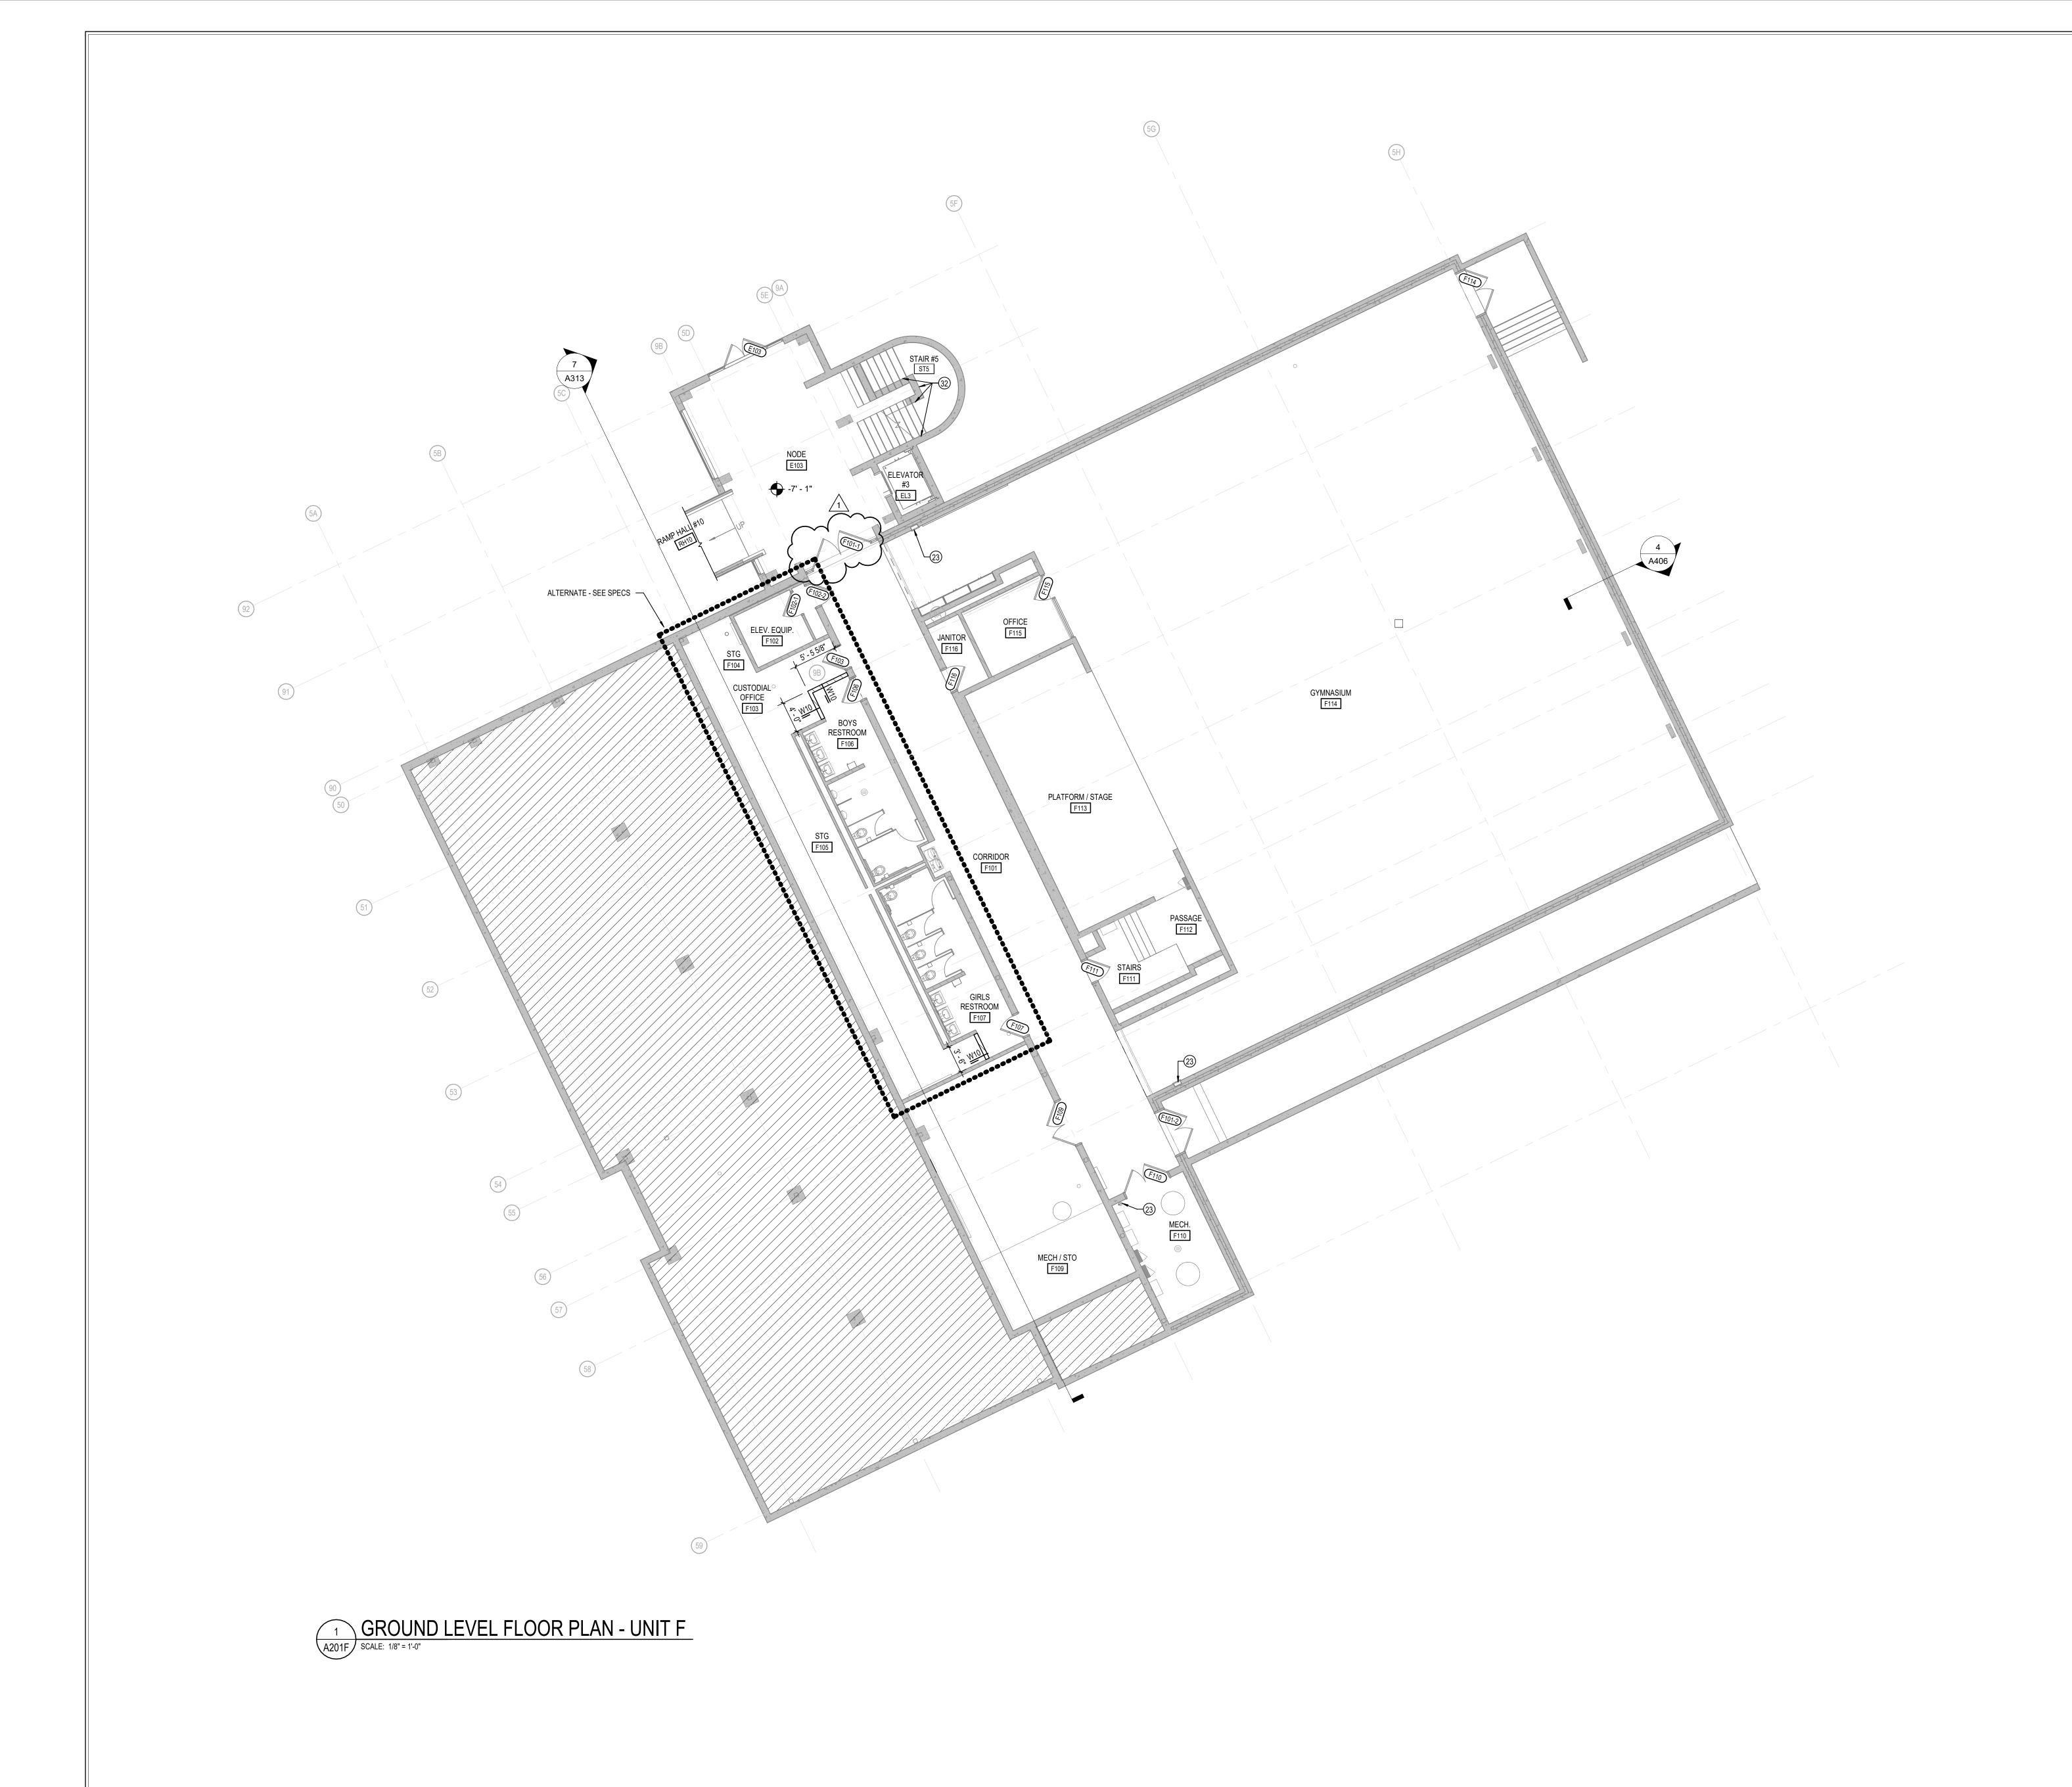- A. COORDINATE THE WORK OF EACH TRADE WITH THE WORK OF OTHER TRADES.

 B. ALL WORK IS TO BE COMPLETED IN STRICT ACCORDANCE WITH ALL
 APPLICABLE CODES, ORDINANCES, RULES, REGULATIONS AND STANDARDS
 INCLUDING, BUT NOT LIMITED TO THOSE LISTED ON THE COVER SHEET. ALL
 APPLICABLE RULES & REGULATIONS ARE TO BE THE MOST CURRENT
- APPLICABLE RULES & REGULATIONS ARE TO BE THE MOST CURRENT ADOPTED EDITIONS.

 C. FIELD VERIFY EXISTING CONDITIONS AND DIMENSIONS PRIOR TO THE COMMENCEMENT OF WORK. DISCREPANCIES BETWEEN THE DOCUMENTS AND THE ACTUAL CONDITIONS SHALL BE BROUGHT TO THE ATTENTION OF THE
- D. ALL DIMENSIONS ARE FROM CENTERLINE OF STRUCTURE, FINISH FACE OF WALL, FACE OF MASONRY, OR FACE OF EXISTING.
 E. ANY DIMENSIONS NOT SHOWN OR DEEMED QUESTIONABLE ARE TO BE

ARCHITECT PRIOR TO THE COMMENCEMENT OF WORK.

- VERIFIED BY ARCHITECT. DO NOT SCALE DRAWINGS.

 REFER TO WALL TYPE SCHEDULE, SHEET A200, TO DETERMINE WHICH WALLS EXTEND TO DECK. SEE STRUCTURAL FOR TOP SUPPORT DETAIL. WHERE METAL STUDS EXTEND TO DECK, PROVIDE SLIP CONNECTIONS FOR ROOF/FLOOR DEFLECTION.
- ALL STEEL STUDS ARE TO BE BRACED ACCORDING TO MANUFACTURER LIMIT HEIGHT (L/240).
 WHERE INSULATED OR SOUND WALLS EXTEND TO DECK, FILL DECK FLUTES
- WITH INSULATION/ SOUND ATTENUATION.
 REFER TO PLUMBING PLANS FOR LOCATION OF FLOOR DRAINS.
 WHERE ACCESS PANELS ARE SHOWN IN TOILET ROOM CHASES, FINAL LOCATION SHALL BE COORDINATED WITH OTHER TRADES PRIOR TO
- INSTALLATION.
 ALL CONCRETE MASONRY UNITS (CMU) SHALL BE LAID RUNNING BOND U.N.O.
 CMU WALLS THAT DO NOT LAY OUT IN FULL OR HALF LENGTHS SHOULD BE
 BALANCED SO AS NOT TO HAVE ANY PIECES LESS THAN 4" IN SIZE EXPOSED
- ALL INTERIOR MASONRY WALLS THAT RUN TO UNDERSIDE OF DECK ABOVE SHALL HAVE A 2" JOINT (U.N.O.) AT THE DECK TO BE FILLED WITH FIRE STOPPING AT RATED WALLS PER PROJECT MANUAL, AND MINERAL WOOL AT THE NON-RATED WALLS TO ALLOW FOR DEFLECTION.
- M. THERE SHALL BE PERIMETER INSULATION CONTINUOUS AROUND THE ENTIRE PERIMETER OF THE BUILDING EXTENDING 2'-0" MINIMUM (R-15 MIN.) HORIZONTAL.
 N. PROVIDE MISCELLANEOUS SUPPORT FOR ALL CEILING SUSPENDED ITEMS.
- O. DOOR AND FRAME NUMBERS CORRESPOND TO ROOM NUMBERS. WHERE MORE THAN ONE DOOR OCCURS IN A ROOM, A SUFFIX HAS BEEN ADDED (E.G. A100-1). SEE A500 SERIES DRAWINGS FOR DOOR SCHEDULE AND DETAILS.

 P. ALL DOOR FRAMES SHALL BE LOCATED 4" OFF FINISH WALLS OR 4" OFF MASONRY WALLS UNLESS NOTED OTHERWISE.
- Q. ALL GLASS AT INTERIOR DOOR FRAMES, DOOR LITES AND WINDOW FRAMES IS TO BE 1/4" CLEAR TEMPERED GLASS UNLESS NOTED OTHERWISE.
 R. AT BUILDING EXPANSION JOINTS, ALL PARTITIONS, CEILINGS, FLOORS AND ALL WALL, FLOOR OR CEILING MOUNTED ITEMS SHALL BE ANCHORED TO THE BUILDING STRUCTURE ON ONLY ONE SIDE OF THE EXPANSIONS JOINTS. CONTRACTOR SHALL COORDINATE CONSTRUCTION OR INSTALLATION OF ALL
- EXPANSION JOINT.

 S. ALL SLAB-ON-GRADE CONTROL JOINTS TO BE CLEANED AND CAULKED PRIOR TO PLACEMENT OF FLOOR FINISH.

ITEMS NOTED TO ASSURE THAT NO SUCH ITEMS BRIDGE ACCROSS THE

- T. SEE REFLECTED CEILING PLANS FOR BULKHEAD LOCATIONS AND DETAILS.
 U. REFER TO MECHANICAL DRAWINGS FOR WALL LOUVER LOCATIONS, SIZES AND QUANTITIES.
- V. SEE A800 SERIES DRAWINGS FOR FINISH SCHEDULE AND PLANS.
 W. SEE A900 SERIES DRAWINGS FOR EQUIPMENT SCHEDULE AND PLANS.
 PROVIDE BLOCKING IN STUD WALLS AND/OR GROUTED MASONRY CORES AS
- REQUIRED TO SUPPORT EQUIPMENT.

 X. PROVIDE FIRE RESISTANT TREATED WOOD BLOCKING SUPPORTS AS REQUIRED FOR ALL SURFACE MOUNTED ITEMS.
- Y. WHERE DISIMILAR FLOOR MATERIALS MEET, THEY SHALL DO SO UNDER THE CENTERLINE OF THE DOOR UNLESS NOTED OTHERWISE.

 Z. APPLY SEALANT AT ALL JUNCTURES BETWEEN DIFFERENT MATERIALS (E.G.
- MASONRY TO GYPSUM WALL BOARD) UTILIZING THE APPROPRIATE TYPE PER SPECIFICATIONS. COLOR TO BE SELECTED BY ARCHITECT.

 AA. APPLY SEALANT AT ALL COUNTERTOPS AND BLACKSPLASHES AT JUNCTURE
- AB. ALL DOORS MUST BE INSTALLED WITH AT LEAST THE MINIMUM MANEUVERING
 CLEARANCE AT THE DOOR APPROACH PER THE MOST CURRENT AMERICANS
 WITH DISARII ITIES ACT
- WITH DISABILITIES ACT.

 AC. BASE FLOOR ELEVATION INDICATED FOR THIS PROJECT IS 100'-0". REFER TO SITE PLAN FOR CORRELATION TO USGS DATUM.

***** KEYED PLAN NOTES

- 3 MILLWORK RECEPTION DESK.
- 4 REPAINT HANDRAILS AT TUBES TO MATCH EXISTING.
 5 PROVIDE WALL MOUNTED STAINLESS STEEL HANDRAIL.
- 6 NOT USED. 7 NOT USED.

18 NOT USED.

- 8 ELECTRIC WATER COOLERS HI-LO ADA TYPE WITH BOTTLE FILLER. SEE MEP
- 9 VERTICAL UNIT VENTILATOR, SEE MECHANICAL DRAWINGS.
 10 PAINTED STEEL GUARDRAIL WITH MESH INFILL PANELS. STAINLESS STEEL HANDRAIL. INTENT IS TO MATCH EXISTING STAIR HANDRAILS.
- 11 CUBICLE CURTAIN AND TRACK
 12 4'x4' BORROWED LITE WITH HOLLOW METAL FRAME AND 1/4" CLEAR LAMINATED
- GLASS. SEE 1/A505 AND 2/A505 FOR MORE INFORMATION.
 4 1/2" ALUMINUM STOREFRONT SYSTEM.
- 48" HIGH GLASS RAILINGS WITH STAINLESS STEEL HANDRAIL
- 15 PHOTOCOPIER/PRINTER OWNER PROVIDED.16 EXISTING ELECTRICAL PANEL TO REMAIN.
- 19 PROVIDE WALL MOUNTED PAINTED STEEL HANDRAILS AT 36" AND 27" A.F.F. INTENT IS TO MATCH HANDRAIL ON OPPOSITE SIDE OF TUBE.
- ALIGN FINISH FACE OF NEW WALL WITH FINISH FACE OF EXISTING.
 INTERIOR EXPANSION JOINT COVER SEE SPECS.
- PROVIDE INSULATED BLANK OFF PANEL AT MECHANICAL SLEEVE LOCATION.
 EXISTING FIRE EXTINGUISHER/CABINET TO REMAIN.
- 1" INTERIOR EXPANSION JOINT. SEE SPECIFICATIONS FOR BASIS OF DESIGN.
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- 28 GATHERING STAIR, SEE SECTIONS FOR MORE INFORMATION.
 29 WALL CONCRETE BLOCK INFILL AT OPENING. SEE DETAILS FOR MORE INFORMATION.
- NEW FIRE EXTINGUISHER/CABINET TO BE INSTALLED.
 WINDOW GYP. BOARD AND STUD FILL IN. SEE SECTIONS AND ELEVATIONS FOR
- MORE INFORMATION.
 32 EXISTING GUARDRAILS AND HANDRAILS TO REMAIN. PROTECT THROUGHOUT
- 32 EXISTING GUARDRAILS AND HANDRAILS TO REMAIN. PROTECT THROUGHOUND DURATION OF CONSTRUCTION.
 33 NEW TRANSLUCENT SANDWICH PANEL ASSEMBLY TO REPLACE EXISTING

KEY PLAN

BCSC TOGETHER WE LEARN

> Keystone Crossing, Indianapolis, IN 46240 317.848.7800 | csoinc.net

BARTHOLOMEW CONSOLIDATED SCHOOL CORPORATION
RENOVATIONS AND ADDITIONS TO FRANCES SMITH ELEMENTAE

SCOPE DRAWINGS:

These drawings indicate the general scope of the project terms of architectural design concept, the dimensions of he building, the major architectural elements and the type of structural, mechanical and electrical systems.

The drawings do not necessarily indicate or describe all work required for full performance and completion of the equirements of the Contract.


On the basis of the general scope indicated or described he trade contractors shall furnish all items required for the proper execution and completion of the work.

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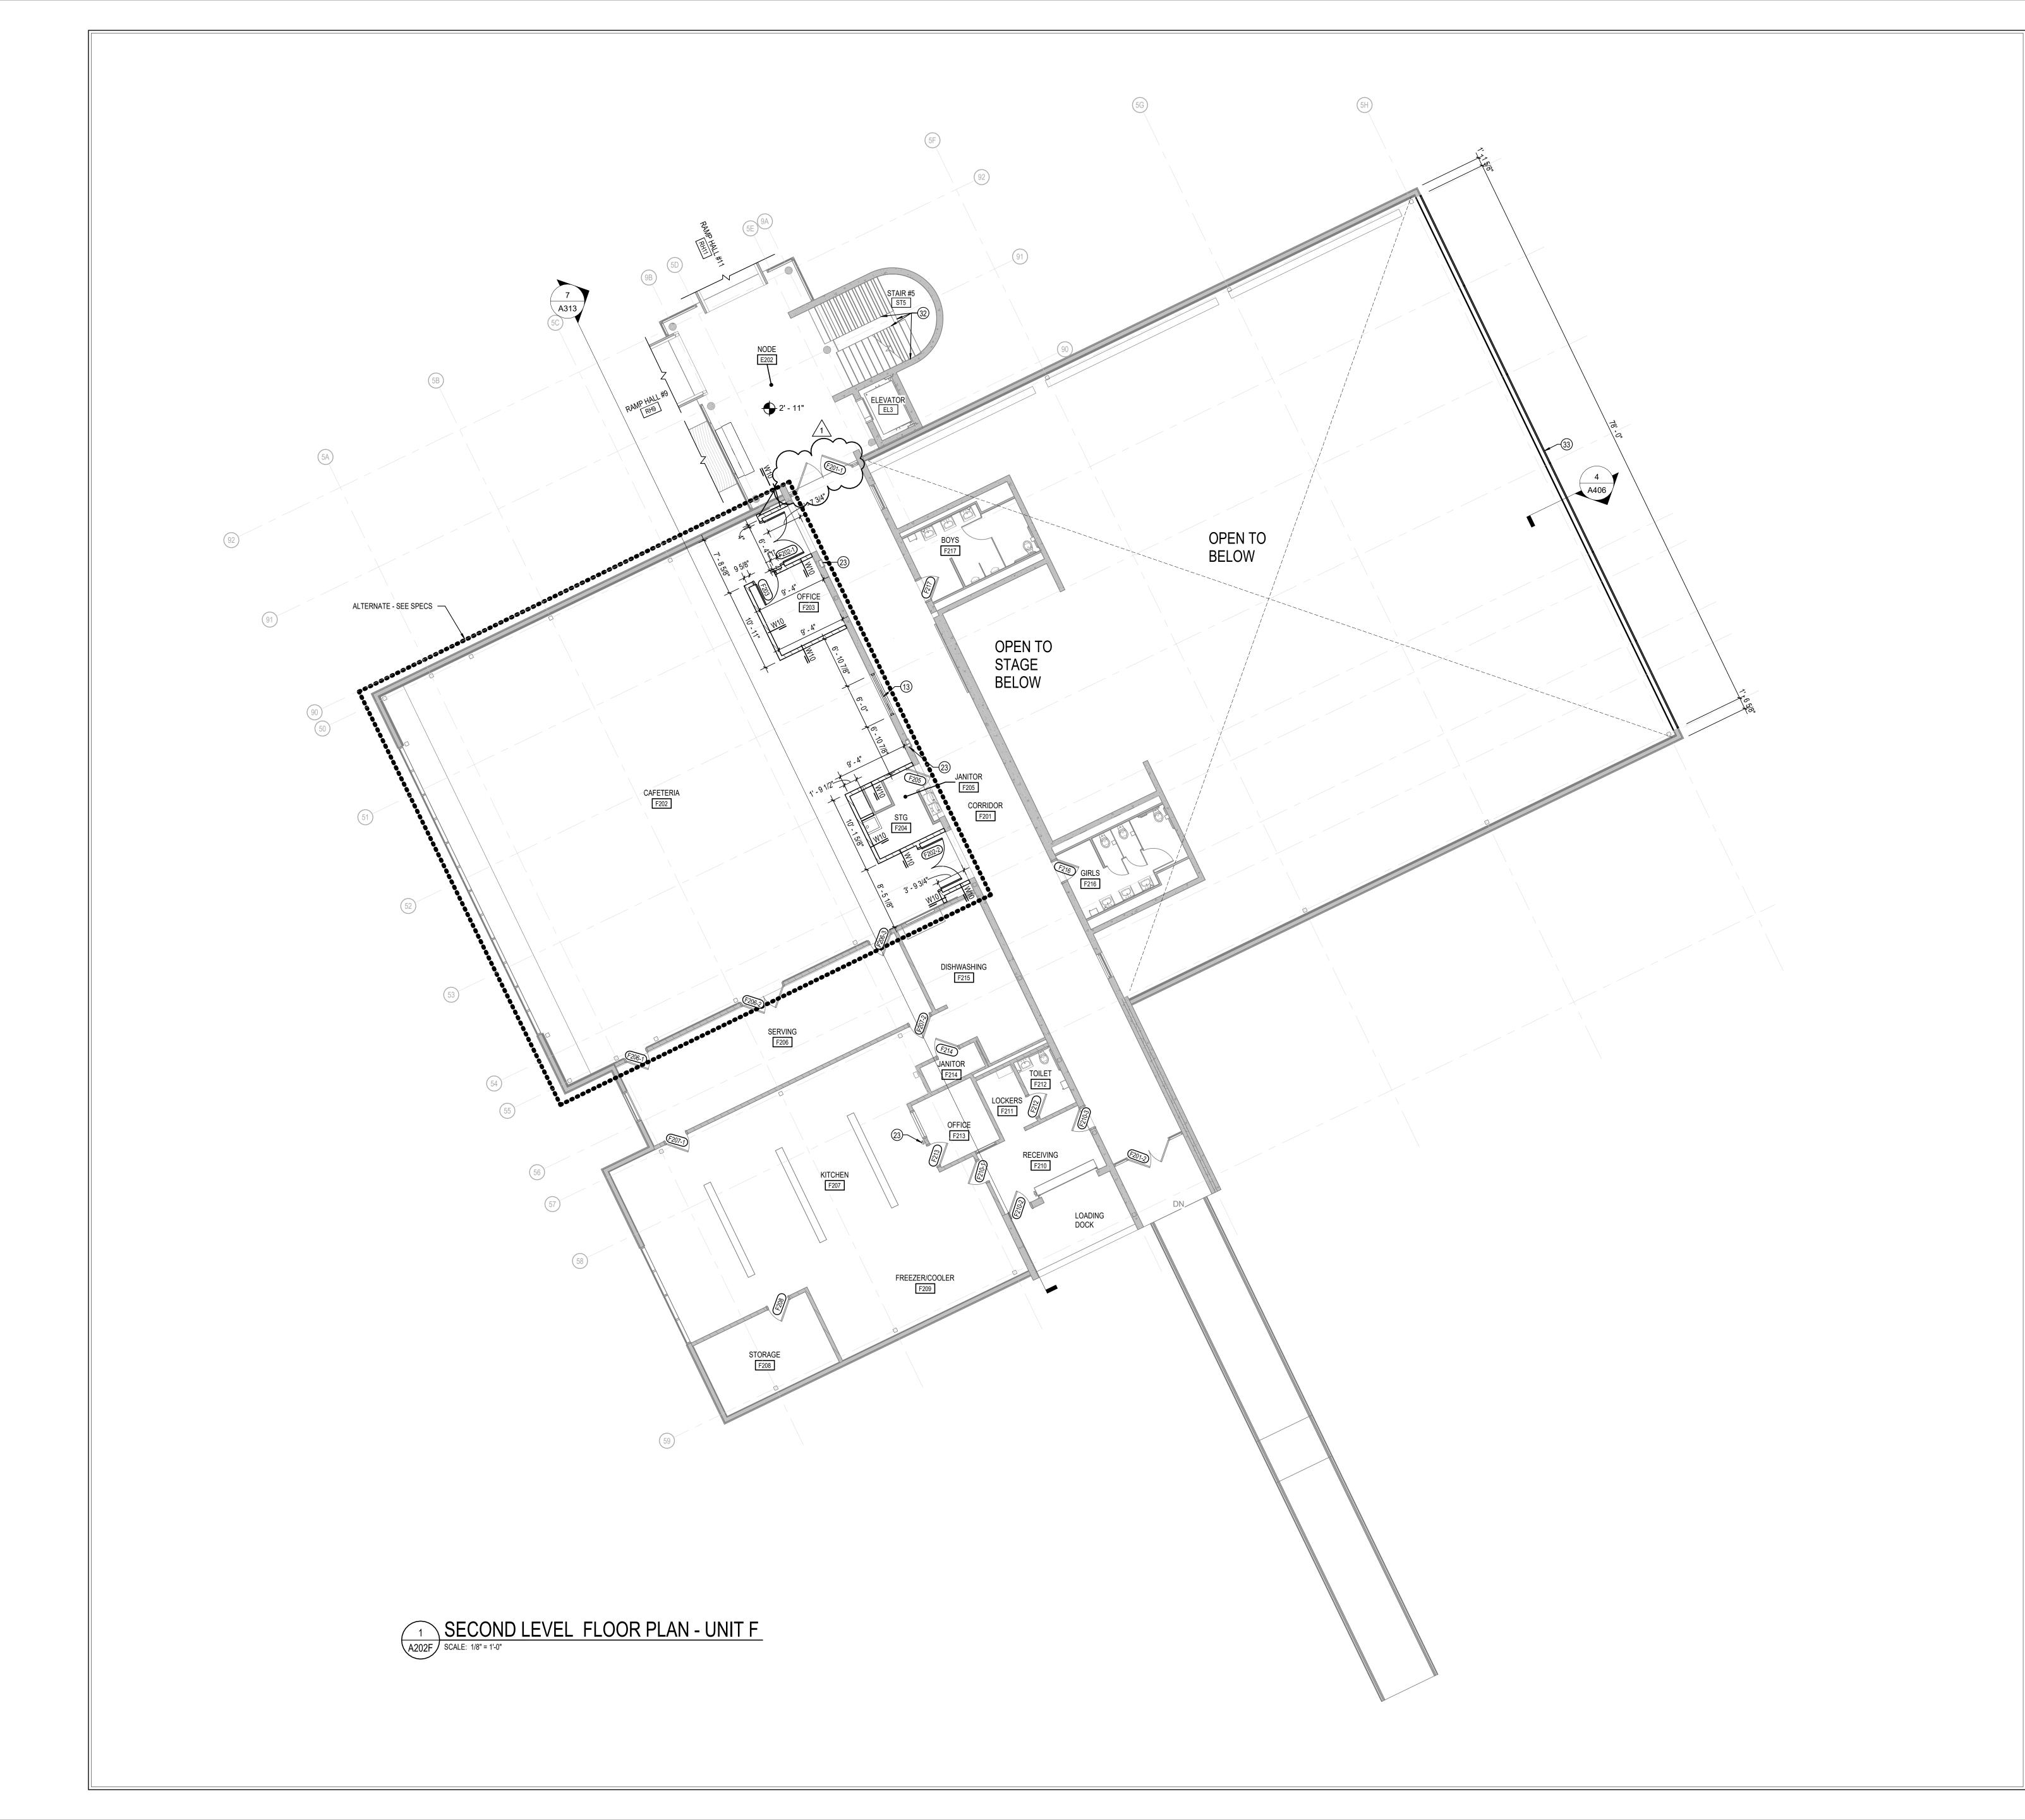
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GROUND LEVEL
FLOOR PLAN UNIT F



A201F

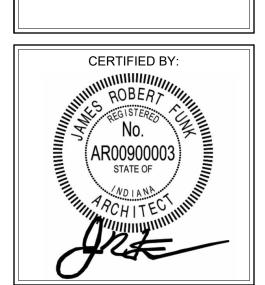

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KEYED PLAN NOTES

- 3 MILLWORK RECEPTION DESK.
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- 6 NOT USED.

16 EXISTING ELECTRICAL PANEL TO REMAIN.

KEY PLAN

- 7 NOT USED. 8 ELECTRIC WATER COOLERS - HI-LO ADA TYPE WITH BOTTLE FILLER. SEE MEP
- 9 VERTICAL UNIT VENTILATOR, SEE MECHANICAL DRAWINGS. 10 PAINTED STEEL GUARDRAIL WITH MESH INFILL PANELS. STAINLESS STEEL
- HANDRAIL. INTENT IS TO MATCH EXISTING STAIR HANDRAILS. 11 CUBICLE CURTAIN AND TRACK 12 4'x4' BORROWED LITE WITH HOLLOW METAL FRAME AND 1/4" CLEAR LAMINATED
- GLASS. SEE 1/A505 AND 2/A505 FOR MORE INFORMATION. 13 4 1/2" ALUMINUM STOREFRONT SYSTEM.
- 14 48" HIGH GLASS RAILINGS WITH STAINLESS STEEL HANDRAIL 15 PHOTOCOPIER/PRINTER - OWNER PROVIDED.
- 18 NOT USED. 19 PROVIDE WALL MOUNTED PAINTED STEEL HANDRAILS AT 36" AND 27" A.F.F. INTENT
- IS TO MATCH HANDRAIL ON OPPOSITE SIDE OF TUBE. 20 ALIGN FINISH FACE OF NEW WALL WITH FINISH FACE OF EXISTING.
- 21 INTERIOR EXPANSION JOINT COVER SEE SPECS.
- 22 PROVIDE INSULATED BLANK OFF PANEL AT MECHANICAL SLEEVE LOCATION. 23 EXISTING FIRE EXTINGUISHER/CABINET TO REMAIN.
- 24 1" INTERIOR EXPANSION JOINT. SEE SPECIFICATIONS FOR BASIS OF DESIGN.
- 25 1" EXTERIOR EXPANSION JOINT. SEE SPECIFICATIONS FOR BASIS OF DESIGN. 26 2" EXTERIOR EXPANSION JOINT. SEE SPECIFICATIONS FOR BASIS OF DESIGN.
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- 28 GATHERING STAIR, SEE SECTIONS FOR MORE INFORMATION. 29 WALL - CONCRETE BLOCK INFILL AT OPENING. SEE DETAILS FOR MORE
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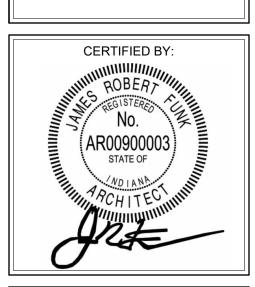
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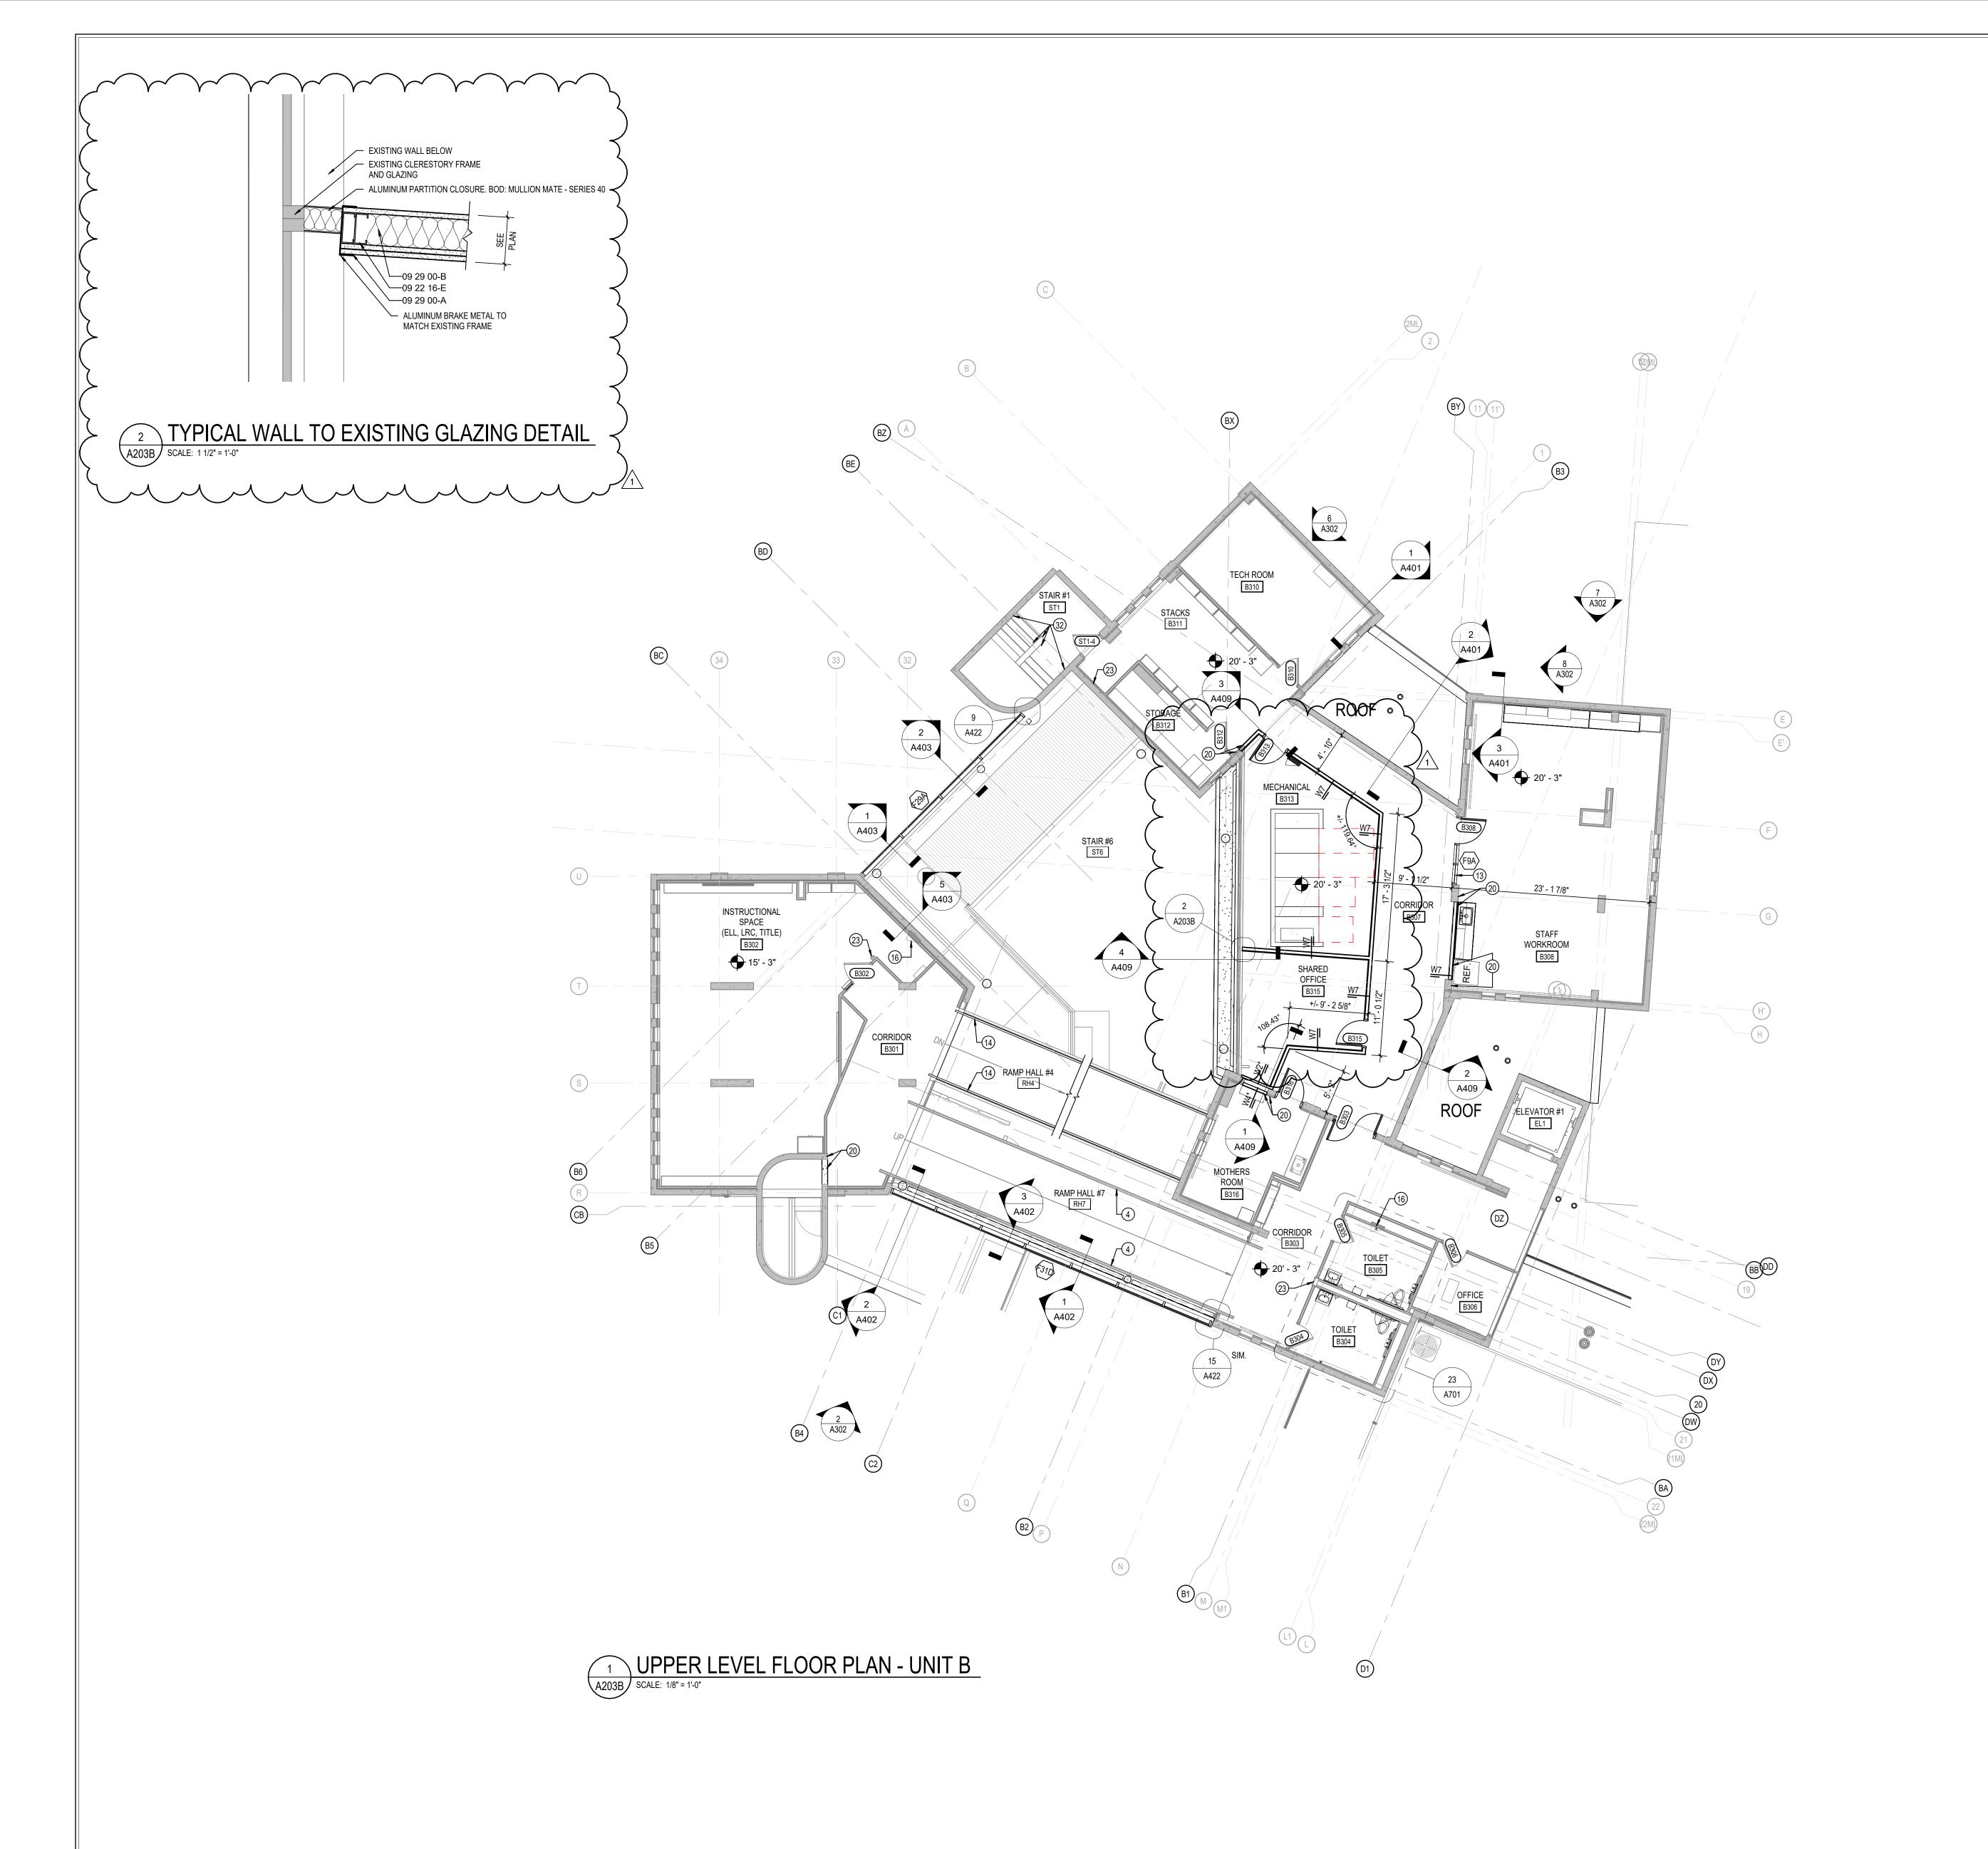
REVISIONS:

ADDENDUM #1 01/29/2025

DRAWING TITLE:



A202F



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 E. ANY DIMENSIONS NOT SHOWN OR DEEMED QUESTIONABLE ARE TO BE
- VERIFIED BY ARCHITECT. DO NOT SCALE DRAWINGS.

 F. REFER TO WALL TYPE SCHEDULE, SHEET A200, TO DETERMINE WHICH WALLS EXTEND TO DECK. SEE STRUCTURAL FOR TOP SUPPORT DETAIL. WHERE METAL STUDS EXTEND TO DECK, PROVIDE SLIP CONNECTIONS FOR ROOF/
- FLOOR DEFLECTION.
 G. ALL STEEL STUDS ARE TO BE BRACED ACCORDING TO MANUFACTURER LIMIT HEIGHT (L/240).
- WHERE INSULATED OR SOUND WALLS EXTEND TO DECK, FILL DECK FLUTES WITH INSULATION/ SOUND ATTENUATION.
 REFER TO PLUMBING PLANS FOR LOCATION OF FLOOR DRAINS.
 WHERE ACCESS PANELS ARE SHOWN IN TOILET ROOM CHASES, FINAL
- LOCATION SHALL BE COORDINATED WITH OTHER TRADES PRIOR TO INSTALLATION.

 K. ALL CONCRETE MASONRY UNITS (CMU) SHALL BE LAID RUNNING BOND U.N.O. CMU WALLS THAT DO NOT LAY OUT IN FULL OR HALF LENGTHS SHOULD BE BALANCED SO AS NOT TO HAVE ANY PIECES LESS THAN 4" IN SIZE EXPOSED
- ALL INTERIOR MASONRY WALLS THAT RUN TO UNDERSIDE OF DECK ABOVE SHALL HAVE A 2" JOINT (U.N.O.) AT THE DECK TO BE FILLED WITH FIRE STOPPING AT RATED WALLS PER PROJECT MANUAL, AND MINERAL WOOL AT
- THE NON-RATED WALLS TO ALLOW FOR DEFLECTION.

 M. THERE SHALL BE PERIMETER INSULATION CONTINUOUS AROUND THE ENTIRE PERIMETER OF THE BUILDING EXTENDING 2'-0" MINIMUM (R-15 MIN.)
- N. PROVIDE MISCELLANEOUS SUPPORT FOR ALL CEILING SUSPENDED ITEMS.
 O. DOOR AND FRAME NUMBERS CORRESPOND TO ROOM NUMBERS. WHERE
 MORE THAN ONE DOOR OCCURS IN A ROOM, A SUFFIX HAS BEEN ADDED (E.G.
 A100-1). SEE A500 SERIES DRAWINGS FOR DOOR SCHEDULE AND DETAILS.
 P. ALL DOOR FRAMES SHALL BE LOCATED 4" OFF FINISH WALLS OR 4" OFF

HORIZONTAL.

- MASONRY WALLS UNLESS NOTED OTHERWISE.

 Q. ALL GLASS AT INTERIOR DOOR FRAMES, DOOR LITES AND WINDOW FRAMES IS TO BE 1/4" CLEAR TEMPERED GLASS UNLESS NOTED OTHERWISE.

 R. AT BUILDING EXPANSION JOINTS, ALL PARTITIONS, CEILINGS, FLOORS AND ALL WALL, FLOOR OR CEILING MOUNTED ITEMS SHALL BE ANCHORED TO THE BUILDING STRUCTURE ON ONLY ONE SIDE OF THE EXPANSIONS JOINTS. CONTRACTOR SHALL COORDINATE CONSTRUCTION OR INSTALLATION OF ALL
- EXPANSION JOINT.

 S. ALL SLAB-ON-GRADE CONTROL JOINTS TO BE CLEANED AND CAULKED PRIOR TO PLACEMENT OF FLOOR FINISH.

ITEMS NOTED TO ASSURE THAT NO SUCH ITEMS BRIDGE ACCROSS THE

- T. SEE REFLECTED CEILING PLANS FOR BULKHEAD LOCATIONS AND DETAILS.
 U. REFER TO MECHANICAL DRAWINGS FOR WALL LOUVER LOCATIONS, SIZES AND QUANTITIES.
- V. SEE A800 SERIES DRAWINGS FOR FINISH SCHEDULE AND PLANS.
 W. SEE A900 SERIES DRAWINGS FOR EQUIPMENT SCHEDULE AND PLANS.
 PROVIDE BLOCKING IN STUD WALLS AND/OR GROUTED MASONRY CORES AS REQUIRED TO SUPPORT EQUIPMENT.
- X. PROVIDE FIRE RESISTANT TREATED WOOD BLOCKING SUPPORTS AS REQUIRED FOR ALL SURFACE MOUNTED ITEMS.
- Y. WHERE DISIMILAR FLOOR MATERIALS MEET, THEY SHALL DO SO UNDER THE CENTERLINE OF THE DOOR UNLESS NOTED OTHERWISE.

 Z. APPLY SEALANT AT ALL JUNCTURES BETWEEN DIFFERENT MATERIALS (E.G.
- MASONRY TO GYPSUM WALL BOARD) UTILIZING THE APPROPRIATE TYPE PER SPECIFICATIONS. COLOR TO BE SELECTED BY ARCHITECT.

 AA. APPLY SEALANT AT ALL COUNTERTOPS AND BLACKSPLASHES AT JUNCTURE
- AB. ALL DOORS MUST BE INSTALLED WITH AT LEAST THE MINIMUM MANEUVERING CLEARANCE AT THE DOOR APPROACH PER THE MOST CURRENT AMERICANS
- WITH DISABILITIES ACT.

 AC. BASE FLOOR ELEVATION INDICATED FOR THIS PROJECT IS 100'-0". REFER TO SITE PLAN FOR CORRELATION TO USGS DATUM.


KEYED PLAN NOTES

- 3 MILLWORK RECEPTION DESK.
- 4 REPAINT HANDRAILS AT TUBES TO MATCH EXISTING.
 5 PROVIDE WALL MOUNTED STAINLESS STEEL HANDRAIL.
- 6 NOT USED.
- NOT USED.
 ELECTRIC WATER COOLERS HI-LO ADA TYPE WITH BOTTLE FILLER. SEE MEP
- 9 VERTICAL UNIT VENTILATOR, SEE MECHANICAL DRAWINGS.
 10 PAINTED STEEL GUARDRAIL WITH MESH INFILL PANELS. STAINLESS STEEL HANDRAIL. INTENT IS TO MATCH EXISTING STAIR HANDRAILS.
- CUBICLE CURTAIN AND TRACK
 4'x4' BORROWED LITE WITH HOLLOW METAL FRAME AND 1/4" CLEAR LAMINATED GLASS. SEE 1/A505 AND 2/A505 FOR MORE INFORMATION.
- 4 1/2" ALUMINUM STOREFRONT SYSTEM.
 48" HIGH GLASS RAILINGS WITH STAINLESS STEEL HANDRAIL
- 15 PHOTOCOPIER/PRINTER OWNER PROVIDED.
- 16 EXISTING ELECTRICAL PANEL TO REMAIN.18 NOT USED.
- 19 PROVIDE WALL MOUNTED PAINTED STEEL HANDRAILS AT 36" AND 27" A.F.F. INTENT IS TO MATCH HANDRAIL ON OPPOSITE SIDE OF TUBE.
- 20 ALIGN FINISH FACE OF NEW WALL WITH FINISH FACE OF EXISTING.
 21 INTERIOR EXPANSION JOINT COVER SEE SPECS.
- 21 INTERIOR EXPANSION JOINT COVER SEE SPECS.
 22 PROVIDE INSULATED BLANK OFF PANEL AT MECHANICAL SLEEVE LOCATION.
- EXISTING FIRE EXTINGUISHER/CABINET TO REMAIN.
 1" INTERIOR EXPANSION JOINT. SEE SPECIFICATIONS FOR BASIS OF DESIGN.
 1" EXTERIOR EXPANSION JOINT. SEE SPECIFICATIONS FOR BASIS OF DESIGN.
- 1" EXTERIOR EXPANSION JOINT. SEE SPECIFICATIONS FOR BASIS OF DESIGN.
 2" EXTERIOR EXPANSION JOINT. SEE SPECIFICATIONS FOR BASIS OF DESIGN.
- 27 2" INTERIOR EXPANSION JOINT. SEE SPECIFICATIONS FOR BASIS OF DESIGN.
 28 GATHERING STAIR, SEE SECTIONS FOR MORE INFORMATION.
- 29 WALL CONCRETE BLOCK INFILL AT OPENING. SEE DETAILS FOR MORE INFORMATION.
- NEW FIRE EXTINGUISHER/CABINET TO BE INSTALLED.
 WINDOW GYP. BOARD AND STUD FILL IN. SEE SECTIONS AND ELEVATIONS FOR

KEY PLAN

- MORE INFORMATION.
 32 EXISTING GUARDRAILS AND HANDRAILS TO REMAIN. PROTECT THROUGHOUT
- DURATION OF CONSTRUCTION.

 33 NEW TRANSLUCENT SANDWICH PANEL ASSEMBLY TO REPLACE EXISTING

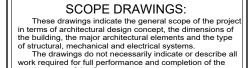


REVISIONS: ADDENDUM #1 01/29/2025

ISSUE DATE DRAWN BY CHECKED BY 01/15/2025 ZER ECN

DRAWING TITLE:

UPPER LEVEL FLOOR PLAN -UNIT B

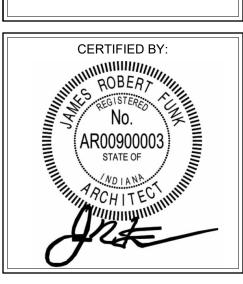

A203B



KEY PLAN

GENERAL REFLECTED **CEILING PLAN NOTES**

PET FINISH KEY

SEE FINISH LEGEND ON A800.

- SEE THE ELECTRICAL DRAWINGS FOR SIZES. TYPES. AND QUANTITIES OF LIGHT FIXTURES, SPEAKERS, SMOKE DETECTORS, AND OTHER CEILING MOUNTED
- ELECTRICAL DEVICES. SEE THE MECHANICAL DRAWINGS FOR SIZES, TYPES, AND QUANTITIES OF DIFFUSERS, GRILLES, AND OTHER MECHANICAL CEILING MOUNTED DEVICES. PROVIDE, FIELD LOCATE AND INSTALL 16"x16" FLUSH ACCESS PANELS AT ALL
- MECHANICAL AND PLUMBING PIPING VALVE LOCATIONS ABOVE SUSPENDED GYPSUM BOARD CEILINGS. SEE THE MECHANICAL, AND PLUMBING DRAWINGS FOR LOCATIONS. SEE THE STRUCTURAL DRAWINGS FOR MASONRY WALLS USED FOR SHEAR WALLS THAT ARE REQUIRED TO EXTEND TO DECK/STRUCTURE ABOVE. PROVIDE
- BRACING FOR ALL MASONRY WALLS NOT EXTENDING TO THE DECK/STRUCTURE AS DETAILED ON STRUCTURAL DRAWINGS. METAL STUD WALLS SHALL BE ATTACHED TO THE STRUCTURE ABOVE WITH SLIP CONNECTORS, STUD WALLS NOT EXTENDING TO THE STRUCTURE/DECK ABOVE SHALL RECEIVE DIAGONAL METAL STUD BRACING AT MAXIMUM 4'-0" O.C. THE SUSPENDED ACOUSTICAL TILE CEILING GRID AS SHOWN ON THESE DRAWINGS IS REPRESENTATIONAL. THE CEILING GRID IS TO BROKEN AS
- ALL EXISTING GYPSUM OR PLASTER CEILINGS AND BULKHEADS TO REMAIN ARE TO BE PAINTED (P12), UNLESS NOTED OTHERWISE. SEE A800 SERIES. SEE MECHANICAL, PLUMBING AND ELECTRICAL DOCUMENTS FOR ADDITIONAL CEILING WORK REQUIRED BY NEW MEP WORK.

REQUIRED AT LIGHT FIXTURES, PROJECTION SCREENS, ETC.

REFLECTED CEILING LEGEND

FLUORESCENT LIGHT FIXTURES, RECESSED OR SURFACED MOUNTED, SEE ELECTRICAL DRAWINGS DOWNLIGHT/HIGH BAY LIGHT FIXTURE; SEE ELECTRICAL CEILING MOUNTED PROJECTOR, SEE TECHNOLOGY DRAWINGS RETURN/EXHAUST GRILL; SEE MECHANICAL DRAWINGS

SUPPLY AIR GRILL; SEE MECHANICAL DRAWINGS LINEAR SLOT SUPPLY AIR GRILL; SEE MECHANICAL DRAWINGS SUSPENDED ACOUSTICAL LAY-IN CEILING

MFG: ARMSTRONG MODEL #1713 STYLE: SCHOOL ZONE HIGH CAC, HIGH NRC DESCRIPTION: SQUARE EDGE COLOR: WHITE SIZE: 24" x 24" x 3/4" LOCATION: CLASSROOMS SUSPENDED ACOUSTICAL LAY-IN CEILING

MFG: ARMSTRONG MODEL #465

STYLE: SCHOOL ZONE HIGH DURABILITY DESCRIPTION: SQUARE EDGE COLOR: WHITE SIZE: 24" x 24" x 5/8" LOCATION: CORRIDORS SUSPENDED ACOUSTICAL LAY-IN CEILING MFG: ARMSTRONG MODEL #1935 STYLE: ULTIMA HEALTH ZONE DESCRIPTION: SQUARE EDGE

COLOR: WHITE SIZE: 2' x 2' x 3/4" LOCATION: RESTROOMS/KITCHENS SUSPENDED GYPSUM WALLBOARD CEILING SYSTEM USE 5/8" WALLBOARD PAINT: (P12) HIGH REFLECTIVE WHITE UNLESS NOTED OTHERWISE

GYPSUM WALLBOARD BULKHEAD PAINT; FOR COLOR REFER TO FINISH LEGEND ON A800.

TUBE INTERIOR - PAINTED SEE FINISH PLANS

STYLE: CUSTOM SIZE: LARGE COLOR: AS INDICATED ON PLAN; REFER TO PET FINISH KEY NOTE: CONTACT MICHELLE MOUSER AT MICHELLE@GREATAPG.COM FOR ADDITIONAL INFORMATION

SOUND ABSORBING CEILING UNIT STYLE: CUSTOM

SIZE: SMALL COLOR: AS INDICATED ON PLAN; REFER TO PET FINISH KEY NOTE: CONTACT MICHELLE MOUSER AT MICHELLE@GREATAPG.COM FOR ADDITIONAL INFORMATION

STYLE: OPTIMA CAPZ, 3932 DESCRIPTION: SQUARE EDGE COLOR: WHITE (WH) SIZE: 48" x 48"

ACOUSTICAL CEILING PANELS MFG: ARMSTRONG STYLE: OPTIMA CAPZ, 3932 DESCRIPTION: SQUARE EDGE COLOR: WHITE (WH) SIZE: 48" x 48" INSTALL: SUSPENDED

CEILING ELEVATION MARK ABOVE FINISHED FLOOR (AT THAT LOCATION IF MULTIPLE FLOOR LEVELS ARE PRESENT)

EXISTING CEILING SYSTEM TO REMAIN

INSTALL: DIRECT ATTACH

MATCH EXISTING CEILING HEIGHT

CEILING PAINT; REFER TO FINISH LEGEND ON A800.


- SLOPE CEILING SYSTEM AS NECESSARY TO MATCH WINDOW HEIGHT.
- ALL FACES AND UNDERSIDE OF BULKHEAD TO RECEIVE PAINT INDICATED ON PLAN. EXPOSED DECK AND DUCTWORK TO RECEIVE PAINT (P3).

© CEILING PLAN NOTES

- EXISTING LIGHTING TO REMAIN. EXPOSED DECK AND DUCTWORK TO RECEIVE PAINT (P12). EXISTING BULKHEAD/CEILING TO REMAIN; PATCH, REPAIR, AND PAINT AS REQUIRED.
- EVENLY IN EACH CORRIDOR AND BETWEEN EACH FIXTURE WHERE POSSIBLE. EXISTING BULKHEAD AT CORRIDOR WALL TO BE REMOVED AS REQUIRED TO INSTALL NEW CEILING.

INSTALL NEW CEILING PANELS BETWEEN EXISTING LIGHT FIXTURES. CENTER PANELS

- MATCH HEIGHT OF EXISTING ADJACENT BULKHEAD; COORDINATE WITH CASEWORK 10 EXISTING CONCRETE BEAM TO RECEIVE PAINT (P12) ALL EXPOSED FACES. ALL FACES AND UNDERSIDE OF BULKHEAD TO RECEIVE ARCHITECTURAL FILM (FM1).
- 12 GYPSUM WALL BOARD APPLIED TO BOTTOM OF DECK. 13 INSTALL CL8 / CL9 WITH +/-6'-6" WIRE LENGTH FROM CEILING. VERIFY IN FIELD AND CONTACT ARCHITECT PRIOR TO INSTALLATION.
- 4 INSTALL CL8 / CL9 WITH +/-7'-0" WIRE LENGTH FROM CEILING. VERIFY IN FIELD AND CONTACT ARCHITECT PRIOR TO INSTALLATION. 5 INSTALL CL8 / CL9 WITH +/-8'-0" WIRE LENGTH FROM CEILING. VERIFY IN FIELD AND CONTACT ARCHITECT PRIOR TO INSTALLATION.
- 16 INSTALL CL8 / CL9 WITH +/-2'-6" WIRE LENGTH FROM CEILING. VERIFY IN FIELD AND CONTACT ARCHITECT PRIOR TO INSTALLATION. 7 INSTALL CL8 / CL9 WITH +/-3'-2" WIRE LENGTH FROM CEILING. VERIFY IN FIELD AND CONTACT ARCHITECT PRIOR TO INSTALLATION.
- 18 EXISTING METAL CEILING TO REMAIN; PAINT. 19 INSTALL NEW STEEL STRUCTURAL SUPPORT ABOVE CEILING TO STRUCTURE ABOVE AND PROVIDE HOOK AT CEILING FOR INSTALLATION OF SINGLE ATTACHMENT SENSORY
- 20 INSTALL CL8 / CL9 WITH +/-2'-0" WIRE LENGTH FROM CEILING. VERIFY IN FIELD AN CONTACT ARCHITECT PRIOR TO INSTALLATION. INSTALL CL8 / CL9 WITH +/-4'-0" WIRE LENGTH FROM CEILING. VERIFY IN FIELD AND_ CONTACT ARCHITECT PRIOR TO INSTALLATION.
- 2 INSTALL CL8 / CL9 WITH +/-5'-0" WIRE LENGTH FROM CEILING. VERIFY IN FIELD AND

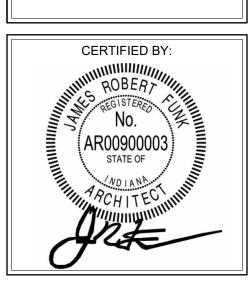

SCOPE DRAWINGS:

These drawings indicate the general scope of the project in terms of architectural design concept, the dimensions of the building, the major architectural elements and the type of structural, mechanical and electrical systems.

The drawings do not necessarily indicate or describe all work required for full performance and completion of the requirements of the Contract.

On the basis of the general scope indicated or described, the trade contractors shall furnish all items required for the proper execution and completion of the work.

REVISIONS:

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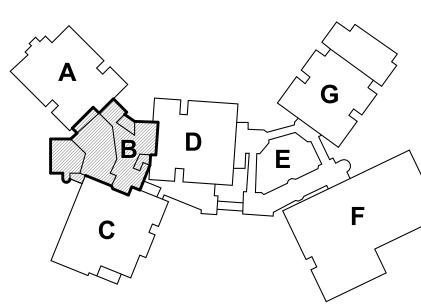
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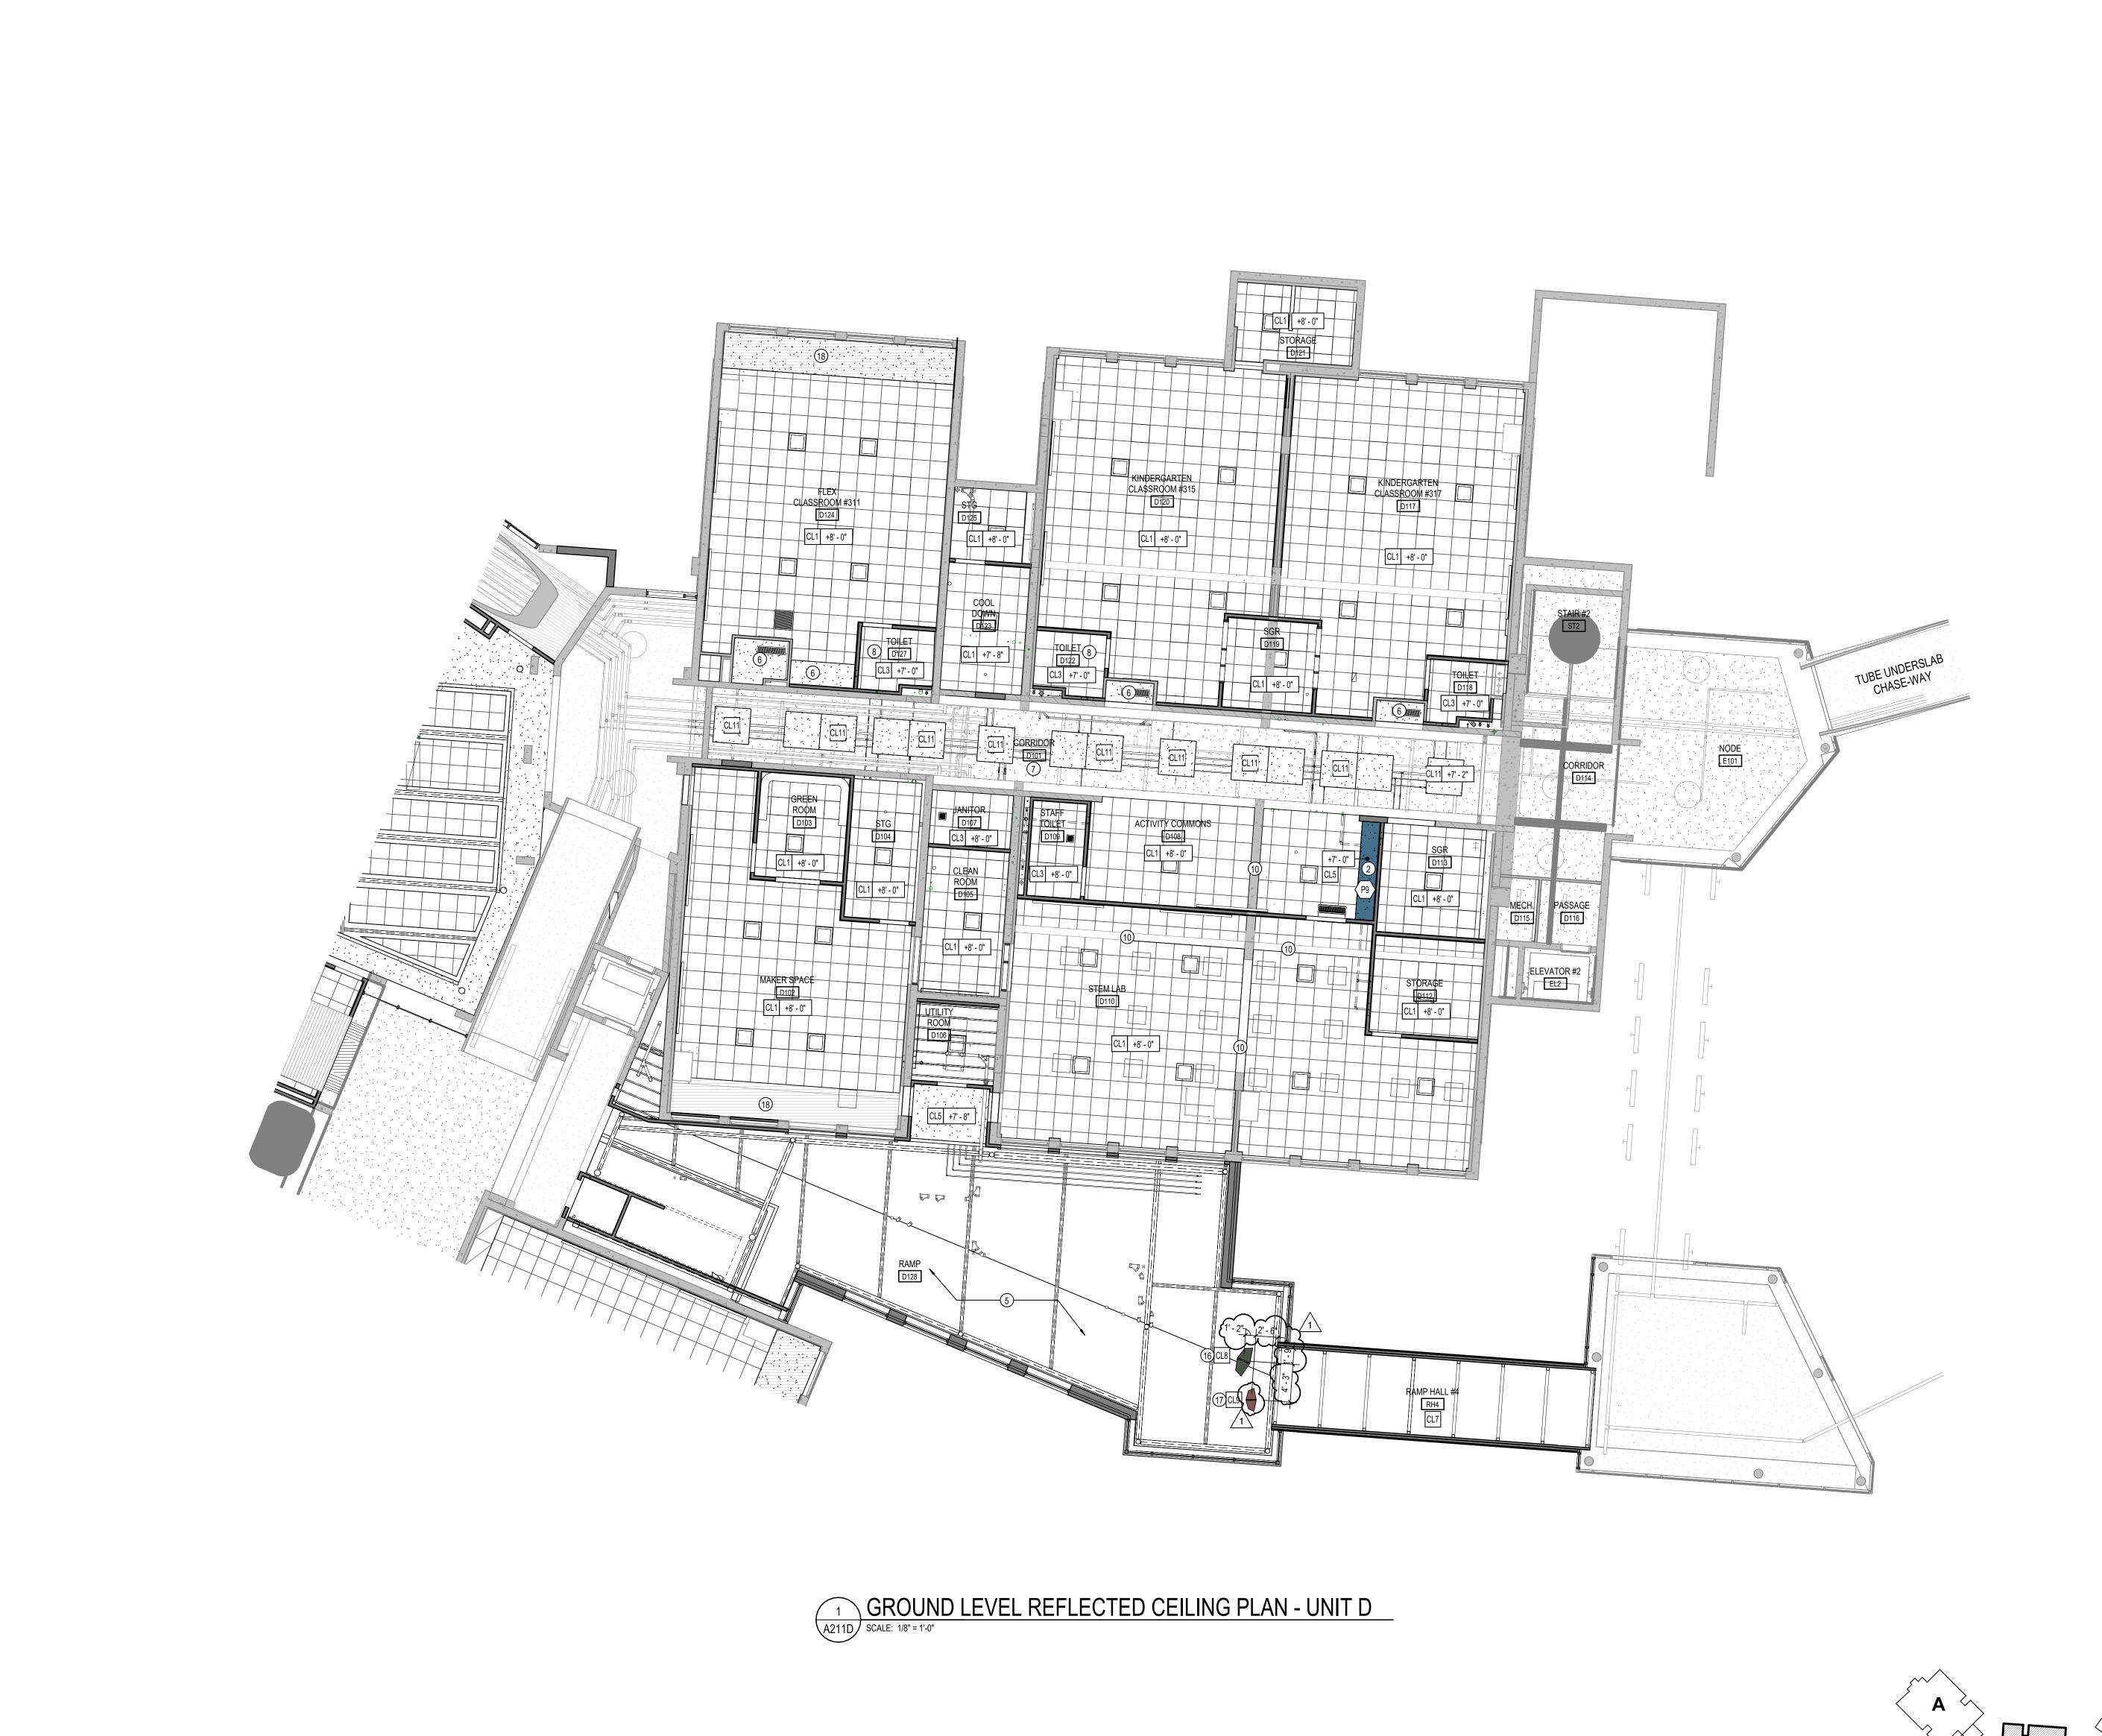
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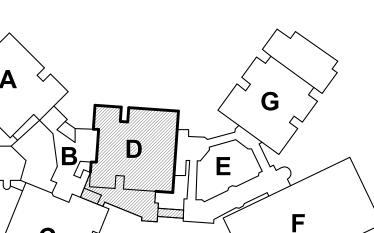
CEILING PLAN -

01/15/2025 ZER

ADDENDUM #1 01/29/2025









GENERAL REFLECTED **CEILING PLAN NOTES**

- SEE THE ELECTRICAL DRAWINGS FOR SIZES, TYPES, AND QUANTITIES OF LIGHT FIXTURES, SPEAKERS, SMOKE DETECTORS, AND OTHER CEILING MOUNTED
- ELECTRICAL DEVICES. SEE THE MECHANICAL DRAWINGS FOR SIZES, TYPES, AND QUANTITIES OF DIFFUSERS, GRILLES, AND OTHER MECHANICAL CEILING MOUNTED DEVICES. PROVIDE, FIELD LOCATE AND INSTALL 16"x16" FLUSH ACCESS PANELS AT ALL MECHANICAL AND PLUMBING PIPING VALVE LOCATIONS ABOVE SUSPENDED GYPSUM BOARD CEILINGS. SEE THE MECHANICAL, AND PLUMBING DRAWINGS
- FOR LOCATIONS. SEE THE STRUCTURAL DRAWINGS FOR MASONRY WALLS USED FOR SHEAR WALLS THAT ARE REQUIRED TO EXTEND TO DECK/STRUCTURE ABOVE. PROVIDE
- BRACING FOR ALL MASONRY WALLS NOT EXTENDING TO THE DECK/STRUCTURE AS DETAILED ON STRUCTURAL DRAWINGS. METAL STUD WALLS SHALL BE ATTACHED TO THE STRUCTURE ABOVE WITH
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- ALL EXISTING GYPSUM OR PLASTER CEILINGS AND BULKHEADS TO REMAIN ARE TO BE PAINTED (P12), UNLESS NOTED OTHERWISE. SEE A800 SERIES. SEE MECHANICAL, PLUMBING AND ELECTRICAL DOCUMENTS FOR ADDITIONAL CEILING WORK REQUIRED BY NEW MEP WORK.

REFLECTED CEILING LEGEND

FLUORESCENT LIGHT FIXTURES, RECESSED OR SURFACED MOUNTED, SEE ELECTRICAL DRAWINGS DOWNLIGHT/HIGH BAY LIGHT FIXTURE; SEE ELECTRICAL CEILING MOUNTED PROJECTOR, SEE TECHNOLOGY DRAWINGS

SUPPLY AIR GRILL; SEE MECHANICAL DRAWINGS LINEAR SLOT SUPPLY AIR GRILL; SEE MECHANICAL DRAWINGS

RETURN/EXHAUST GRILL; SEE MECHANICAL DRAWINGS

SUSPENDED ACOUSTICAL LAY-IN CEILING MFG: ARMSTRONG MODEL #1713 STYLE: SCHOOL ZONE HIGH CAC, HIGH NRC DESCRIPTION: SQUARE EDGE COLOR: WHITE SIZE: 24" x 24" x 3/4" LOCATION: CLASSROOMS SUSPENDED ACOUSTICAL LAY-IN CEILING

MFG: ARMSTRONG MODEL #465

STYLE: SCHOOL ZONE HIGH DURABILITY DESCRIPTION: SQUARE EDGE COLOR: WHITE SIZE: 24" x 24" x 5/8" LOCATION: CORRIDORS SUSPENDED ACOUSTICAL LAY-IN CEILING MFG: ARMSTRONG MODEL #1935 STYLE: ULTIMA HEALTH ZONE

DESCRIPTION: SQUARE EDGE COLOR: WHITE SIZE: 2' x 2' x 3/4" LOCATION: RESTROOMS/KITCHENS SUSPENDED GYPSUM WALLBOARD CEILING SYSTEM USE 5/8" WALLBOARD PAINT: (P12) HIGH REFLECTIVE WHITE UNLESS NOTED OTHERWISE

GYPSUM WALLBOARD BULKHEAD PAINT; FOR COLOR REFER TO FINISH LEGEND ON A800.

TUBE INTERIOR - PAINTED SEE FINISH PLANS

SOUND ABSORBING CEILING UNIT STYLE: CUSTOM SIZE: LARGE COLOR: AS INDICATED ON PLAN; REFER TO PET FINISH KEY NOTE: CONTACT MICHELLE MOUSER AT MICHELLE@GREATAPG.COM FOR ADDITIONAL INFORMATION

SOUND ABSORBING CEILING UNIT STYLE: CUSTOM COLOR: AS INDICATED ON PLAN; REFER TO PET FINISH KEY NOTE: CONTACT MICHELLE MOUSER AT MICHELLE@GREATAPG.COM

ACOUSTICAL CEILING PANELS MFG: ARMSTRONG STYLE: OPTIMA CAPZ, 3932 DESCRIPTION: SQUARE EDGE COLOR: WHITE (WH)

SIZE: 48" x 48" INSTALL: DIRECT ATTACH ACOUSTICAL CEILING PANELS MFG: ARMSTRONG STYLE: OPTIMA CAPZ, 3932 DESCRIPTION: SQUARE EDGE

COLOR: WHITE (WH) SIZE: 48" x 48" INSTALL: SUSPENDED

CEILING ELEVATION MARK ABOVE FINISHED FLOOR (AT THAT LOCATION IF MULTIPLE FLOOR LEVELS ARE PRESENT)


EXISTING CEILING SYSTEM TO REMAIN

MATCH EXISTING CEILING HEIGHT

CEILING PAINT; REFER TO FINISH LEGEND ON A800.

© CEILING PLAN NOTES

- SLOPE CEILING SYSTEM AS NECESSARY TO MATCH WINDOW HEIGHT. ALL FACES AND UNDERSIDE OF BULKHEAD TO RECEIVE PAINT INDICATED ON PLAN. EXPOSED DECK AND DUCTWORK TO RECEIVE PAINT (P3). EXISTING LIGHTING TO REMAIN.
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- EXISTING BULKHEAD AT CORRIDOR WALL TO BE REMOVED AS REQUIRED TO INSTALL MATCH HEIGHT OF EXISTING ADJACENT BULKHEAD; COORDINATE WITH CASEWORK.
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- 13 INSTALL CL8 / CL9 WITH +/-6'-6" WIRE LENGTH FROM CEILING. VERIFY IN FIELD AND CONTACT ARCHITECT PRIOR TO INSTALLATION. 14 INSTALL CL8 / CL9 WITH +/-7'-0" WIRE LENGTH FROM CEILING. VERIFY IN FIELD AND CONTACT ARCHITECT PRIOR TO INSTALLATION.
- 5 INSTALL CL8 / CL9 WITH +/-8'-0" WIRE LENGTH FROM CEILING. VERIFY IN FIELD AND CONTACT ARCHITECT PRIOR TO INSTALLATION. 16 INSTALL CL8 / CL9 WITH +/-2'-6" WIRE LENGTH FROM CEILING. VERIFY IN FIELD AND CONTACT ARCHITECT PRIOR TO INSTALLATION.
- 7 INSTALL CL8 / CL9 WITH +/-3'-2" WIRE LENGTH FROM CEILING. VERIFY IN FIELD AND CONTACT ARCHITECT PRIOR TO INSTALLATION. 18 EXISTING METAL CEILING TO REMAIN; PAINT.
- 19 INSTALL NEW STEEL STRUCTURAL SUPPORT ABOVE CEILING TO STRUCTURE ABOVE AND PROVIDE HOOK AT CEILING FOR INSTALLATION OF SINGLE ATTACHMENT SENSORY SWING BY OWNER. PROVIDE 6' CLEAR RADIUS FROM HOOK TO ANY CABINETS, WALLS, ETC COORDINATE WITH OWNER..
- 0 INSTALL CL8 / CL9 WITH +/-2'-0" WIRE LENGTH FROM CEILING. VERIFY IN FIELD AND CONTACT ARCHITECT PRIOR TO INSTALLATION.
- INSTALL CL8 / CL9 WITH +/-4'-0" WIRE LENGTH FROM CEILING. VERIFY IN FIELD AND CONTACT ARCHITECT PRIOR TO INSTALLATION. 2 INSTALL CL8 / CL9 WITH +/-5'-0" WIRE LENGTH FROM CEILING. VERIFY IN FIELD AND

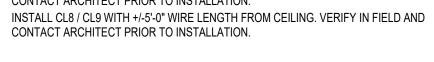




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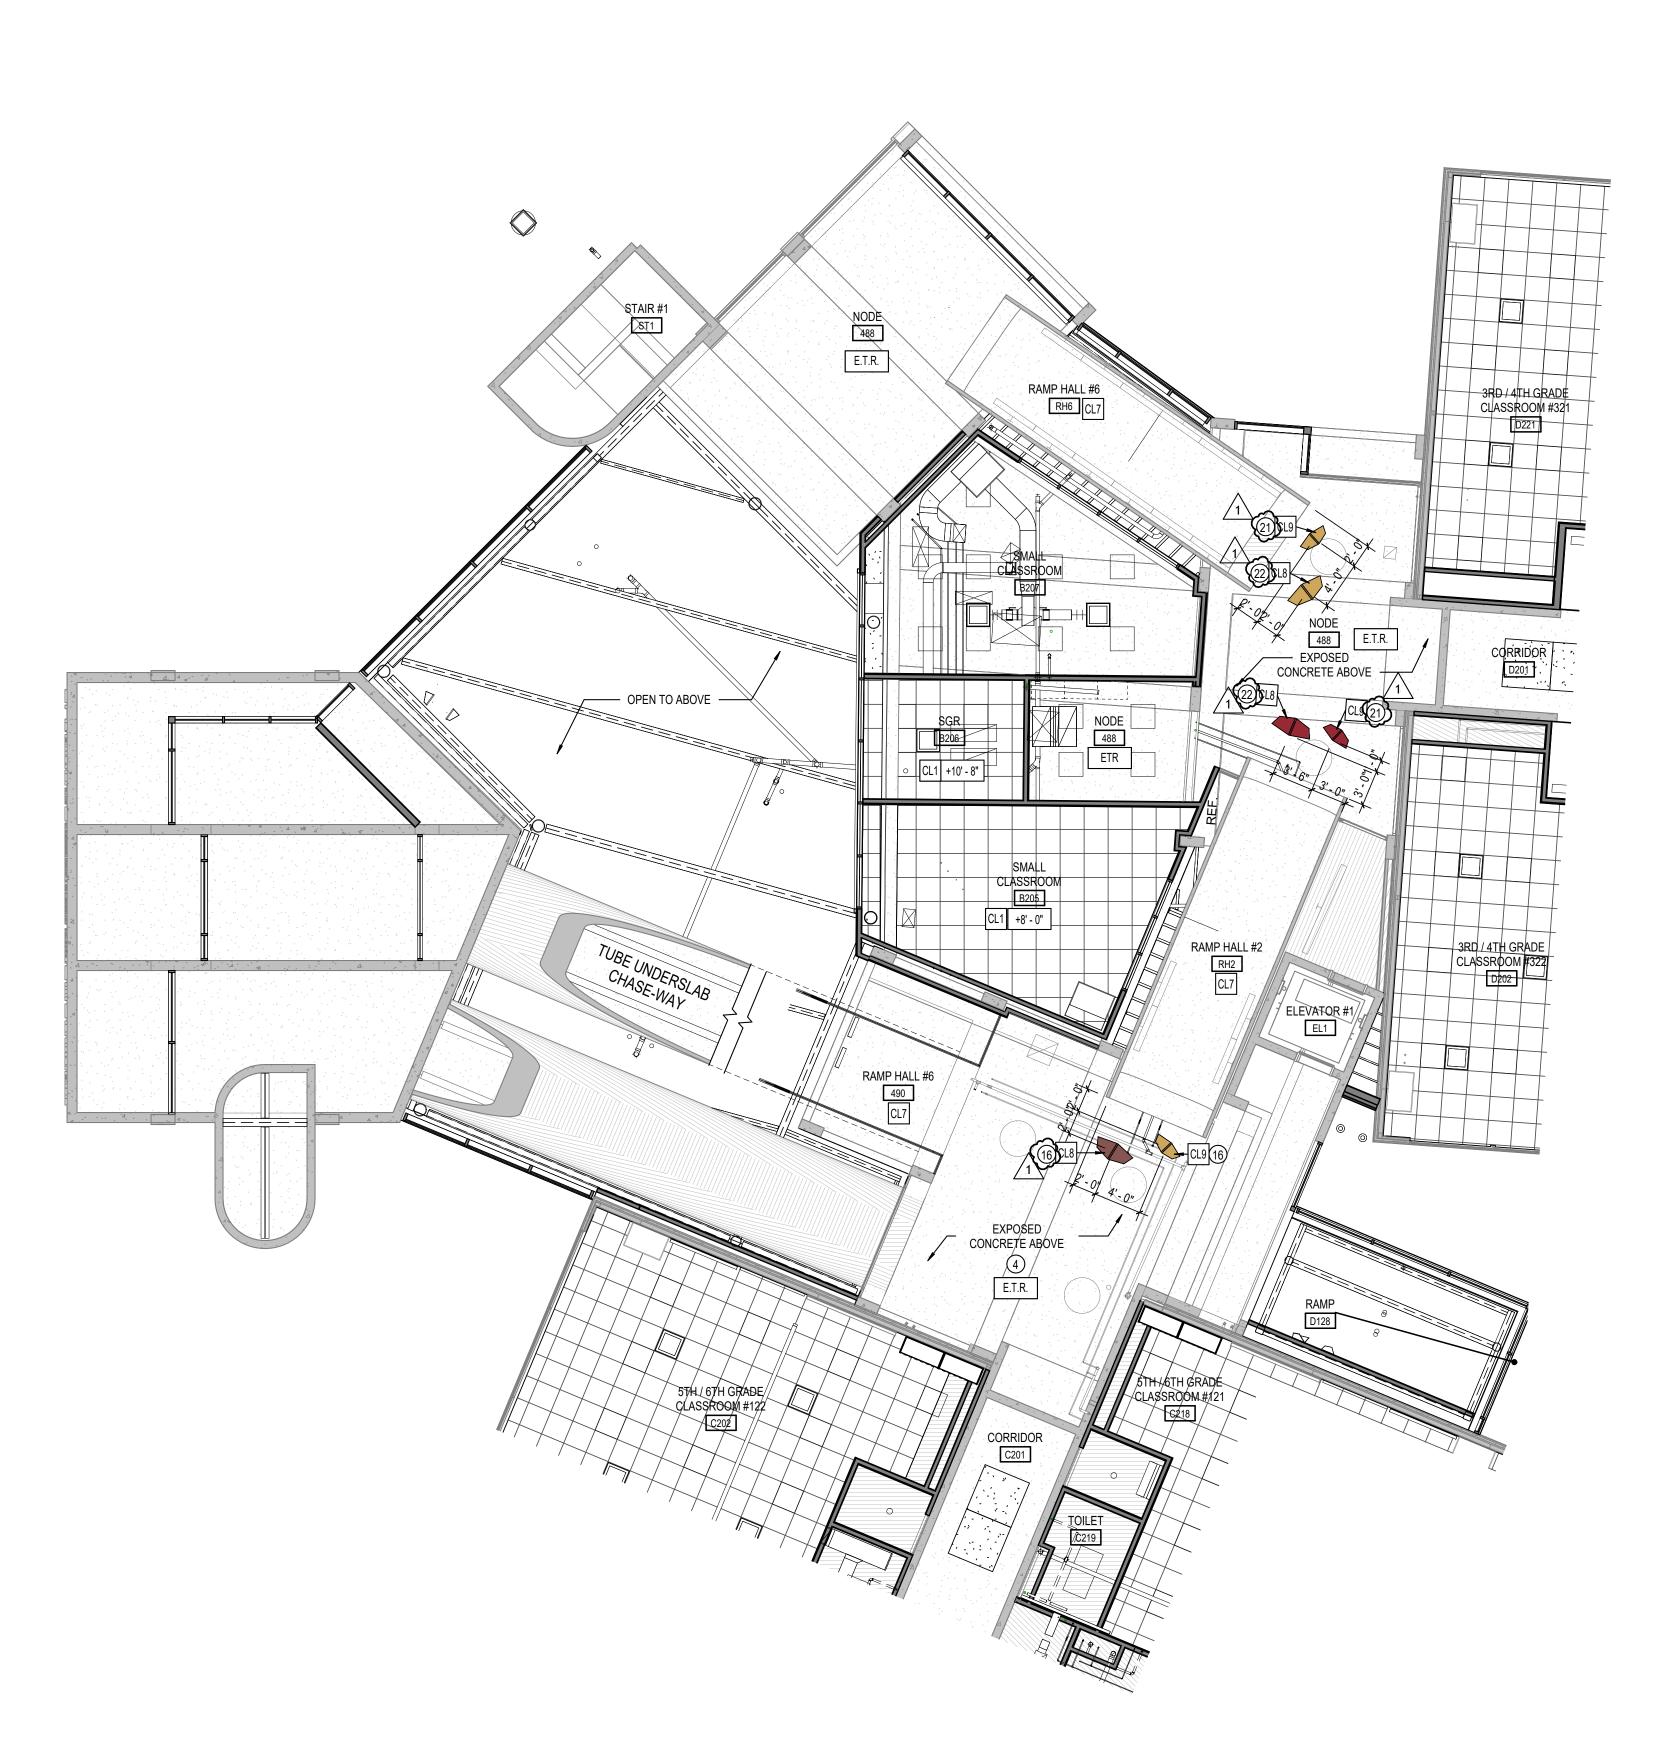
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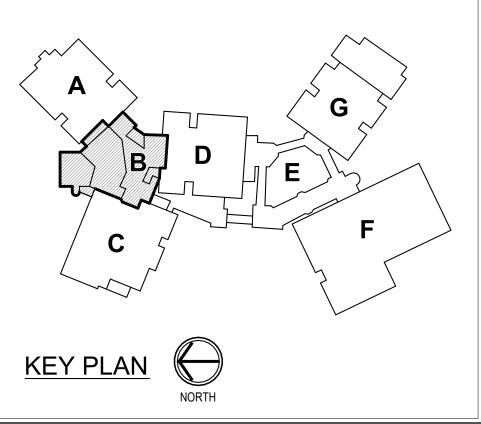
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SECOND LEVEL REFLECTED CEILING PLAN - UNIT B

A212B SCALE: 1/8" = 1'-0"




GENERAL REFLECTED **CEILING PLAN NOTES**

PET FINISH KEY

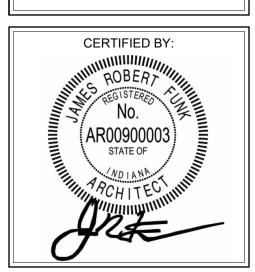SEE FINISH LEGEND ON A800.

- SEE THE ELECTRICAL DRAWINGS FOR SIZES, TYPES, AND QUANTITIES OF LIGHT FIXTURES, SPEAKERS, SMOKE DETECTORS, AND OTHER CEILING MOUNTED
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REFLECTED CEILING LEGEND

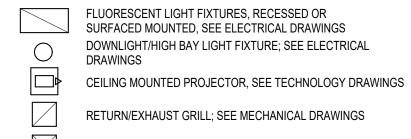

SUPPLY AIR GRILL; SEE MECHANICAL DRAWINGS LINEAR SLOT SUPPLY AIR GRILL; SEE MECHANICAL DRAWINGS SUSPENDED ACOUSTICAL LAY-IN CEILING MFG: ARMSTRONG MODEL #1713 STYLE: SCHOOL ZONE HIGH CAC, HIGH NRC

COLOR: WHITE SIZE: 24" x 24" x 3/4" LOCATION: CLASSROOMS SUSPENDED ACOUSTICAL LAY-IN CEILING MFG: ARMSTRONG MODEL #465 STYLE: SCHOOL ZONE HIGH DURABILITY DESCRIPTION: SQUARE EDGE COLOR: WHITE SIZE: 24" x 24" x 5/8" LOCATION: CORRIDORS

DESCRIPTION: SQUARE EDGE

SUSPENDED ACOUSTICAL LAY-IN CEILING MFG: ARMSTRONG MODEL #1935 STYLE: ULTIMA HEALTH ZONE DESCRIPTION: SQUARE EDGE COLOR: WHITE SIZE: 2' x 2' x 3/4" LOCATION: RESTROOMS/KITCHENS

SUSPENDED GYPSUM WALLBOARD CEILING SYSTEM USE 5/8" WALLBOARD PAINT: (P12) HIGH REFLECTIVE WHITE UNLESS NOTED OTHERWISE

GYPSUM WALLBOARD BULKHEAD PAINT; FOR COLOR REFER TO FINISH LEGEND ON A800.

TUBE INTERIOR - PAINTED SEE FINISH PLANS

STYLE: CUSTOM SIZE: LARGE COLOR: AS INDICATED ON PLAN; REFER TO PET FINISH KEY NOTE: CONTACT MICHELLE MOUSER AT MICHELLE@GREATAPG.COM FOR ADDITIONAL INFORMATION

SOUND ABSORBING CEILING UNIT

SOUND ABSORBING CEILING UNIT STYLE: CUSTOM SIZE: SMALL COLOR: AS INDICATED ON PLAN; REFER TO PET FINISH KEY NOTE: CONTACT MICHELLE MOUSER AT MICHELLE@GREATAPG.COM

FOR ADDITIONAL INFORMATION ACOUSTICAL CEILING PANELS MFG: ARMSTRONG STYLE: OPTIMA CAPZ, 3932 DESCRIPTION: SQUARE EDGE COLOR: WHITE (WH)

SIZE: 48" x 48" INSTALL: DIRECT ATTACH ACOUSTICAL CEILING PANELS STYLE: OPTIMA CAPZ, 3932 DESCRIPTION: SQUARE EDGE COLOR: WHITE (WH) SIZE: 48" x 48"

INSTALL: SUSPENDED CEILING ELEVATION MARK ABOVE FINISHED FLOOR (AT THAT LOCATION IF MULTIPLE FLOOR LEVELS ARE PRESENT)

EXISTING CEILING SYSTEM TO REMAIN

MATCH EXISTING CEILING HEIGHT


CEILING PAINT; REFER TO FINISH LEGEND ON A800.


© CEILING PLAN NOTES

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- EXISTING LIGHTING TO REMAIN. EXPOSED DECK AND DUCTWORK TO RECEIVE PAINT (P12). EXISTING BULKHEAD/CEILING TO REMAIN; PATCH, REPAIR, AND PAINT AS REQUIRED. INSTALL NEW CEILING PANELS BETWEEN EXISTING LIGHT FIXTURES. CENTER PANELS
- EXISTING BULKHEAD AT CORRIDOR WALL TO BE REMOVED AS REQUIRED TO INSTALL MATCH HEIGHT OF EXISTING ADJACENT BULKHEAD; COORDINATE WITH CASEWORK.

EVENLY IN EACH CORRIDOR AND BETWEEN EACH FIXTURE WHERE POSSIBLE.

- 10 EXISTING CONCRETE BEAM TO RECEIVE PAINT (P12) ALL EXPOSED FACES. ALL FACES AND UNDERSIDE OF BULKHEAD TO RECEIVE ARCHITECTURAL FILM (FM1).
- 12 GYPSUM WALL BOARD APPLIED TO BOTTOM OF DECK. 13 INSTALL CL8 / CL9 WITH +/-6'-6" WIRE LENGTH FROM CEILING. VERIFY IN FIELD AND CONTACT ARCHITECT PRIOR TO INSTALLATION. 14 INSTALL CL8 / CL9 WITH +/-7'-0" WIRE LENGTH FROM CEILING. VERIFY IN FIELD AND
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- 18 EXISTING METAL CEILING TO REMAIN; PAINT. 19 INSTALL NEW STEEL STRUCTURAL SUPPORT ABOVE CEILING TO STRUCTURE ABOVE AND PROVIDE HOOK AT CEILING FOR INSTALLATION OF SINGLE ATTACHMENT SENSORY SWING BY OWNER. PROVIDE 6' CLEAR RADIUS FROM HOOK TO ANY CABINETS, WALLS, ETC COORDINATE WITH OWNER..
- 0 INSTALL CL8 / CL9 WITH +/-2'-0" WIRE LENGTH FROM CEILING. VERIFY IN FIELD AND CONTACT ARCHITECT PRIOR TO INSTALLATION.
- INSTALL CL8 / CL9 WITH +/-4'-0" WIRE LENGTH FROM CEILING. VERIFY IN FIELD AND CONTACT ARCHITECT PRIOR TO INSTALLATION. 2 INSTALL CL8 / CL9 WITH +/-5'-0" WIRE LENGTH FROM CEILING. VERIFY IN FIELD AND

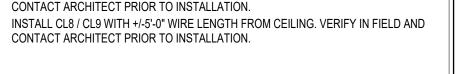

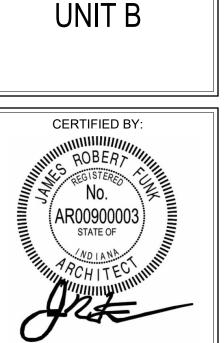

PROJECT NUMBER

DRAWING NUMBER

2024023

On the basis of the general scope indicated or described the trade contractors shall furnish all items required for the proper execution and completion of the work.


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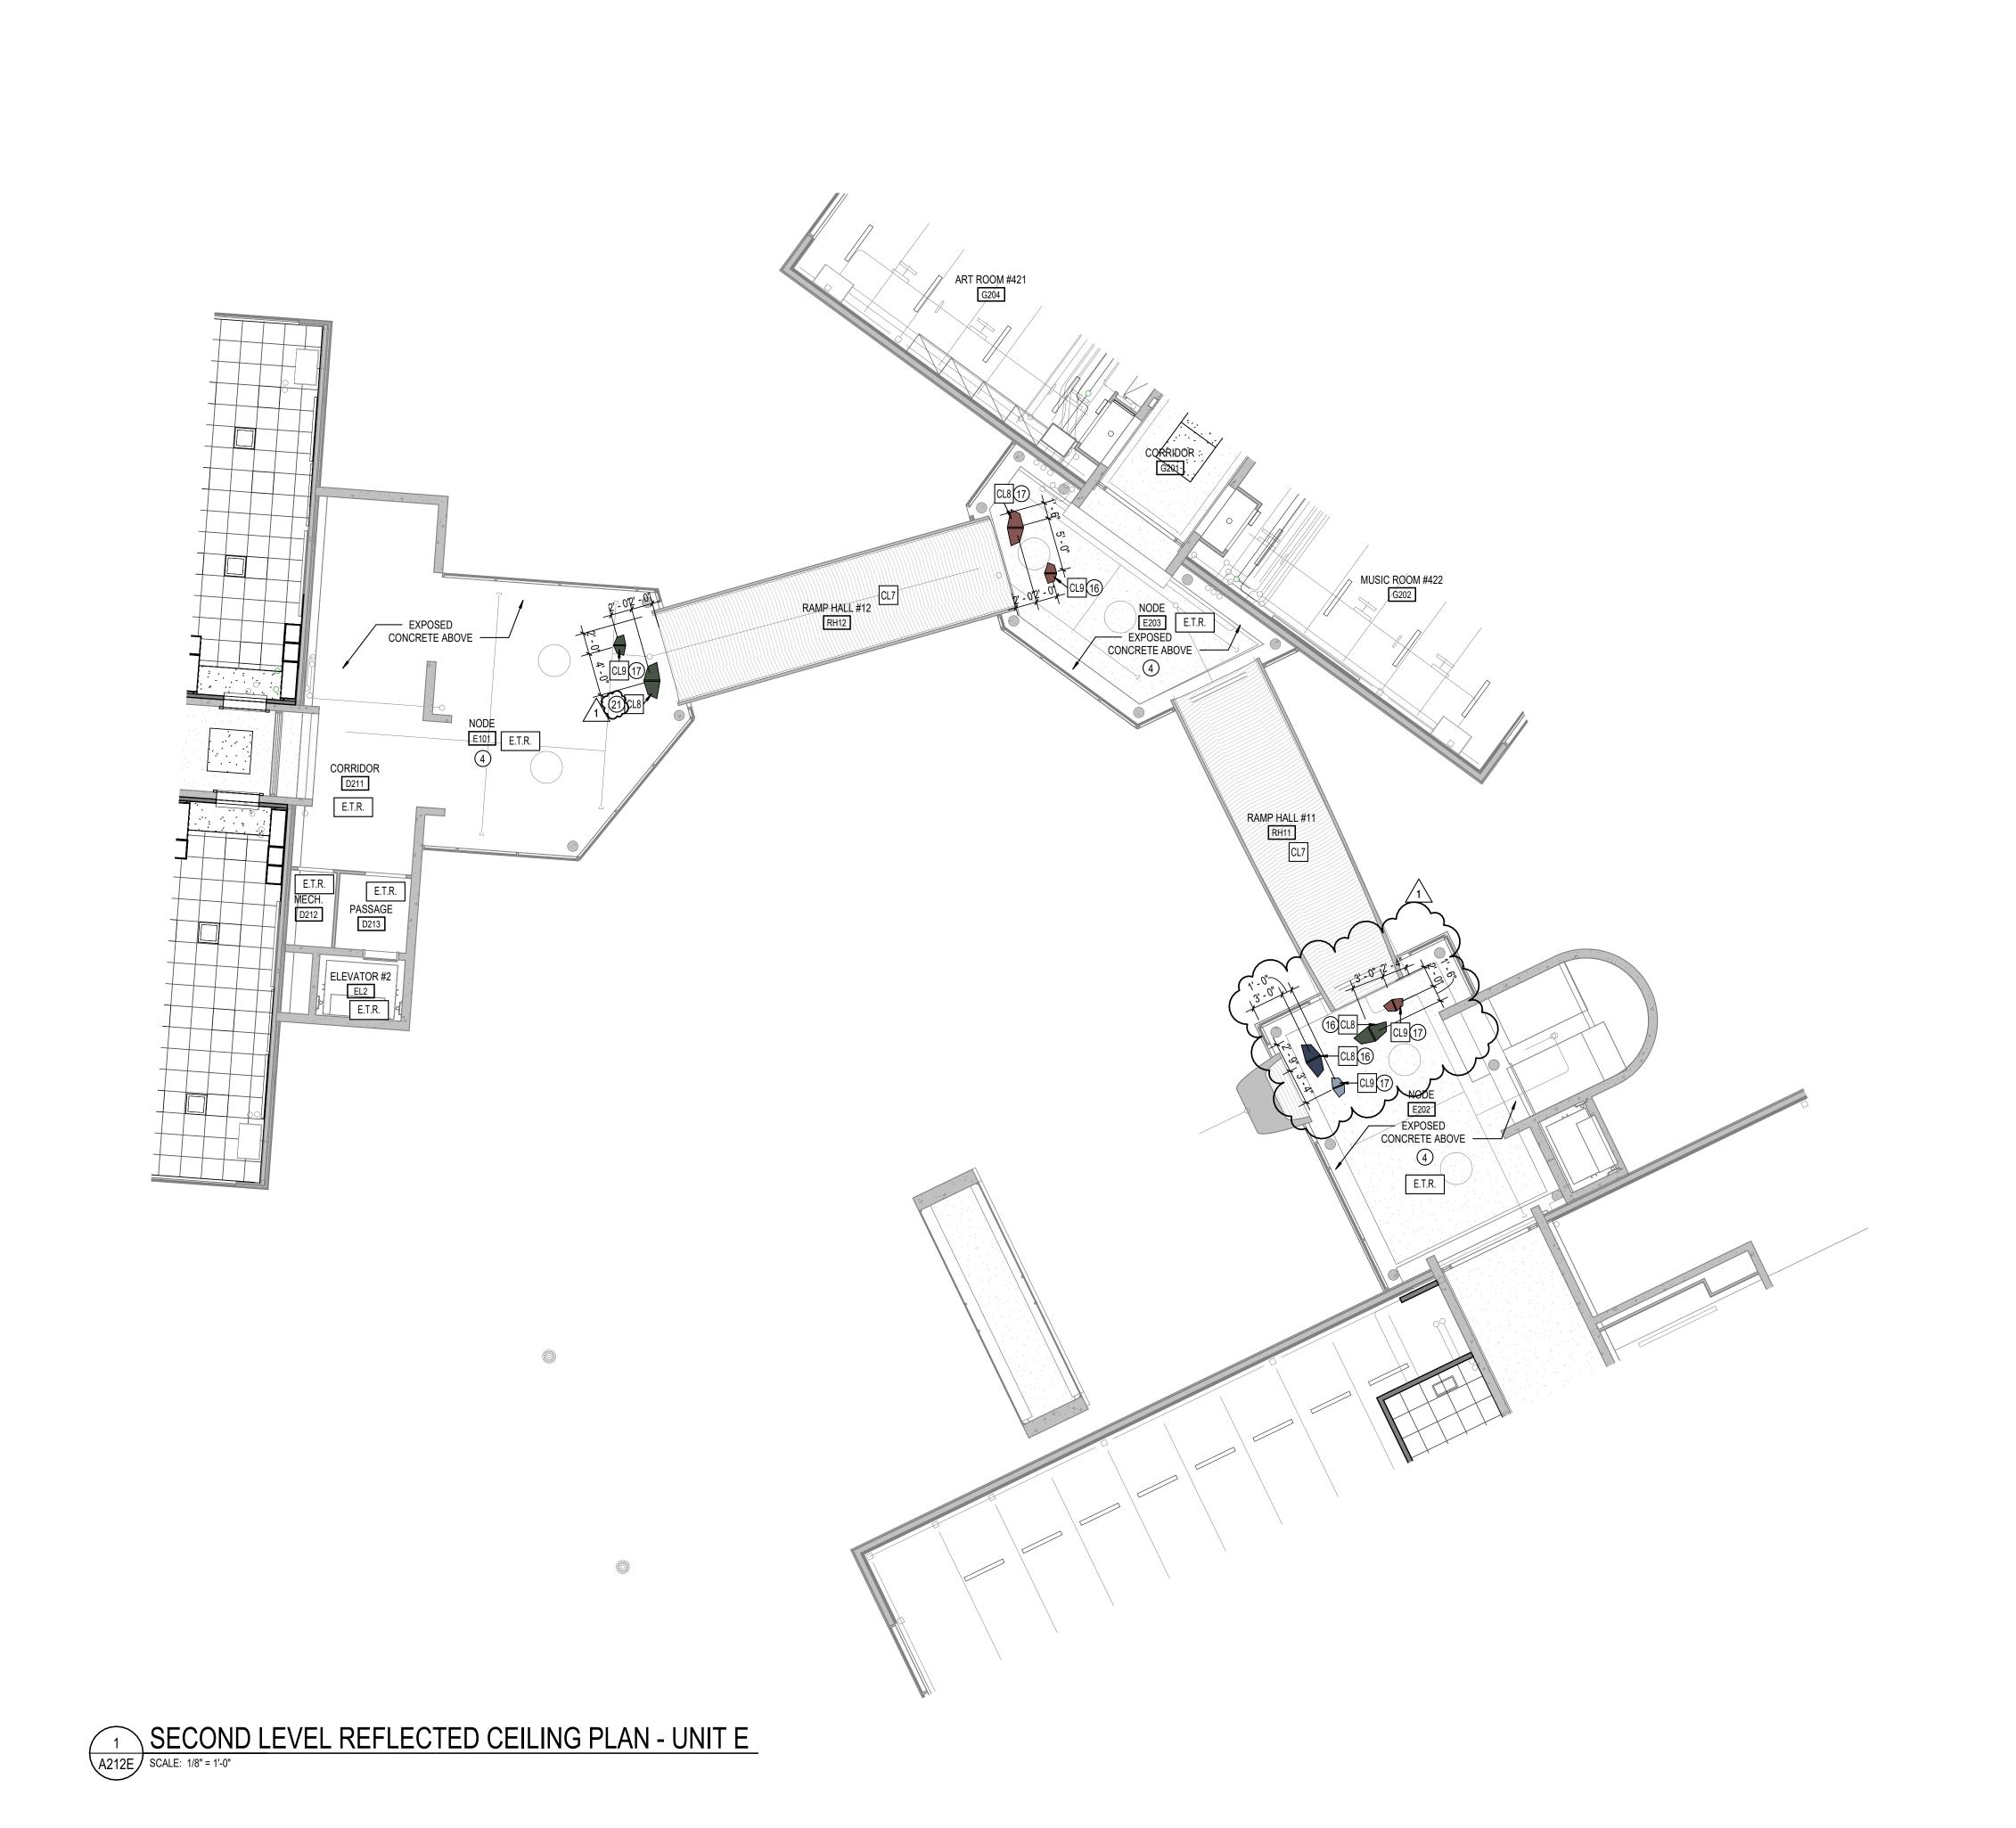
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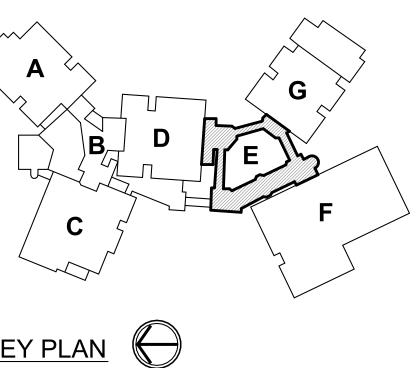
DRAWING TITLE:

REFLECTED

CEILING PLAN -





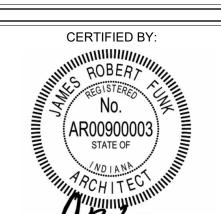

GENERAL REFLECTED **CEILING PLAN NOTES**

PET FINISH KEY

SEE FINISH LEGEND ON A800.

- SEE THE ELECTRICAL DRAWINGS FOR SIZES, TYPES, AND QUANTITIES OF LIGHT FIXTURES, SPEAKERS, SMOKE DETECTORS, AND OTHER CEILING MOUNTED
- ELECTRICAL DEVICES. SEE THE MECHANICAL DRAWINGS FOR SIZES, TYPES, AND QUANTITIES OF DIFFUSERS, GRILLES, AND OTHER MECHANICAL CEILING MOUNTED DEVICES. PROVIDE, FIELD LOCATE AND INSTALL 16"x16" FLUSH ACCESS PANELS AT ALL MECHANICAL AND PLUMBING PIPING VALVE LOCATIONS ABOVE SUSPENDED GYPSUM BOARD CEILINGS. SEE THE MECHANICAL, AND PLUMBING DRAWINGS
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REFLECTED CEILING LEGEND

FLUORESCENT LIGHT FIXTURES, RECESSED OR SURFACED MOUNTED, SEE ELECTRICAL DRAWINGS DOWNLIGHT/HIGH BAY LIGHT FIXTURE; SEE ELECTRICAL CEILING MOUNTED PROJECTOR, SEE TECHNOLOGY DRAWINGS RETURN/EXHAUST GRILL; SEE MECHANICAL DRAWINGS

LINEAR SLOT SUPPLY AIR GRILL; SEE MECHANICAL DRAWINGS SUSPENDED ACOUSTICAL LAY-IN CEILING MFG: ARMSTRONG MODEL #1713 STYLE: SCHOOL ZONE HIGH CAC, HIGH NRC DESCRIPTION: SQUARE EDGE

SUPPLY AIR GRILL; SEE MECHANICAL DRAWINGS

COLOR: WHITE SIZE: 24" x 24" x 3/4" LOCATION: CLASSROOMS SUSPENDED ACOUSTICAL LAY-IN CEILING MFG: ARMSTRONG MODEL #465 STYLE: SCHOOL ZONE HIGH DURABILITY DESCRIPTION: SQUARE EDGE COLOR: WHITE SIZE: 24" x 24" x 5/8" LOCATION: CORRIDORS

MFG: ARMSTRONG MODEL #1935 STYLE: ULTIMA HEALTH ZONE DESCRIPTION: SQUARE EDGE COLOR: WHITE SIZE: 2' x 2' x 3/4" LOCATION: RESTROOMS/KITCHENS SUSPENDED GYPSUM WALLBOARD CEILING SYSTEM USE 5/8" WALLBOARD

SUSPENDED ACOUSTICAL LAY-IN CEILING

PAINT: (P12) HIGH REFLECTIVE WHITE UNLESS NOTED OTHERWISE GYPSUM WALLBOARD BULKHEAD PAINT; FOR COLOR REFER TO FINISH LEGEND ON A800.

SOUND ABSORBING CEILING UNIT STYLE: CUSTOM SIZE: LARGE

COLOR: AS INDICATED ON PLAN; REFER TO PET FINISH KEY NOTE: CONTACT MICHELLE MOUSER AT MICHELLE@GREATAPG.COM FOR ADDITIONAL INFORMATION SOUND ABSORBING CEILING UNIT

TUBE INTERIOR - PAINTED SEE FINISH PLANS

SIZE: SMALL COLOR: AS INDICATED ON PLAN; REFER TO PET FINISH KEY NOTE: CONTACT MICHELLE MOUSER AT MICHELLE@GREATAPG.COM FOR ADDITIONAL INFORMATION ACOUSTICAL CEILING PANELS

STYLE: CUSTOM

MFG: ARMSTRONG STYLE: OPTIMA CAPZ, 3932 DESCRIPTION: SQUARE EDGE COLOR: WHITE (WH) SIZE: 48" x 48" INSTALL: DIRECT ATTACH

ACOUSTICAL CEILING PANELS MFG: ARMSTRONG STYLE: OPTIMA CAPZ, 3932 DESCRIPTION: SQUARE EDGE COLOR: WHITE (WH) SIZE: 48" x 48" INSTALL: SUSPENDED

CEILING ELEVATION MARK ABOVE FINISHED FLOOR (AT THAT LOCATION IF MULTIPLE FLOOR LEVELS ARE PRESENT)

EXISTING CEILING SYSTEM TO REMAIN

MATCH EXISTING CEILING HEIGHT

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- ETC COORDINATE WITH OWNER.. 0 INSTALL CL8 / CL9 WITH +/-2'-0" WIRE LENGTH FROM CEILING. VERIFY IN FIELD AND CONTACT ARCHITECT PRIOR TO INSTALLATION.
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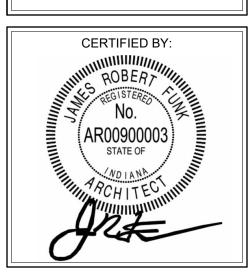
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01/15/2025 ZER DRAWING TITLE:

REFLECTED CEILING PLAN -




DRAWING NUMBER



1 UPPER LEVEL REFLECTED CEILING PLAN - UNIT B

A213B SCALE: 1/8" = 1'-0"

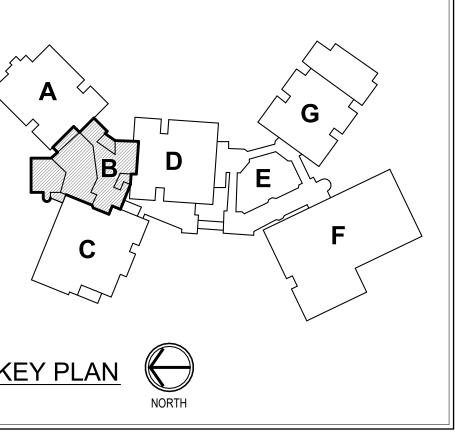


GENERAL REFLECTED **CEILING PLAN NOTES**

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REFLECTED CEILING LEGEND



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DESCRIPTION: SQUARE EDGE COLOR: WHITE SIZE: 24" x 24" x 3/4" LOCATION: CLASSROOMS SUSPENDED ACOUSTICAL LAY-IN CEILING MFG: ARMSTRONG MODEL #465 STYLE: SCHOOL ZONE HIGH DURABILITY DESCRIPTION: SQUARE EDGE COLOR: WHITE SIZE: 24" x 24" x 5/8"

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TUBE INTERIOR - PAINTED SEE FINISH PLANS

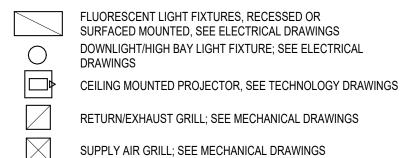STYLE: CUSTOM SIZE: LARGE COLOR: AS INDICATED ON PLAN; REFER TO PET FINISH KEY NOTE: CONTACT MICHELLE MOUSER AT MICHELLE@GREATAPG.COM FOR ADDITIONAL INFORMATION

SOUND ABSORBING CEILING UNIT

SOUND ABSORBING CEILING UNIT

MFG: TURF STYLE: CUSTOM SIZE: SMALL COLOR: AS INDICATED ON PLAN; REFER TO PET FINISH KEY NOTE: CONTACT MICHELLE MOUSER AT MICHELLE@GREATAPG.COM FOR ADDITIONAL INFORMATION

ACOUSTICAL CEILING PANELS MFG: ARMSTRONG STYLE: OPTIMA CAPZ, 3932 DESCRIPTION: SQUARE EDGE COLOR: WHITE (WH) SIZE: 48" x 48"

INSTALL: DIRECT ATTACH ACOUSTICAL CEILING PANELS MFG: ARMSTRONG STYLE: OPTIMA CAPZ, 3932 DESCRIPTION: SQUARE EDGE COLOR: WHITE (WH) SIZE: 48" x 48" INSTALL: SUSPENDED

CEILING ELEVATION MARK ABOVE FINISHED FLOOR (AT THAT LOCATION IF MULTIPLE FLOOR LEVELS ARE PRESENT)

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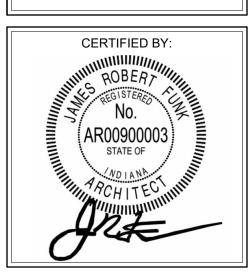
SCOPE DRAWINGS: These drawings indicate the general scope of the projec in terms of architectural design concept, the dimensions of the building, the major architectural elements and the type of structural, mechanical and electrical systems.

The drawings do not necessarily indicate or describe al On the basis of the general scope indicated or described the trade contractors shall furnish all items required for the proper execution and completion of the work.


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DRAWING TITLE: REFLECTED CEILING PLAN -



DRAWING NUMBER



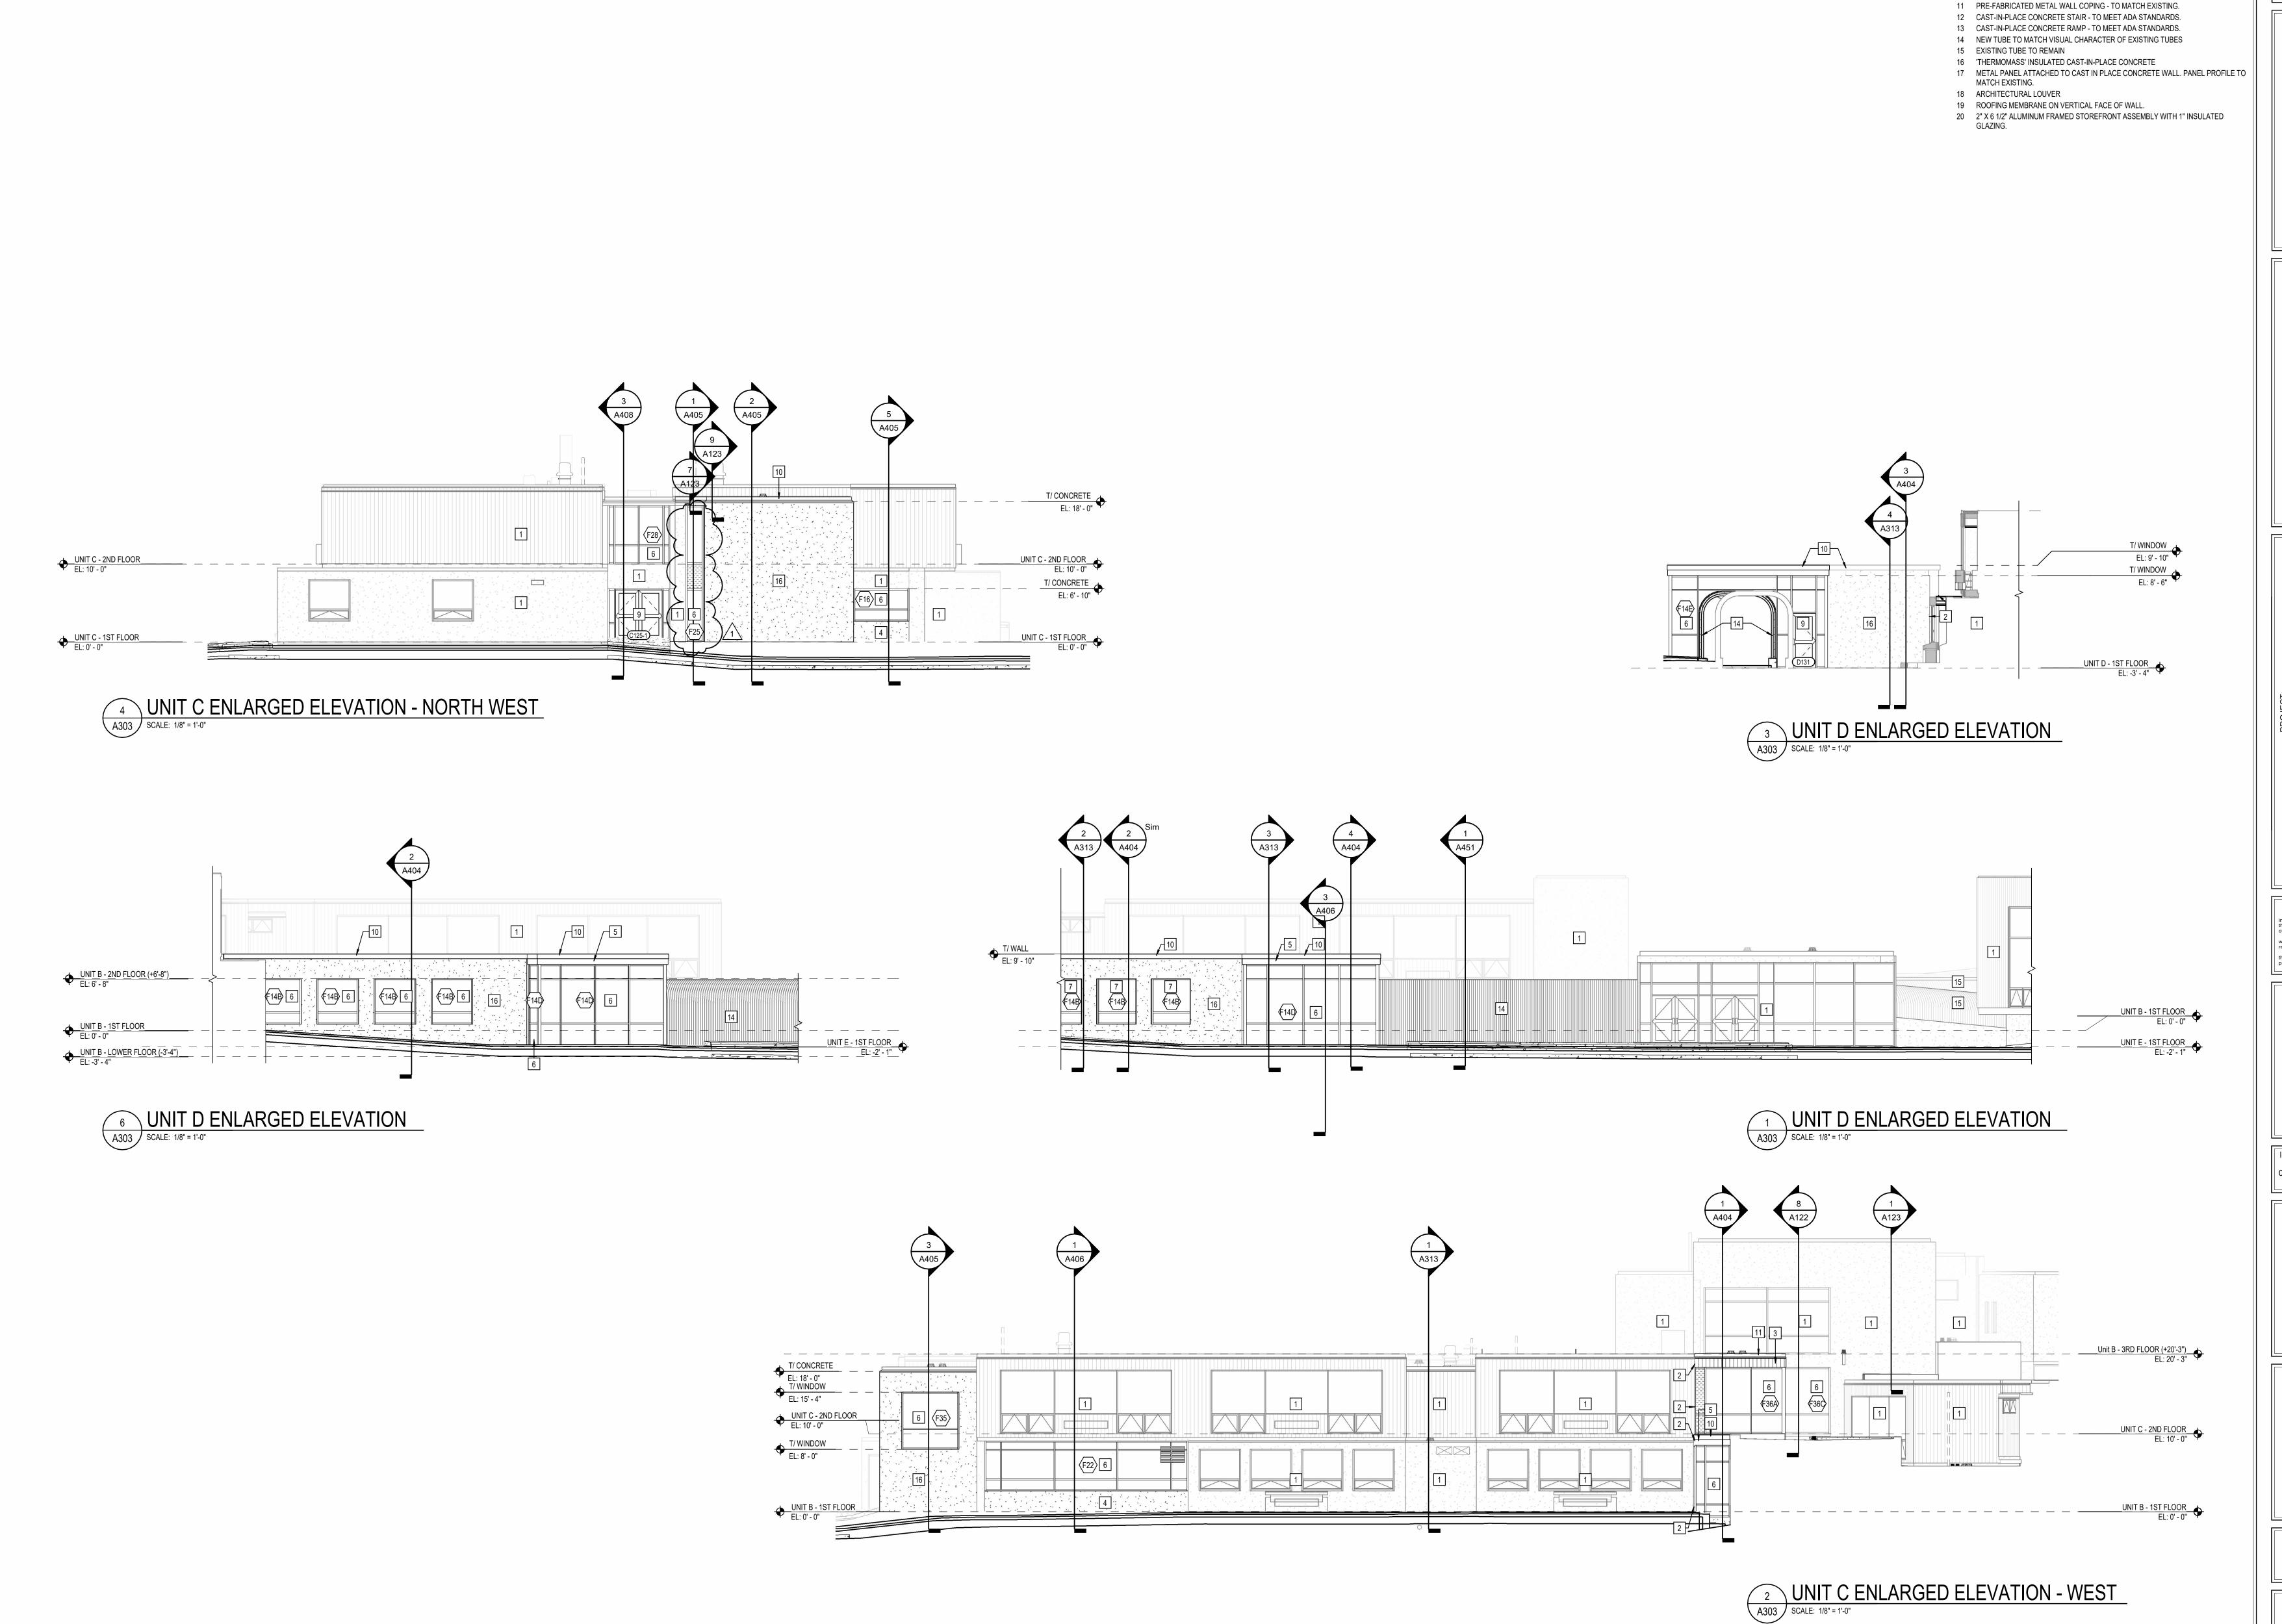

ELEVATION NOTES

3 PREFORMED METAL PANEL WALL SYSTEM - TO MATCH EXISTING.

9 ALUMINUM STOREFRONT DOOR AND FRAME - SEE SCHEDULE.
 10 PRE-FABRICATED METAL DRIP EDGE - TO MATCH EXISTING.

6 2" X 4 1/2" ALUMINUM FRAMED STOREFRONT ASSEMBLY WITH 1" INSULATED

7 2 1/4" X 7 1/2" ALUMINUM FRAMED CURTAIN WALL ASSEMBLY WITH 1" INSULATED

1 EXISTING BUILDING.

2 2" EXTERIOR EXPANSION JOINT

4 CAST-IN-PLACE CONCRETE
5 COMPOSITE METAL WALL PANELS

8831 Keystone Crossing, Indianapolis, IN 46240

THOLOMEW CONSOLIDATED SCHOOL CORPORATION
OVATIONS AND ADDITIONS TO NICES SMITH ELEMENTAR

SCOPE DRAWINGS:

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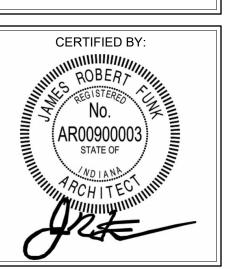
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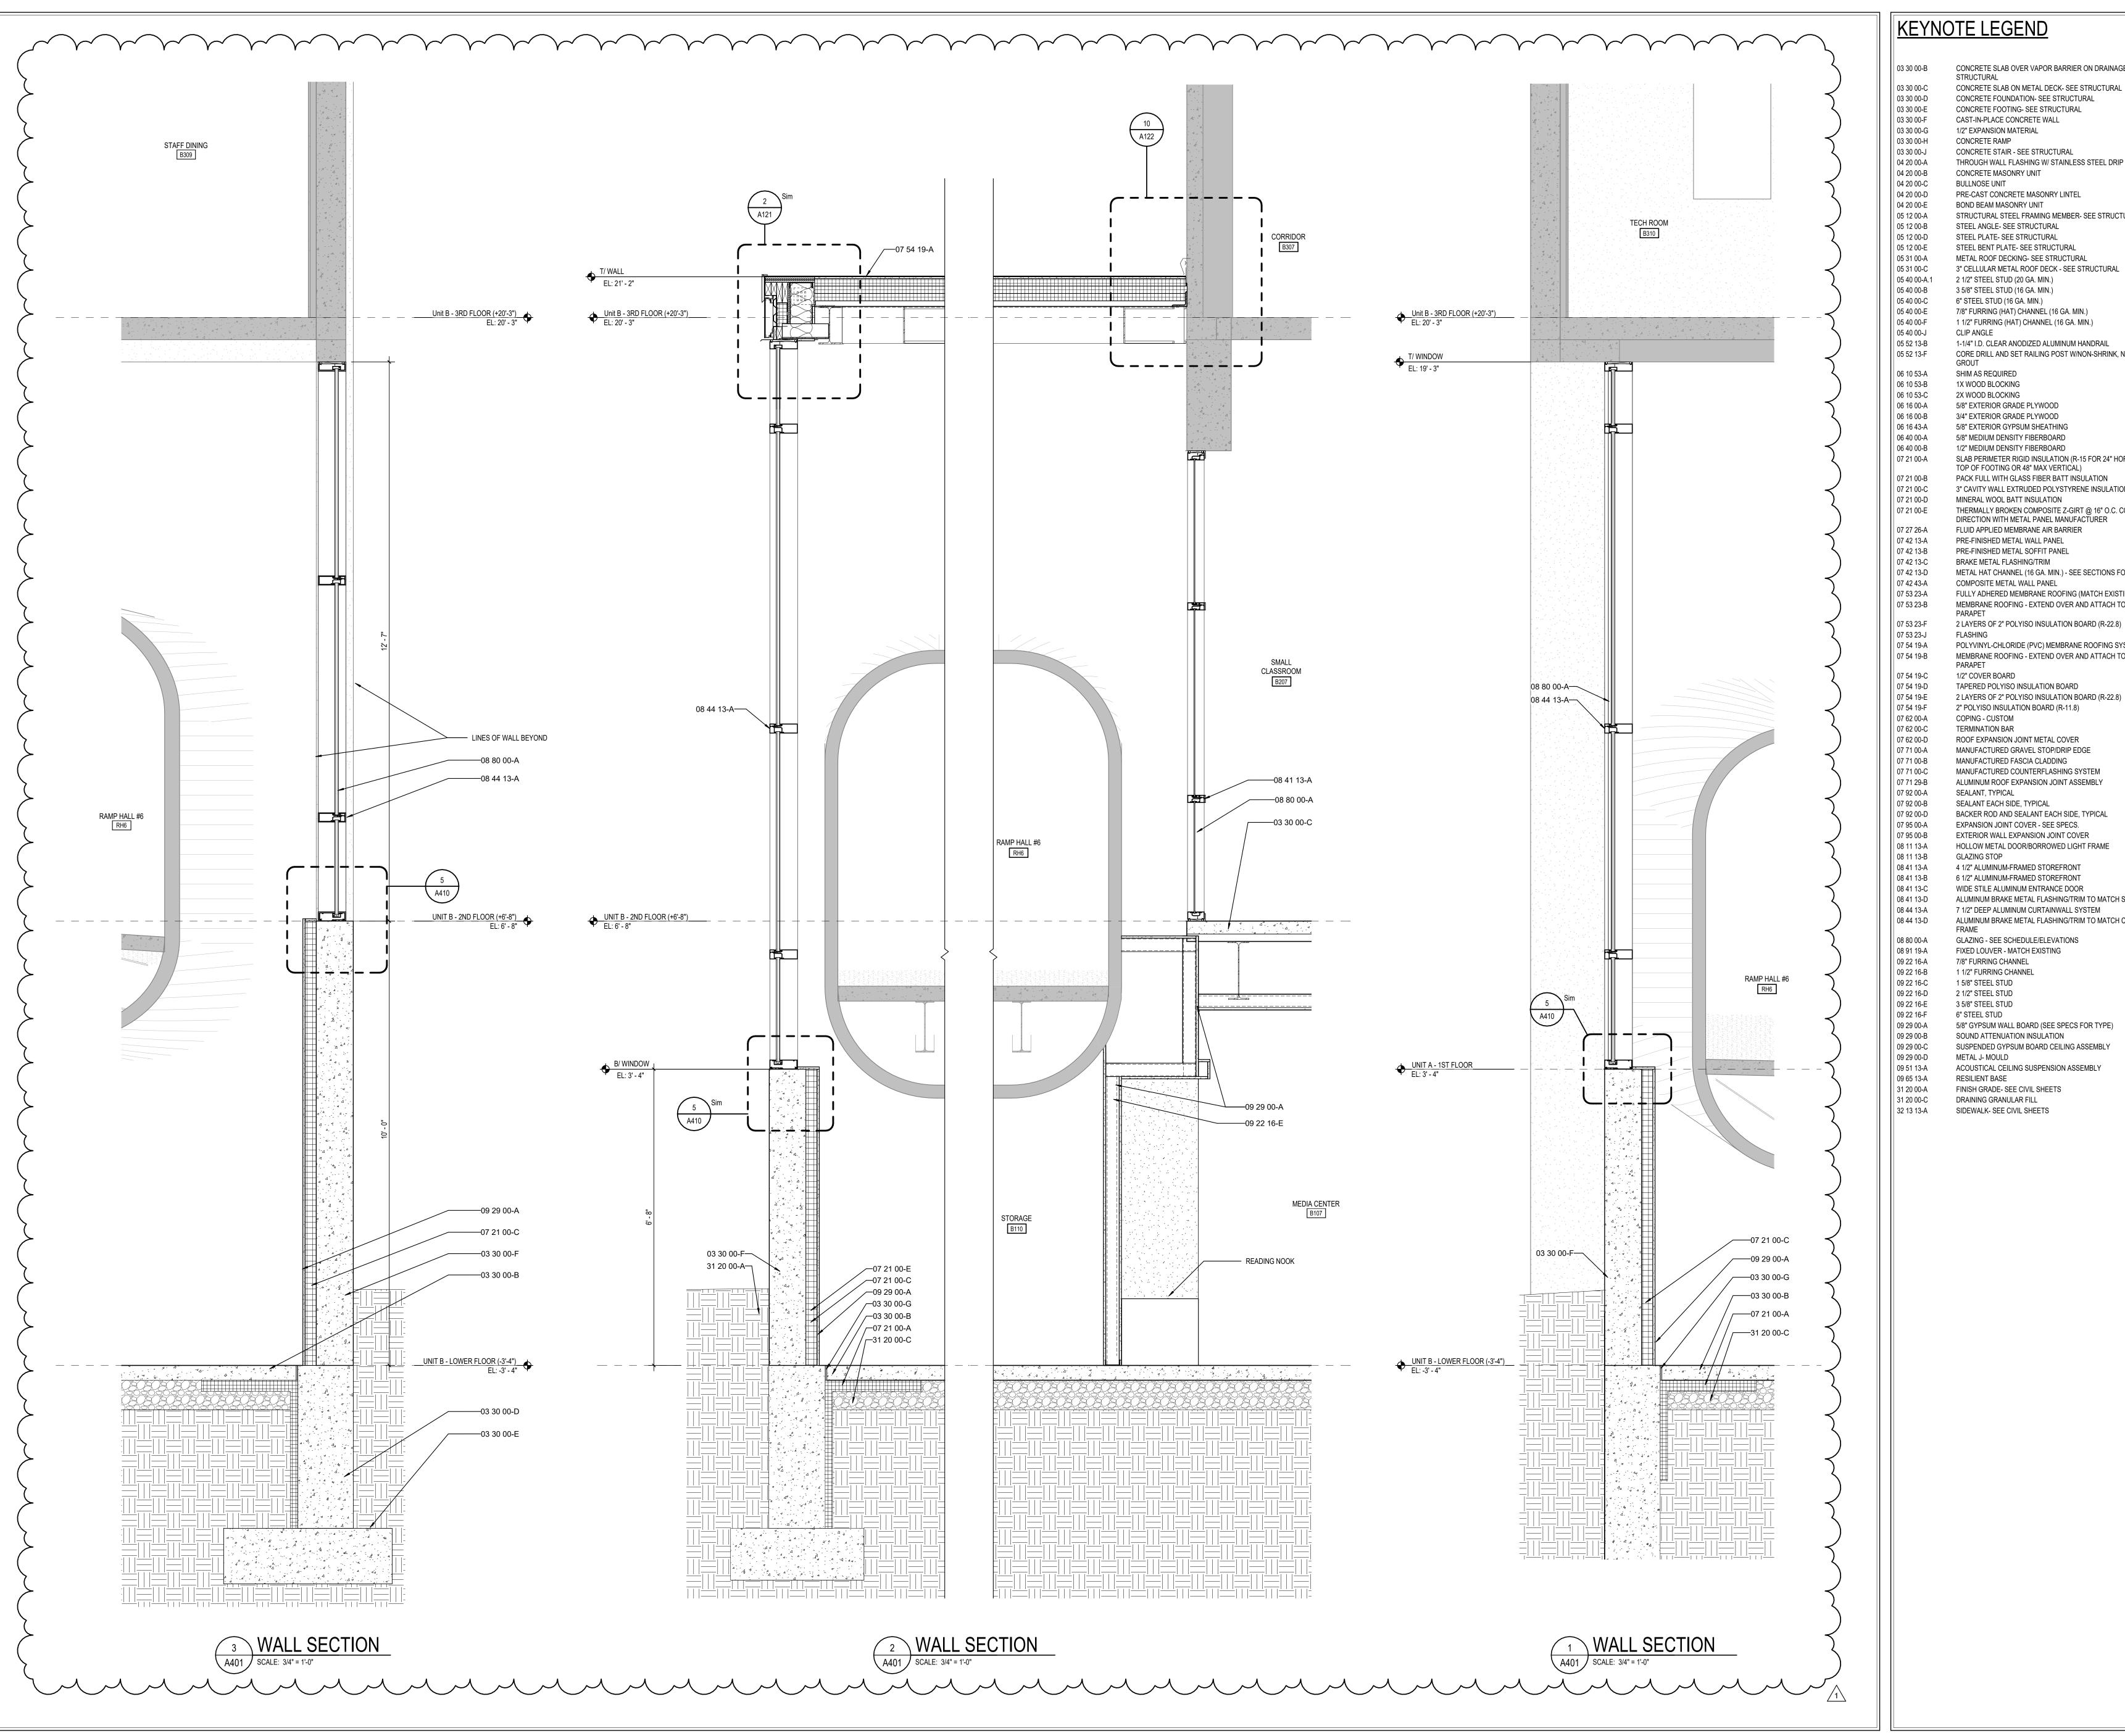
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ENLARGED
BUILDING
ELEVATIONS



A303



CONCRETE SLAB OVER VAPOR BARRIER ON DRAINAGE FILL. SEE CONCRETE SLAB ON METAL DECK- SEE STRUCTURAL CONCRETE FOUNDATION- SEE STRUCTURAL CONCRETE FOOTING- SEE STRUCTURAL

THROUGH WALL FLASHING W/ STAINLESS STEEL DRIP EDGE PRE-CAST CONCRETE MASONRY LINTEL

STRUCTURAL STEEL FRAMING MEMBER- SEE STRUCTURAL

7/8" FURRING (HAT) CHANNEL (16 GA. MIN.) 1 1/2" FURRING (HAT) CHANNEL (16 GA. MIN.)

1-1/4" I.D. CLEAR ANODIZED ALUMINUM HANDRAIL CORE DRILL AND SET RAILING POST W/NON-SHRINK, NON-METALLIC

07 21 00-A SLAB PERIMETER RIGID INSULATION (R-15 FOR 24" HORIZONTAL R-10 TO

07 21 00-B PACK FULL WITH GLASS FIBER BATT INSULATION 07 21 00-C 3" CAVITY WALL EXTRUDED POLYSTYRENE INSULATION (R-16.8) THERMALLY BROKEN COMPOSITE Z-GIRT @ 16" O.C. COORDINATE DIRECTION WITH METAL PANEL MANUFACTURER FLUID APPLIED MEMBRANE AIR BARRIER

METAL HAT CHANNEL (16 GA. MIN.) - SEE SECTIONS FOR DEPTH FULLY ADHERED MEMBRANE ROOFING (MATCH EXISTING) MEMBRANE ROOFING - EXTEND OVER AND ATTACH TO FRONT FACE OF

2 LAYERS OF 2" POLYISO INSULATION BOARD (R-22.8) POLYVINYL-CHLORIDE (PVC) MEMBRANE ROOFING SYSTEM MEMBRANE ROOFING - EXTEND OVER AND ATTACH TO FRONT FACE OF

TAPERED POLYISO INSULATION BOARD 07 54 19-E 2 LAYERS OF 2" POLYISO INSULATION BOARD (R-22.8) 07 54 19-F 2" POLYISO INSULATION BOARD (R-11.8)

ROOF EXPANSION JOINT METAL COVER MANUFACTURED GRAVEL STOP/DRIP EDGE MANUFACTURED COUNTERFLASHING SYSTEM ALUMINUM ROOF EXPANSION JOINT ASSEMBLY

BACKER ROD AND SEALANT EACH SIDE, TYPICAL EXTERIOR WALL EXPANSION JOINT COVER HOLLOW METAL DOOR/BORROWED LIGHT FRAME

6 1/2" ALUMINUM-FRAMED STOREFRONT WIDE STILE ALUMINUM ENTRANCE DOOR ALUMINUM BRAKE METAL FLASHING/TRIM TO MATCH STOREFRONT 7 1/2" DEEP ALUMINUM CURTAINWALL SYSTEM ALUMINUM BRAKE METAL FLASHING/TRIM TO MATCH CURTAINWALL

5/8" GYPSUM WALL BOARD (SEE SPECS FOR TYPE) SUSPENDED GYPSUM BOARD CEILING ASSEMBLY ACOUSTICAL CEILING SUSPENSION ASSEMBLY




SCOPE DRAWINGS:

ADDENDUM #1 01/29/2025

REVISIONS:


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DRAWING TITLE:

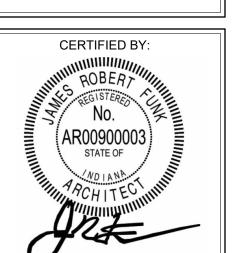

DRAWING NUMBER A401 PROJECT NUMBER

2024023



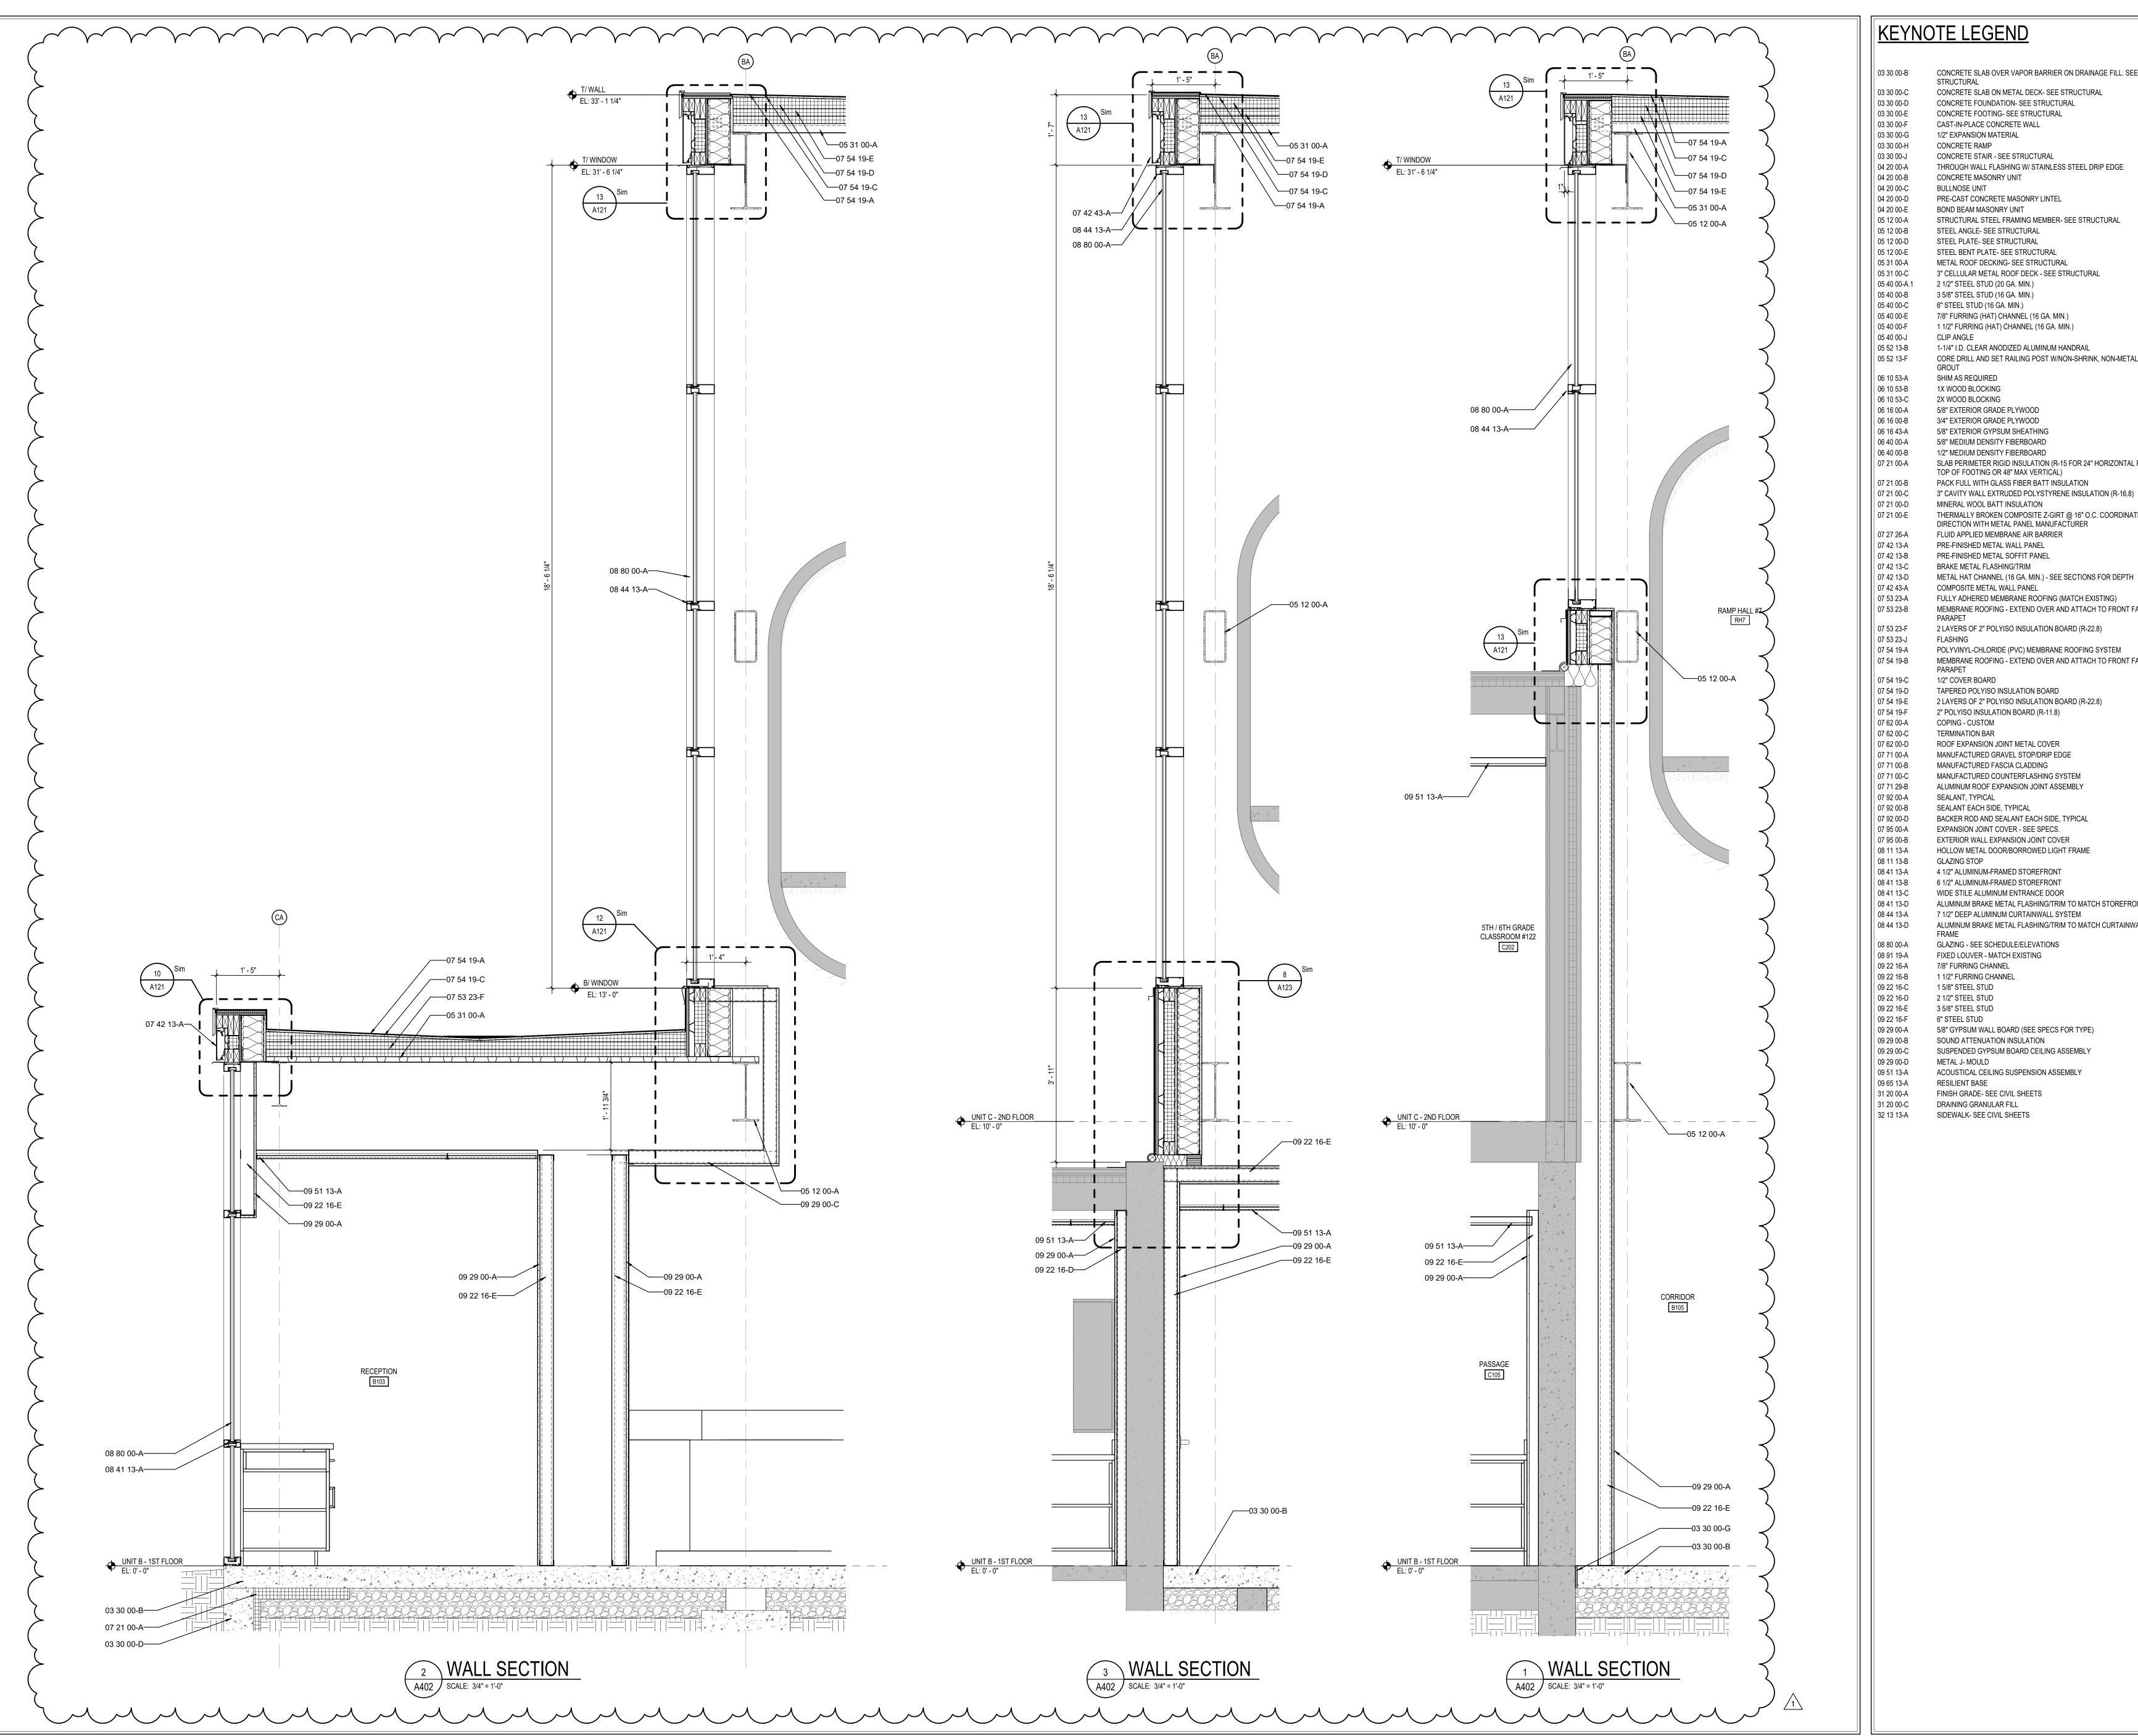

CONCRETE SLAB OVER VAPOR BARRIER ON DRAINAGE FILL. SEE CONCRETE SLAB ON METAL DECK- SEE STRUCTURAL CONCRETE FOUNDATION- SEE STRUCTURAL

CONCRETE FOOTING- SEE STRUCTURAL CAST-IN-PLACE CONCRETE WALL

1/2" EXPANSION MATERIAL CONCRETE RAMP CONCRETE STAIR - SEE STRUCTURAL

THROUGH WALL FLASHING W/ STAINLESS STEEL DRIP EDGE CONCRETE MASONRY UNIT **BULLNOSE UNIT** PRE-CAST CONCRETE MASONRY LINTEL

BOND BEAM MASONRY UNIT STRUCTURAL STEEL FRAMING MEMBER- SEE STRUCTURAL STEEL ANGLE- SEE STRUCTURAL STEEL PLATE- SEE STRUCTURAL STEEL BENT PLATE- SEE STRUCTURAL

2 1/2" STEEL STUD (20 GA. MIN.) 3 5/8" STEEL STUD (16 GA. MIN.) 6" STEEL STUD (16 GA. MIN.) 7/8" FURRING (HAT) CHANNEL (16 GA. MIN.) 1 1/2" FURRING (HAT) CHANNEL (16 GA. MIN.)

1-1/4" I.D. CLEAR ANODIZED ALUMINUM HANDRAIL CORE DRILL AND SET RAILING POST W/NON-SHRINK, NON-METALLIC

SHIM AS REQUIRED 1X WOOD BLOCKING 2X WOOD BLOCKING 5/8" EXTERIOR GRADE PLYWOOD

5/8" MEDIUM DENSITY FIBERBOARD 1/2" MEDIUM DENSITY FIBERBOARD SLAB PERIMETER RIGID INSULATION (R-15 FOR 24" HORIZONTAL R-10 TO TOP OF FOOTING OR 48" MAX VERTICAL)

PACK FULL WITH GLASS FIBER BATT INSULATION 3" CAVITY WALL EXTRUDED POLYSTYRENE INSULATION (R-16.8) MINERAL WOOL BATT INSULATION THERMALLY BROKEN COMPOSITE Z-GIRT @ 16" O.C. COORDINATE

DIRECTION WITH METAL PANEL MANUFACTURER FLUID APPLIED MEMBRANE AIR BARRIER PRE-FINISHED METAL WALL PANEL PRE-FINISHED METAL SOFFIT PANEL BRAKE METAL FLASHING/TRIM

FULLY ADHERED MEMBRANE ROOFING (MATCH EXISTING) MEMBRANE ROOFING - EXTEND OVER AND ATTACH TO FRONT FACE OF 2 LAYERS OF 2" POLYISO INSULATION BOARD (R-22.8)

POLYVINYL-CHLORIDE (PVC) MEMBRANE ROOFING SYSTEM MEMBRANE ROOFING - EXTEND OVER AND ATTACH TO FRONT FACE OF

TAPERED POLYISO INSULATION BOARD 2 LAYERS OF 2" POLYISO INSULATION BOARD (R-22.8) 2" POLYISO INSULATION BOARD (R-11.8)

COPING - CUSTOM TERMINATION BAR ROOF EXPANSION JOINT METAL COVER MANUFACTURED GRAVEL STOP/DRIP EDGE

MANUFACTURED FASCIA CLADDING MANUFACTURED COUNTERFLASHING SYSTEM ALUMINUM ROOF EXPANSION JOINT ASSEMBLY SEALANT, TYPICAL SEALANT EACH SIDE, TYPICAL

EXPANSION JOINT COVER - SEE SPECS. EXTERIOR WALL EXPANSION JOINT COVER HOLLOW METAL DOOR/BORROWED LIGHT FRAME 4 1/2" ALUMINUM-FRAMED STOREFRONT

WIDE STILE ALUMINUM ENTRANCE DOOR ALUMINUM BRAKE METAL FLASHING/TRIM TO MATCH STOREFRONT 7 1/2" DEEP ALUMINUM CURTAINWALL SYSTEM ALUMINUM BRAKE METAL FLASHING/TRIM TO MATCH CURTAINWALL

GLAZING - SEE SCHEDULE/ELEVATIONS FIXED LOUVER - MATCH EXISTING 7/8" FURRING CHANNEL

2 1/2" STEEL STUD 3 5/8" STEEL STUD 5/8" GYPSUM WALL BOARD (SEE SPECS FOR TYPE)

SOUND ATTENUATION INSULATION SUSPENDED GYPSUM BOARD CEILING ASSEMBLY METAL J- MOULD ACOUSTICAL CEILING SUSPENSION ASSEMBLY

FINISH GRADE- SEE CIVIL SHEETS DRAINING GRANULAR FILL SIDEWALK- SEE CIVIL SHEETS


SCOPE DRAWINGS: These drawings indicate the general scope of the proje in terms of architectural design concept, the dimensions of the building, the major architectural elements and the type

ADDENDUM #1 01/29/2025


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DRAWING TITLE:



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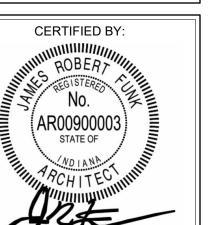


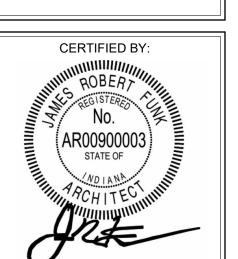SCOPE DRAWINGS: These drawings indicate the general scope of the proje in terms of architectural design concept, the dimensions of the building, the major architectural elements and the type


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DRAWING TITLE:

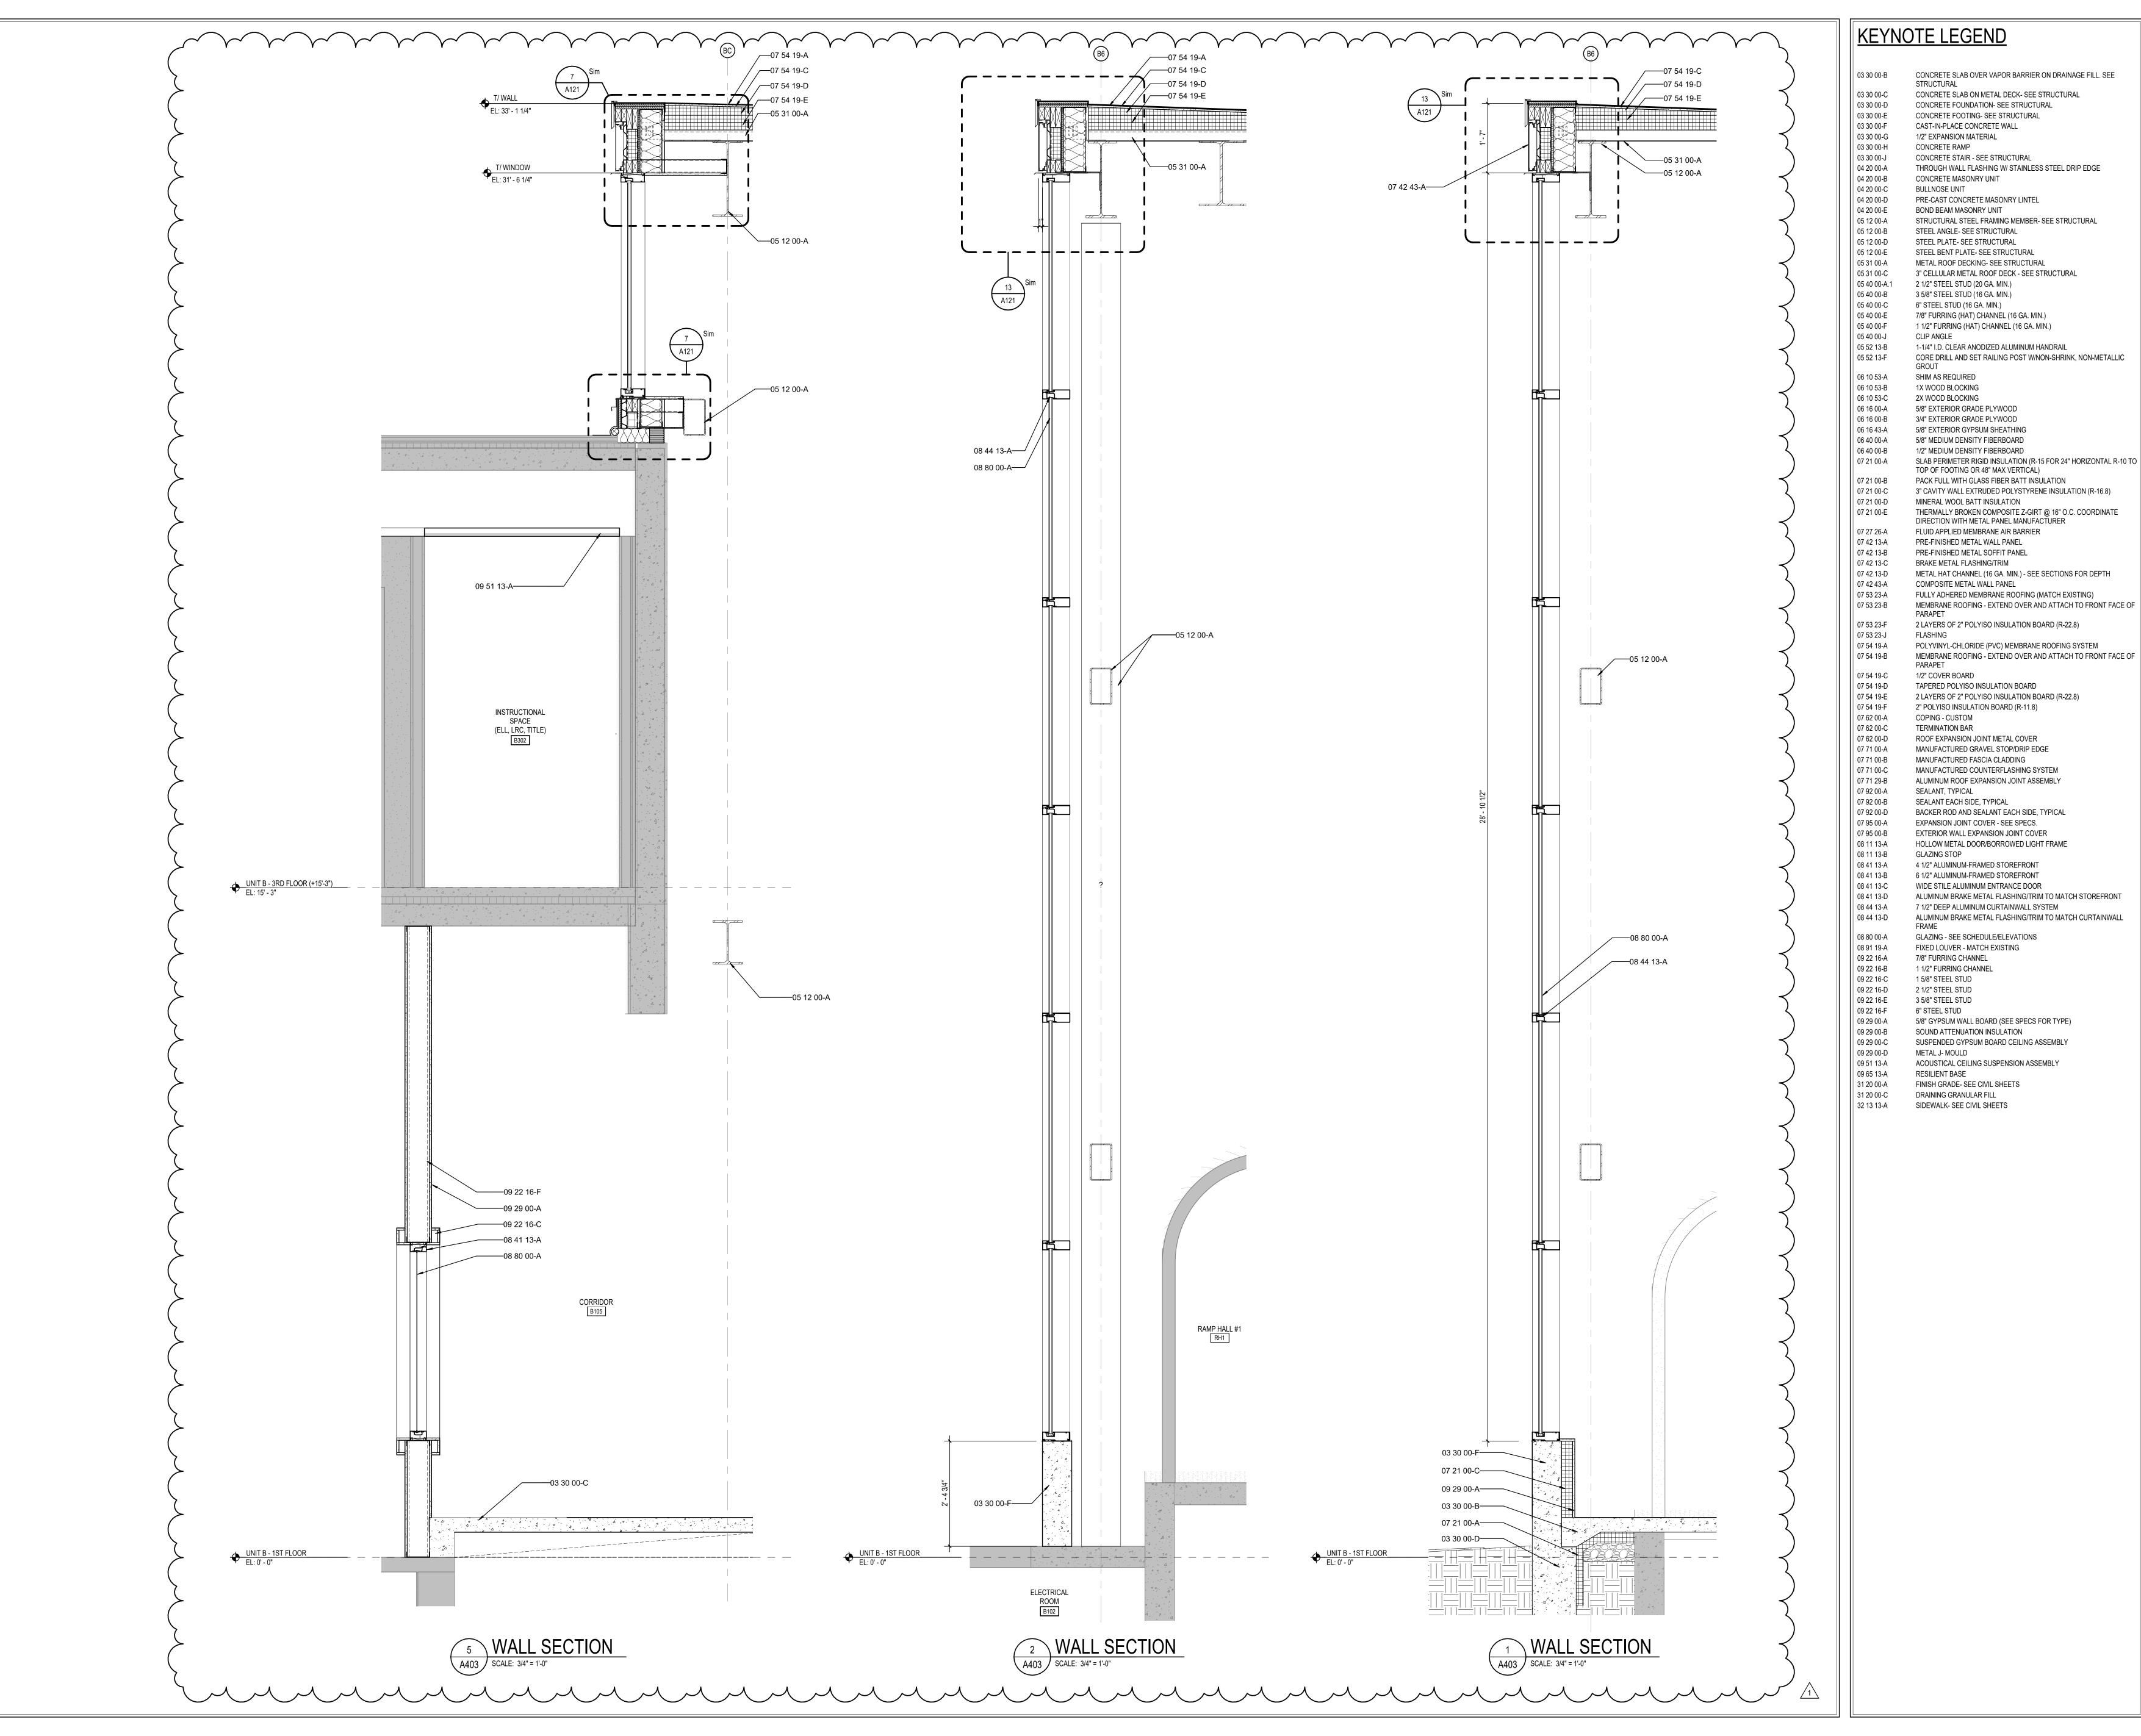

DRAWING NUMBER A403



KEYNOTE LEGEND

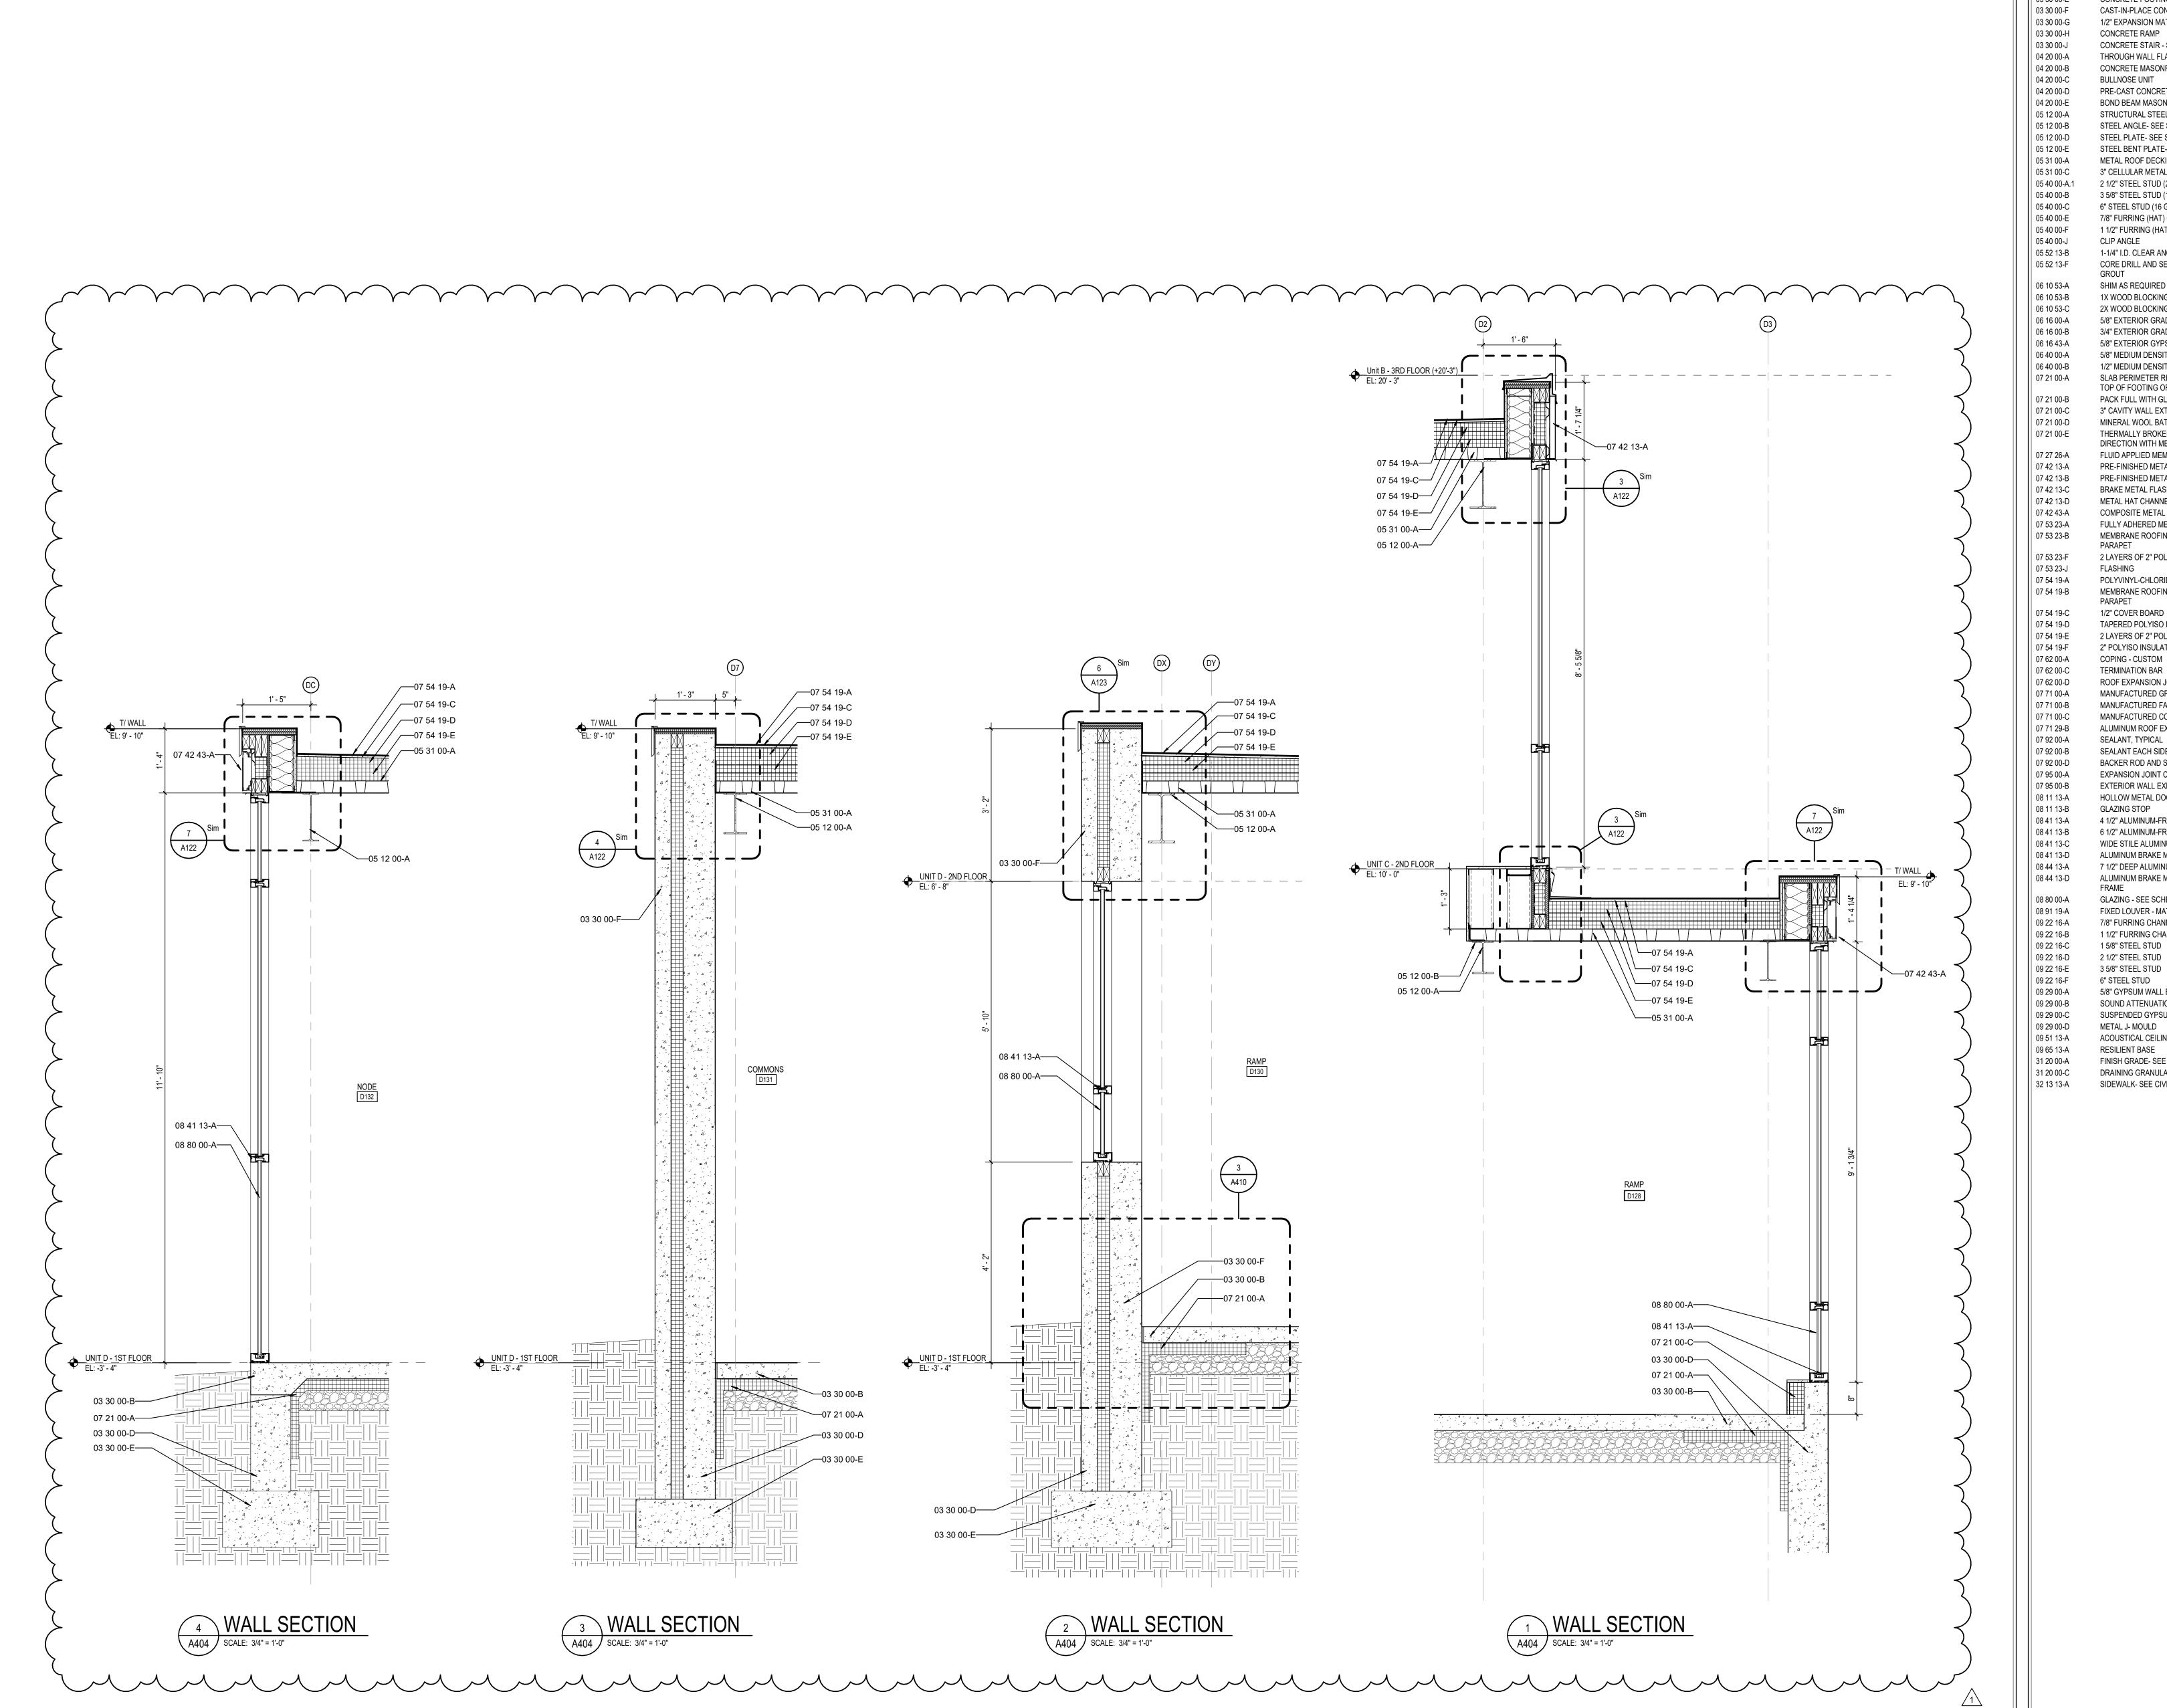CONCRETE SLAB OVER VAPOR BARRIER ON DRAINAGE FILL. SEE STRUCTURAL CONCRETE SLAB ON METAL DECK- SEE STRUCTURAL CONCRETE FOUNDATION- SEE STRUCTURAL

03 30 00-D 03 30 00-E CONCRETE FOOTING- SEE STRUCTURAL CAST-IN-PLACE CONCRETE WALL 1/2" EXPANSION MATERIAL

CONCRETE STAIR - SEE STRUCTURAL 04 20 00-A THROUGH WALL FLASHING W/ STAINLESS STEEL DRIP EDGE 04 20 00-B CONCRETE MASONRY UNIT

BULLNOSE UNIT PRE-CAST CONCRETE MASONRY LINTEL BOND BEAM MASONRY UNIT

STRUCTURAL STEEL FRAMING MEMBER- SEE STRUCTURAL STEEL ANGLE- SEE STRUCTURAL STEEL PLATE- SEE STRUCTURAL STEEL BENT PLATE- SEE STRUCTURAL METAL ROOF DECKING- SEE STRUCTURAL

05 31 00-C 3" CELLULAR METAL ROOF DECK - SEE STRUCTURAL 05 40 00-A.1 2 1/2" STEEL STUD (20 GA. MIN.) 3 5/8" STEEL STUD (16 GA. MIN.) 05 40 00-C 6" STEEL STUD (16 GA. MIN.) 7/8" FURRING (HAT) CHANNEL (16 GA. MIN.)

1 1/2" FURRING (HAT) CHANNEL (16 GA. MIN.) CLIP ANGLE 1-1/4" I.D. CLEAR ANODIZED ALUMINUM HANDRAIL CORE DRILL AND SET RAILING POST W/NON-SHRINK, NON-METALLIC

SHIM AS REQUIRED 1X WOOD BLOCKING

2X WOOD BLOCKING 5/8" EXTERIOR GRADE PLYWOOD 3/4" EXTERIOR GRADE PLYWOOD 5/8" EXTERIOR GYPSUM SHEATHING

5/8" MEDIUM DENSITY FIBERBOARD 06 40 00-B 1/2" MEDIUM DENSITY FIBERBOARD 07 21 00-A SLAB PERIMETER RIGID INSULATION (R-15 FOR 24" HORIZONTAL R-10 TO TOP OF FOOTING OR 48" MAX VERTICAL) 07 21 00-B PACK FULL WITH GLASS FIBER BATT INSULATION 3" CAVITY WALL EXTRUDED POLYSTYRENE INSULATION (R-16.8)

MINERAL WOOL BATT INSULATION THERMALLY BROKEN COMPOSITE Z-GIRT @ 16" O.C. COORDINATE DIRECTION WITH METAL PANEL MANUFACTURER FLUID APPLIED MEMBRANE AIR BARRIER PRE-FINISHED METAL WALL PANEL

PRE-FINISHED METAL SOFFIT PANEL BRAKE METAL FLASHING/TRIM METAL HAT CHANNEL (16 GA. MIN.) - SEE SECTIONS FOR DEPTH COMPOSITE METAL WALL PANEL FULLY ADHERED MEMBRANE ROOFING (MATCH EXISTING)

07 53 23-B MEMBRANE ROOFING - EXTEND OVER AND ATTACH TO FRONT FACE OF 2 LAYERS OF 2" POLYISO INSULATION BOARD (R-22.8) 07 53 23-J FLASHING POLYVINYL-CHLORIDE (PVC) MEMBRANE ROOFING SYSTEM

MEMBRANE ROOFING - EXTEND OVER AND ATTACH TO FRONT FACE OF 07 54 19-C 1/2" COVER BOARD

07 54 19-D TAPERED POLYISO INSULATION BOARD 07 54 19-E 2 LAYERS OF 2" POLYISO INSULATION BOARD (R-22.8) 07 54 19-F 2" POLYISO INSULATION BOARD (R-11.8) 07 62 00-A COPING - CUSTOM

ROOF EXPANSION JOINT METAL COVER MANUFACTURED GRAVEL STOP/DRIP EDGE MANUFACTURED FASCIA CLADDING MANUFACTURED COUNTERFLASHING SYSTEM ALUMINUM ROOF EXPANSION JOINT ASSEMBLY

SEALANT, TYPICAL SEALANT EACH SIDE, TYPICAL BACKER ROD AND SEALANT EACH SIDE, TYPICAL EXPANSION JOINT COVER - SEE SPECS. EXTERIOR WALL EXPANSION JOINT COVER HOLLOW METAL DOOR/BORROWED LIGHT FRAME

4 1/2" ALUMINUM-FRAMED STOREFRONT 6 1/2" ALUMINUM-FRAMED STOREFRONT WIDE STILE ALUMINUM ENTRANCE DOOR ALUMINUM BRAKE METAL FLASHING/TRIM TO MATCH STOREFRONT 7 1/2" DEEP ALUMINUM CURTAINWALL SYSTEM

ALUMINUM BRAKE METAL FLASHING/TRIM TO MATCH CURTAINWALL GLAZING - SEE SCHEDULE/ELEVATIONS FIXED LOUVER - MATCH EXISTING

1 1/2" FURRING CHANNEL 1 5/8" STEEL STUD 2 1/2" STEEL STUD 3 5/8" STEEL STUD 6" STEEL STUD

GLAZING STOP

5/8" GYPSUM WALL BOARD (SEE SPECS FOR TYPE) SOUND ATTENUATION INSULATION SUSPENDED GYPSUM BOARD CEILING ASSEMBLY

METAL J- MOULD ACOUSTICAL CEILING SUSPENSION ASSEMBLY RESILIENT BASE FINISH GRADE- SEE CIVIL SHEETS

DRAINING GRANULAR FILL

SIDEWALK- SEE CIVIL SHEETS


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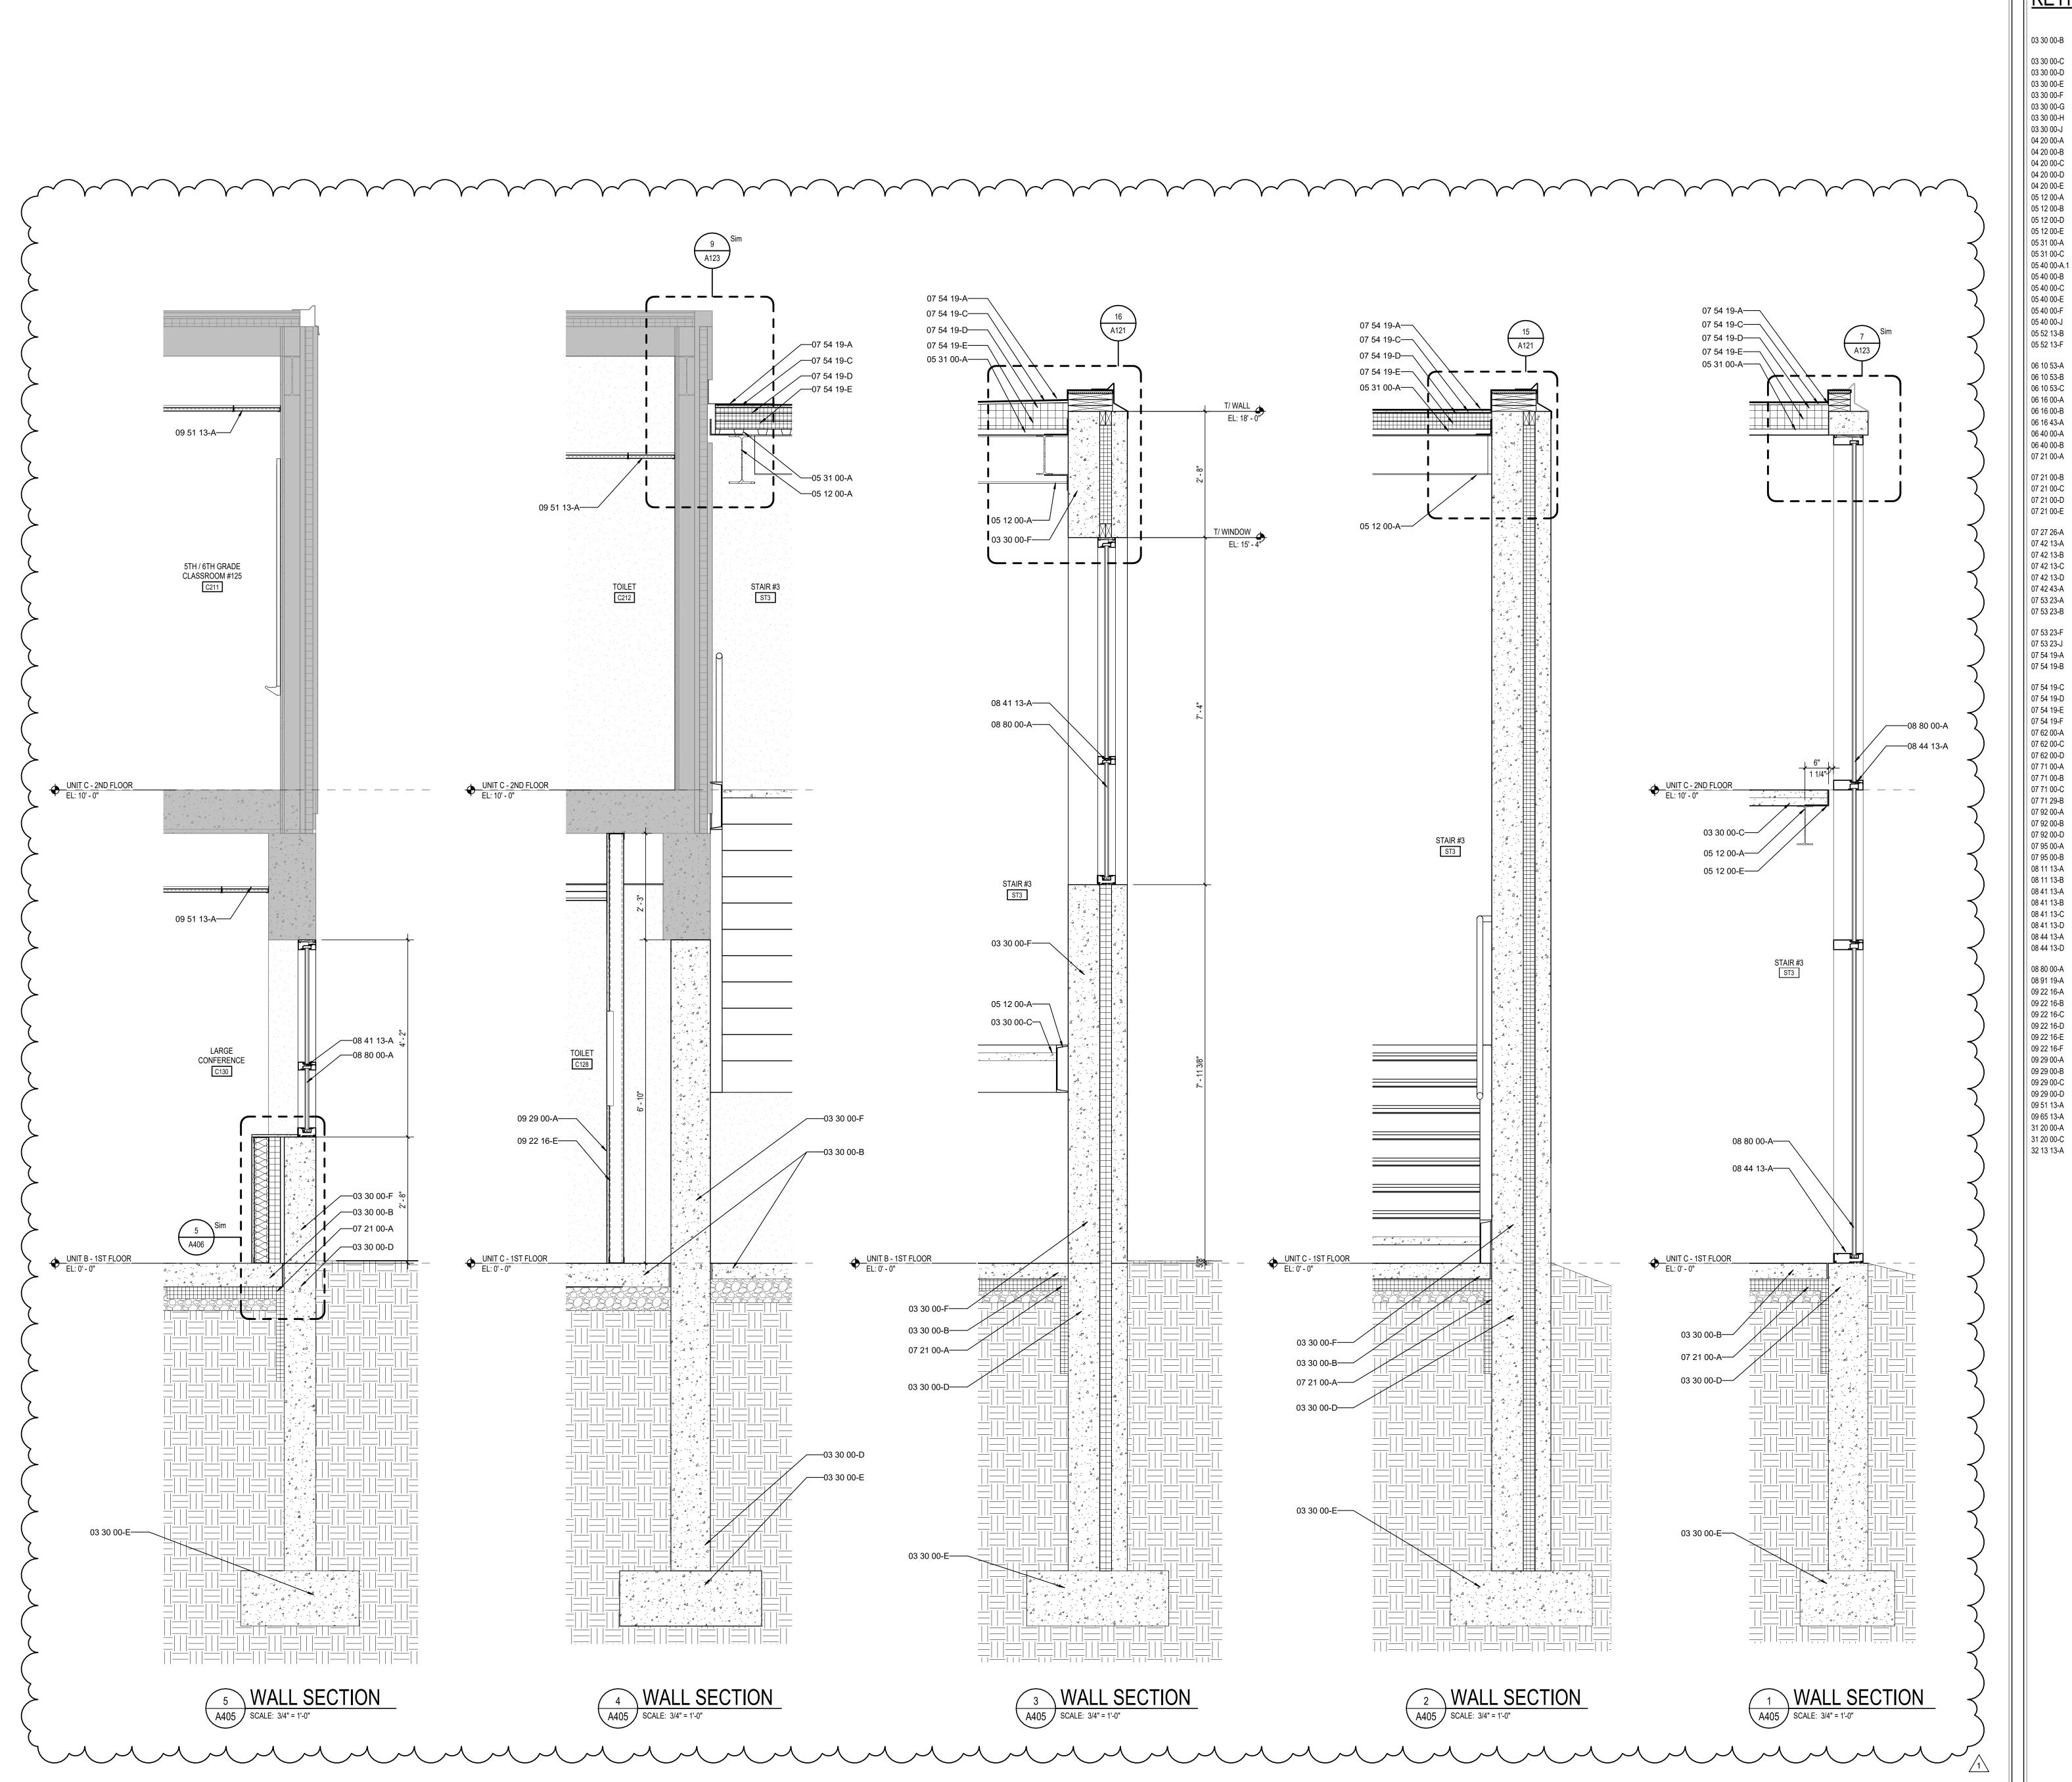
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DRAWING TITLE:



DRAWING NUMBER A404



KEYNOTE LEGEND

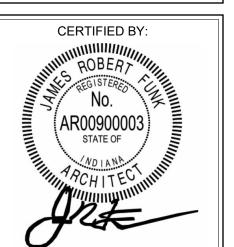B CONCRETE SLAB OVER VAPOR BARRIER ON DRAINAGE FILL. SEE STRUCTURAL
C CONCRETE SLAB ON METAL DECK- SEE STRUCTURAL
CONCRETE FOUNDATION- SEE STRUCTURAL
CONCRETE FOOTING- SEE STRUCTURAL

03 30 00-D CONCRETE FOUNDATION- SEE STRUCTURAL
03 30 00-F CAST-IN-PLACE CONCRETE WALL
03 30 00-G 1/2" EXPANSION MATERIAL
03 30 00-H CONCRETE RAMP

03 30 00-H CONCRETE RAMP
03 30 00-J CONCRETE STAIR - SEE STRUCTURAL
04 20 00-A THROUGH WALL FLASHING W/ STAINLESS STEEL DRIP EDGE
04 20 00-B CONCRETE MASONRY UNIT

04 20 00-B CONCRETE MASONRY UNIT
04 20 00-C BULLNOSE UNIT
04 20 00-D PRE-CAST CONCRETE MASONRY LINTEL
04 20 00-E BOND BEAM MASONRY UNIT

0-A STRUCTURAL STEEL FRAMING MEMBER- SEE STRUCTURAL
0-B STEEL ANGLE- SEE STRUCTURAL
0-D STEEL PLATE- SEE STRUCTURAL
0-E STEEL BENT PLATE- SEE STRUCTURAL

05 12 00-E STEEL BENT PLATE- SEE STRUCTURAL
05 31 00-A METAL ROOF DECKING- SEE STRUCTURAL
05 31 00-C 3" CELLULAR METAL ROOF DECK - SEE STRUCTURAL
05 40 00-A.1 2 1/2" STEEL STUD (20 GA. MIN.)
05 40 00-B 3 5/8" STEEL STUD (16 GA. MIN.)
05 40 00-C 6" STEEL STUD (16 GA. MIN.)

05 40 00-E 7/8" FURRING (HAT) CHANNEL (16 GA. MIN.)
05 40 00-F 1 1/2" FURRING (HAT) CHANNEL (16 GA. MIN.)
05 40 00-J CLIP ANGLE
05 52 13-B 1-1/4" I.D. CLEAR ANODIZED ALUMINUM HANDRAIL

05 52 13-B
1-1/4" I.D. CLEAR ANODIZED ALUMINUM HANDRAIL
05 52 13-F
CORE DRILL AND SET RAILING POST W/NON-SHRINK, NON-METALLIC
GROUT
06 10 53-A
SHIM AS REQUIRED
1X WOOD BLOCKING

06 40 00-B 1/2" MEDIUM DENSITY FIBERBOARD
07 21 00-A SLAB PERIMETER RIGID INSULATION (R-15 FOR 24" HORIZONTAL R-10 TO TOP OF FOOTING OR 48" MAX VERTICAL)
07 21 00-B PACK FULL WITH GLASS FIBER BATT INSULATION
07 21 00-C 3" CAVITY WALL EXTRUDED POLYSTYRENE INSULATION (R-16.8)
07 21 00-D MINERAL WOOL BATT INSULATION

07 21 00-D MINERAL WOOL BATT INSULATION
07 21 00-E THERMALLY BROKEN COMPOSITE Z-GIRT @ 16" O.C. COORDINATE DIRECTION WITH METAL PANEL MANUFACTURER
07 27 26-A FLUID APPLIED MEMBRANE AIR BARRIER
07 42 13-A PRE-FINISHED METAL WALL PANEL
07 42 13-B PRE-FINISHED METAL SOFFIT PANEL

07 42 13-D

07 42 13-C

BRAKE METAL FLASHING/TRIM

07 42 13-D

METAL HAT CHANNEL (16 GA. MIN.) - SEE SECTIONS FOR DEPTH

07 42 43-A

COMPOSITE METAL WALL PANEL

07 53 23-A

FULLY ADHERED MEMBRANE ROOFING (MATCH EXISTING)

MEMBRANE ROOFING - EXTEND OVER AND ATTACH TO FRONT FACE (19)

07 53 23-B

MEMBRANE ROOFING - EXTEND OVER AND ATTACH TO FRONT FACE OF PARAPET

07 53 23-F

2 LAYERS OF 2" POLYISO INSULATION BOARD (R-22.8)

07 53 23-J

FLASHING

07 54 19-A

POLYVINYL-CHLORIDE (PVC) MEMBRANE ROOFING SYSTEM

07 54 19-B MEMBRANE ROOFING - EXTEND OVER AND ATTACH TO FRONT FACE OF PARAPET

07 54 19-C 1/2" COVER BOARD

07 54 19-D TAPERED POLYISO INSULATION BOARD

07 54 19-E 2 LAYERS OF 2" POLYISO INSULATION BOARD (R-22.8)
07 54 19-F 2" POLYISO INSULATION BOARD (R-11.8)
07 62 00-A COPING - CUSTOM
07 62 00-C TERMINATION BAR
07 62 00-D POOF EXPANSION JOINT METAL COVER

07 62 00-D ROOF EXPANSION JOINT METAL COVER
07 71 00-A MANUFACTURED GRAVEL STOP/DRIP EDGE
07 71 00-B MANUFACTURED FASCIA CLADDING
07 71 00-C MANUFACTURED COUNTERFLASHING SYSTEM
07 71 29-B ALUMINUM ROOF EXPANSION JOINT ASSEMBLY
07 92 00-A SEALANT, TYPICAL

07 92 00-B SEALANT EACH SIDE, TYPICAL
07 92 00-D BACKER ROD AND SEALANT EACH SIDE, TYPICAL
07 95 00-A EXPANSION JOINT COVER - SEE SPECS.
07 95 00-B EXTERIOR WALL EXPANSION JOINT COVER
08 11 13-A HOLLOW METAL DOOR/BORROWED LIGHT FRAME
08 11 13-B GLAZING STOP

4 1/2" ALUMINUM-FRAMED STOREFRONT

08 41 13-B 6 1/2" ALUMINUM-FRAMED STOREFRONT
08 41 13-C WIDE STILE ALUMINUM ENTRANCE DOOR
08 41 13-D ALUMINUM BRAKE METAL FLASHING/TRIM TO MATCH STOREFRONT
08 44 13-A 7 1/2" DEEP ALUMINUM CURTAINWALL SYSTEM
08 44 13-D ALUMINUM BRAKE METAL FLASHING/TRIM TO MATCH CURTAINWALL

FRAME

08 80 00-A

08 91 19-A

FIXED LOUVER - MATCH EXISTING

09 22 16-A

7/8" FURRING CHANNEL

09 22 16-B

1 1/2" FURRING CHANNEL

09 22 16-C

1 5/8" STEEL STUD

09 22 16-C 1 5/8" STEEL STUD
09 22 16-D 2 1/2" STEEL STUD
09 22 16-E 3 5/8" STEEL STUD
09 22 16-F 6" STEEL STUD
09 29 00-A 5/8" GYPSUM WALL BOARD (SEE SPECS FOR TYPE)

09 29 00-B SOUND ATTENUATION INSULATION
09 29 00-C SUSPENDED GYPSUM BOARD CEILING ASSEMBLY
09 29 00-D METAL J- MOULD
09 51 13-A ACOUSTICAL CEILING SUSPENSION ASSEMBLY

09 51 13-A ACOUSTICAL CEILING SUSPENSION ASSEMBLY
09 65 13-A RESILIENT BASE
31 20 00-A FINISH GRADE- SEE CIVIL SHEETS
31 20 00-C DRAINING GRANULAR FILL

SIDEWALK- SEE CIVIL SHEETS

WBCSC TOGETHER WE LEARN

Keystone Crossing, Indianapolis, IN 46240

SCHOOL CORPORATION
ENOVATIONS AND ADDITIONS TO
RANCES SMITH ELEMENTARY
05 WAYCROSS DRIVE, COLUMBUS, IN 47201

SCOPE DRAWINGS:


e drawings indicate the general scope of the project of architectural design concept, the dimensions of ing, the major architectural elements and the type iral, mechanical and electrical systems. drawings do not necessarily indicate or describe all uired for full performance and completion of the ents of the Contract.

le basis of the general scope indicated or described contractors shall furnish all items required for the secution and completion of the work.


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A405



GLASS SCHEDULE

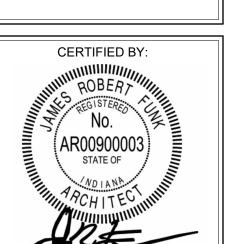- G1 1" THICK TEMPERED, LOW E, INSULATING GLAZING WITH 2 PANES 1/4" GLASS
- AND 1/2" AIRSPACE.
- G2 1/4" CLEAR TEMPERED GLASS. G3 - 1/4" LAMINATED CLEAR GLASS.
- G4 INSULATING LAMINATED SECURITY GLAZING. G5 - 1" THICK LAMINATED SPANDREL GLASS, LOW E, INSULATING GLAZING (1/4"
- GLASS 1/2" AIRSPACE 1/4" SPANDREL GLASS G6 - 3/8" THICK LAMINATED SECURITY GLAZING

ABBREVIATIONS LEGEND

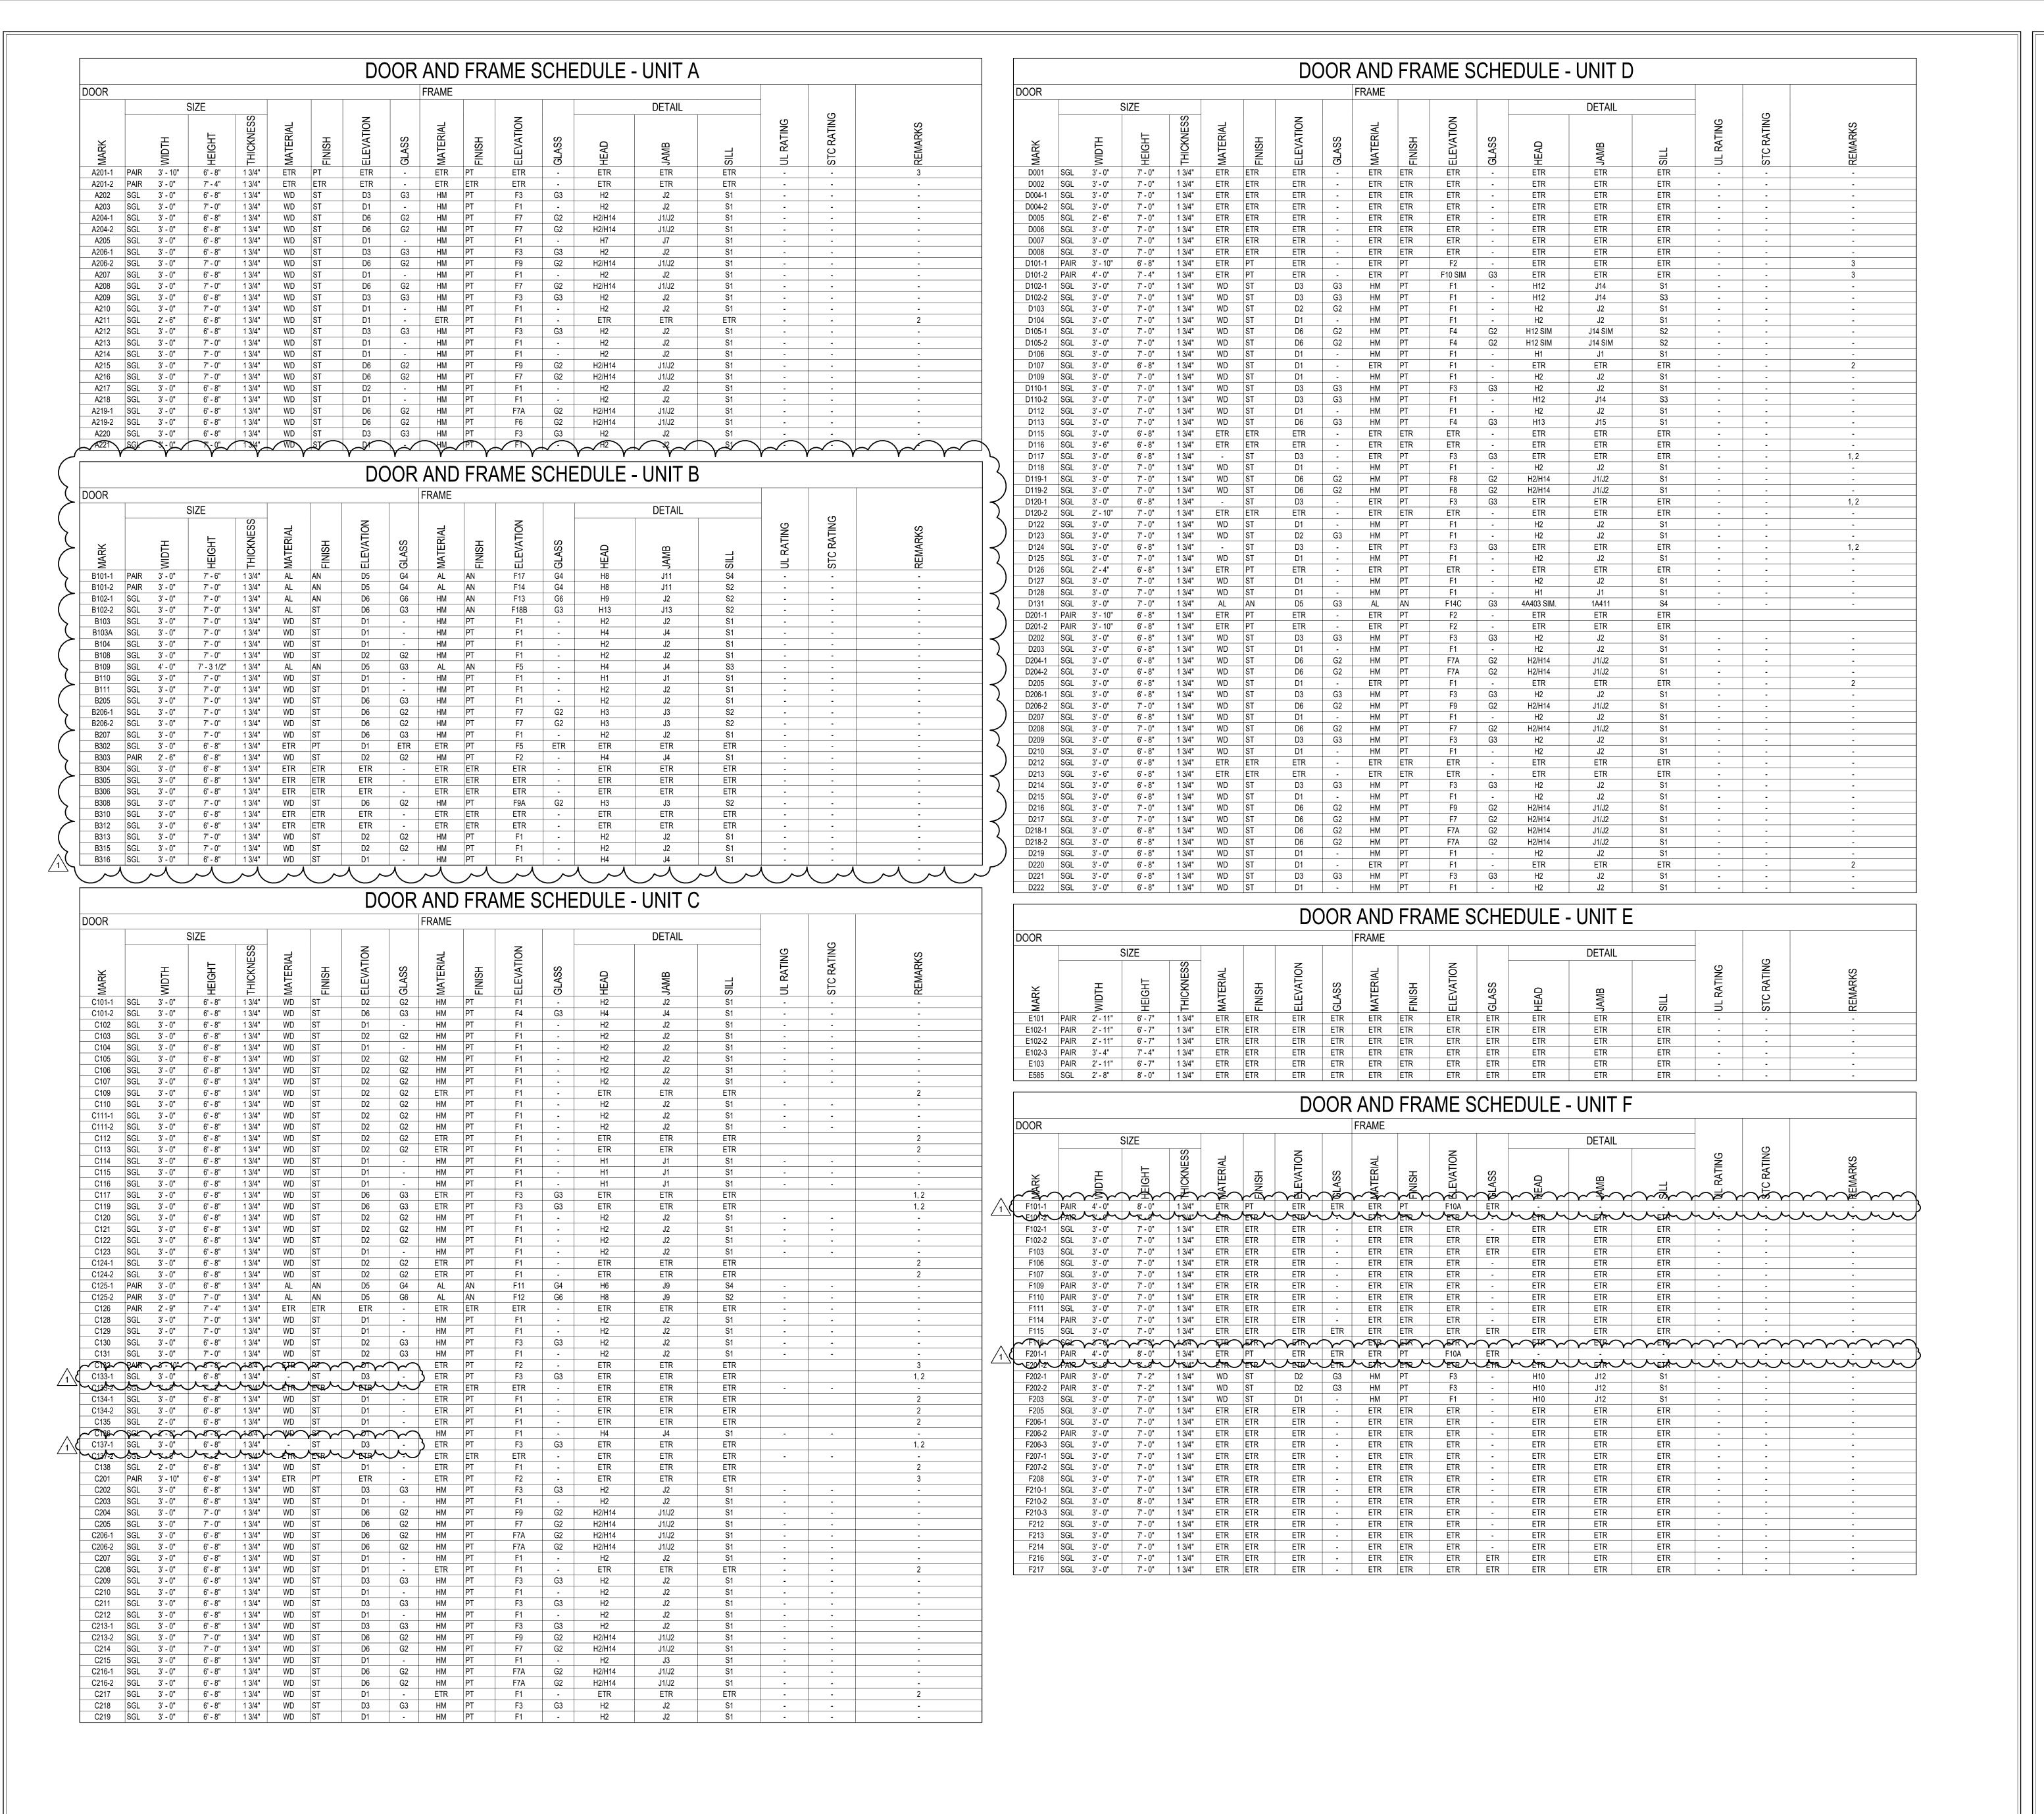- AL = ALUMINUM AN = ANODIZED
- BL = BORROWED LITE ETR = EXISTING TO REMAIN GHM = GALVANNEALED HOLLOW METAL
- GL = GLASS HM = HOLLOW METAL
- PT = PAINT ST = STAIN
- SS = STAINLESS STEEL STL = STEEL
- WD = WOOD90M = 90 MINUTE ASSEMBLY RATING * = SEE REMARKS COLUMN FOR NOTES

GENERAL DOOR NOTES

- A. THESE GENERAL NOTES APPLY TO THE DOOR SCHEDULE. B. DOOR AND FRAME NUMBERS CORRESPOND TO RESPECTIVE ROOM NUMBER. IN ROOMS WITH MULTIPLE OPENINGS, A NUMERICAL SUFFIX HAS BEEN ADDED TO DOOR NUMBERS. C. VERTICAL FRAMING MEMBERS AT ALL DOOR FRAMES SHALL EXTEND TO
- STRUCTURE ABOVE. D. UNDERCUT ALL DOORS AS REQUIRED BY FINAL FINISH.
- E. PROVIDE CONTINUOUS SEALANT BETWEEN HOLLOW METAL FRAME PERIMETERS AND SURROUNDING WALL CONSTRUCTION.
- F. PROVIDE CONTINUOUS SEALANT BETWEEN INTERIOR AND EXTERIOR WINDOW, CURTAINWALL AND STOREFRONT FRAME PERIMETERS AND SURROUNDING CONSTRUCTION UNLESS NOTED OTHERWISE.

G. GROUT FULL HOLLOW METAL FRAMES IN MASONRY CONSTRUCTION.

- H. SPOT GROUT HOLLOW METAL FRAMES IN GYPSUM WALLS. WHERE A FIRE RATING IS INDICATED ON THE DOOR SCHEDULE, HARDWARE
- AND DOOR ASSEMBLY COMPONENTS SHALL MEET THE REQUIREMENTS OF
- J. WHERE AN STC RATING IS INDICATED ON THE DOOR SCHEDULE, HARDWARE AND DOOR ASSEMBLY COMPONENTS SHALL MEET THE REQUIREMENTS OF THAT LABEL.
- K. INSTALL DOOR GLASS USING WET GLAZING METHOD. L. ALL LINTELS ABOVE EXTERIOR OPENINGS SHALL BE GALVANIZED AND
- PAINTED TYPICAL . M. REFER TO A500 SERIES SHEETS FOR DOOR, FRAME AND BORROWED LITE ELEVATIONS AND DETAILS.
- N. COORDINATE THROAT OPENINGS WITH WALL WIDTH FOR ALL WRAP AROUND FRAMES. O. SCHEDULED HARDWARE FOR ALUMINUM DOORS SHALL BE PROVIDED BY
- HARDWARE SUPPLIER AND INSTALLED BY ALUMINUM SUPPLIER. ALUMINUM DOORS TO BE PREPARED BY ALUMINUM DOOR SUPPLIER IN ACCORDANCE WITH THE SCHEDULED HARDWARE.
- P. ALL NEW HOLLOW METAL DOORS. FRAMES AND BORROWED LITE FRAMES TO BE PAINTED AS INDICATED ON THE A800 SERIES FINISH PLANS. SEE FINISH PLANS FOR WOOD DOOR FINISHES.
- Q. PROVIDE SILENCERS ON ALL DOOR FRAMES. R. SEE STRUCTURAL DRAWINGS FOR REQUIREMENTS FOR MASONRY AND STEEL LINTELS. PROVIDE STRUCTURAL STEEL LINTELS AT OPENINGS
- WHERE INDICATED ON THE STRUCTURAL STEEL DRAWINGS IN LIEU OF MASONRY LINTEL AS SHOWN IN THESE DETAILS. S. VERIFY ALL EXISTING CONDITIONS AND DIMENSIONS IN THE FIELD
- INCLUDING EXISTING AND NEW WALL THICKNESSES, ADJACENT FINAL CEILING HEIGHTS, ETC. PRIOR TO FABRICATION OF DOORS AND FRAMES. BRING DISCREPANCIES TO THE ATTENTION OF THE ARCHITEC
- WHERE NEW DOORS ARE SCHEDULED TO GO INTO EXISTING FRAMES, VERIFY ALL DIMENSIONS, HARDWARE CUTOUTS AND BLOCKING AND REVISE AS REQUIRED FOR NEW SCHEDULED HARDWARE. PATCH ANY PREVIOUS CUTOUTS TO RESTORE FRAME TO LIKE-NEW CONDITION.

DOOR REMARKS

- . NEW SIDELITE GLAZING IN EXISTING FRAME PER SCHEDULE NEW DOOR IN EXISTING FRAME
- 3. EXISTING DOOR AND FRAME TO REMAIN. DOOR AND FRAME TO RECEIVE






SCOPE DRAWINGS:

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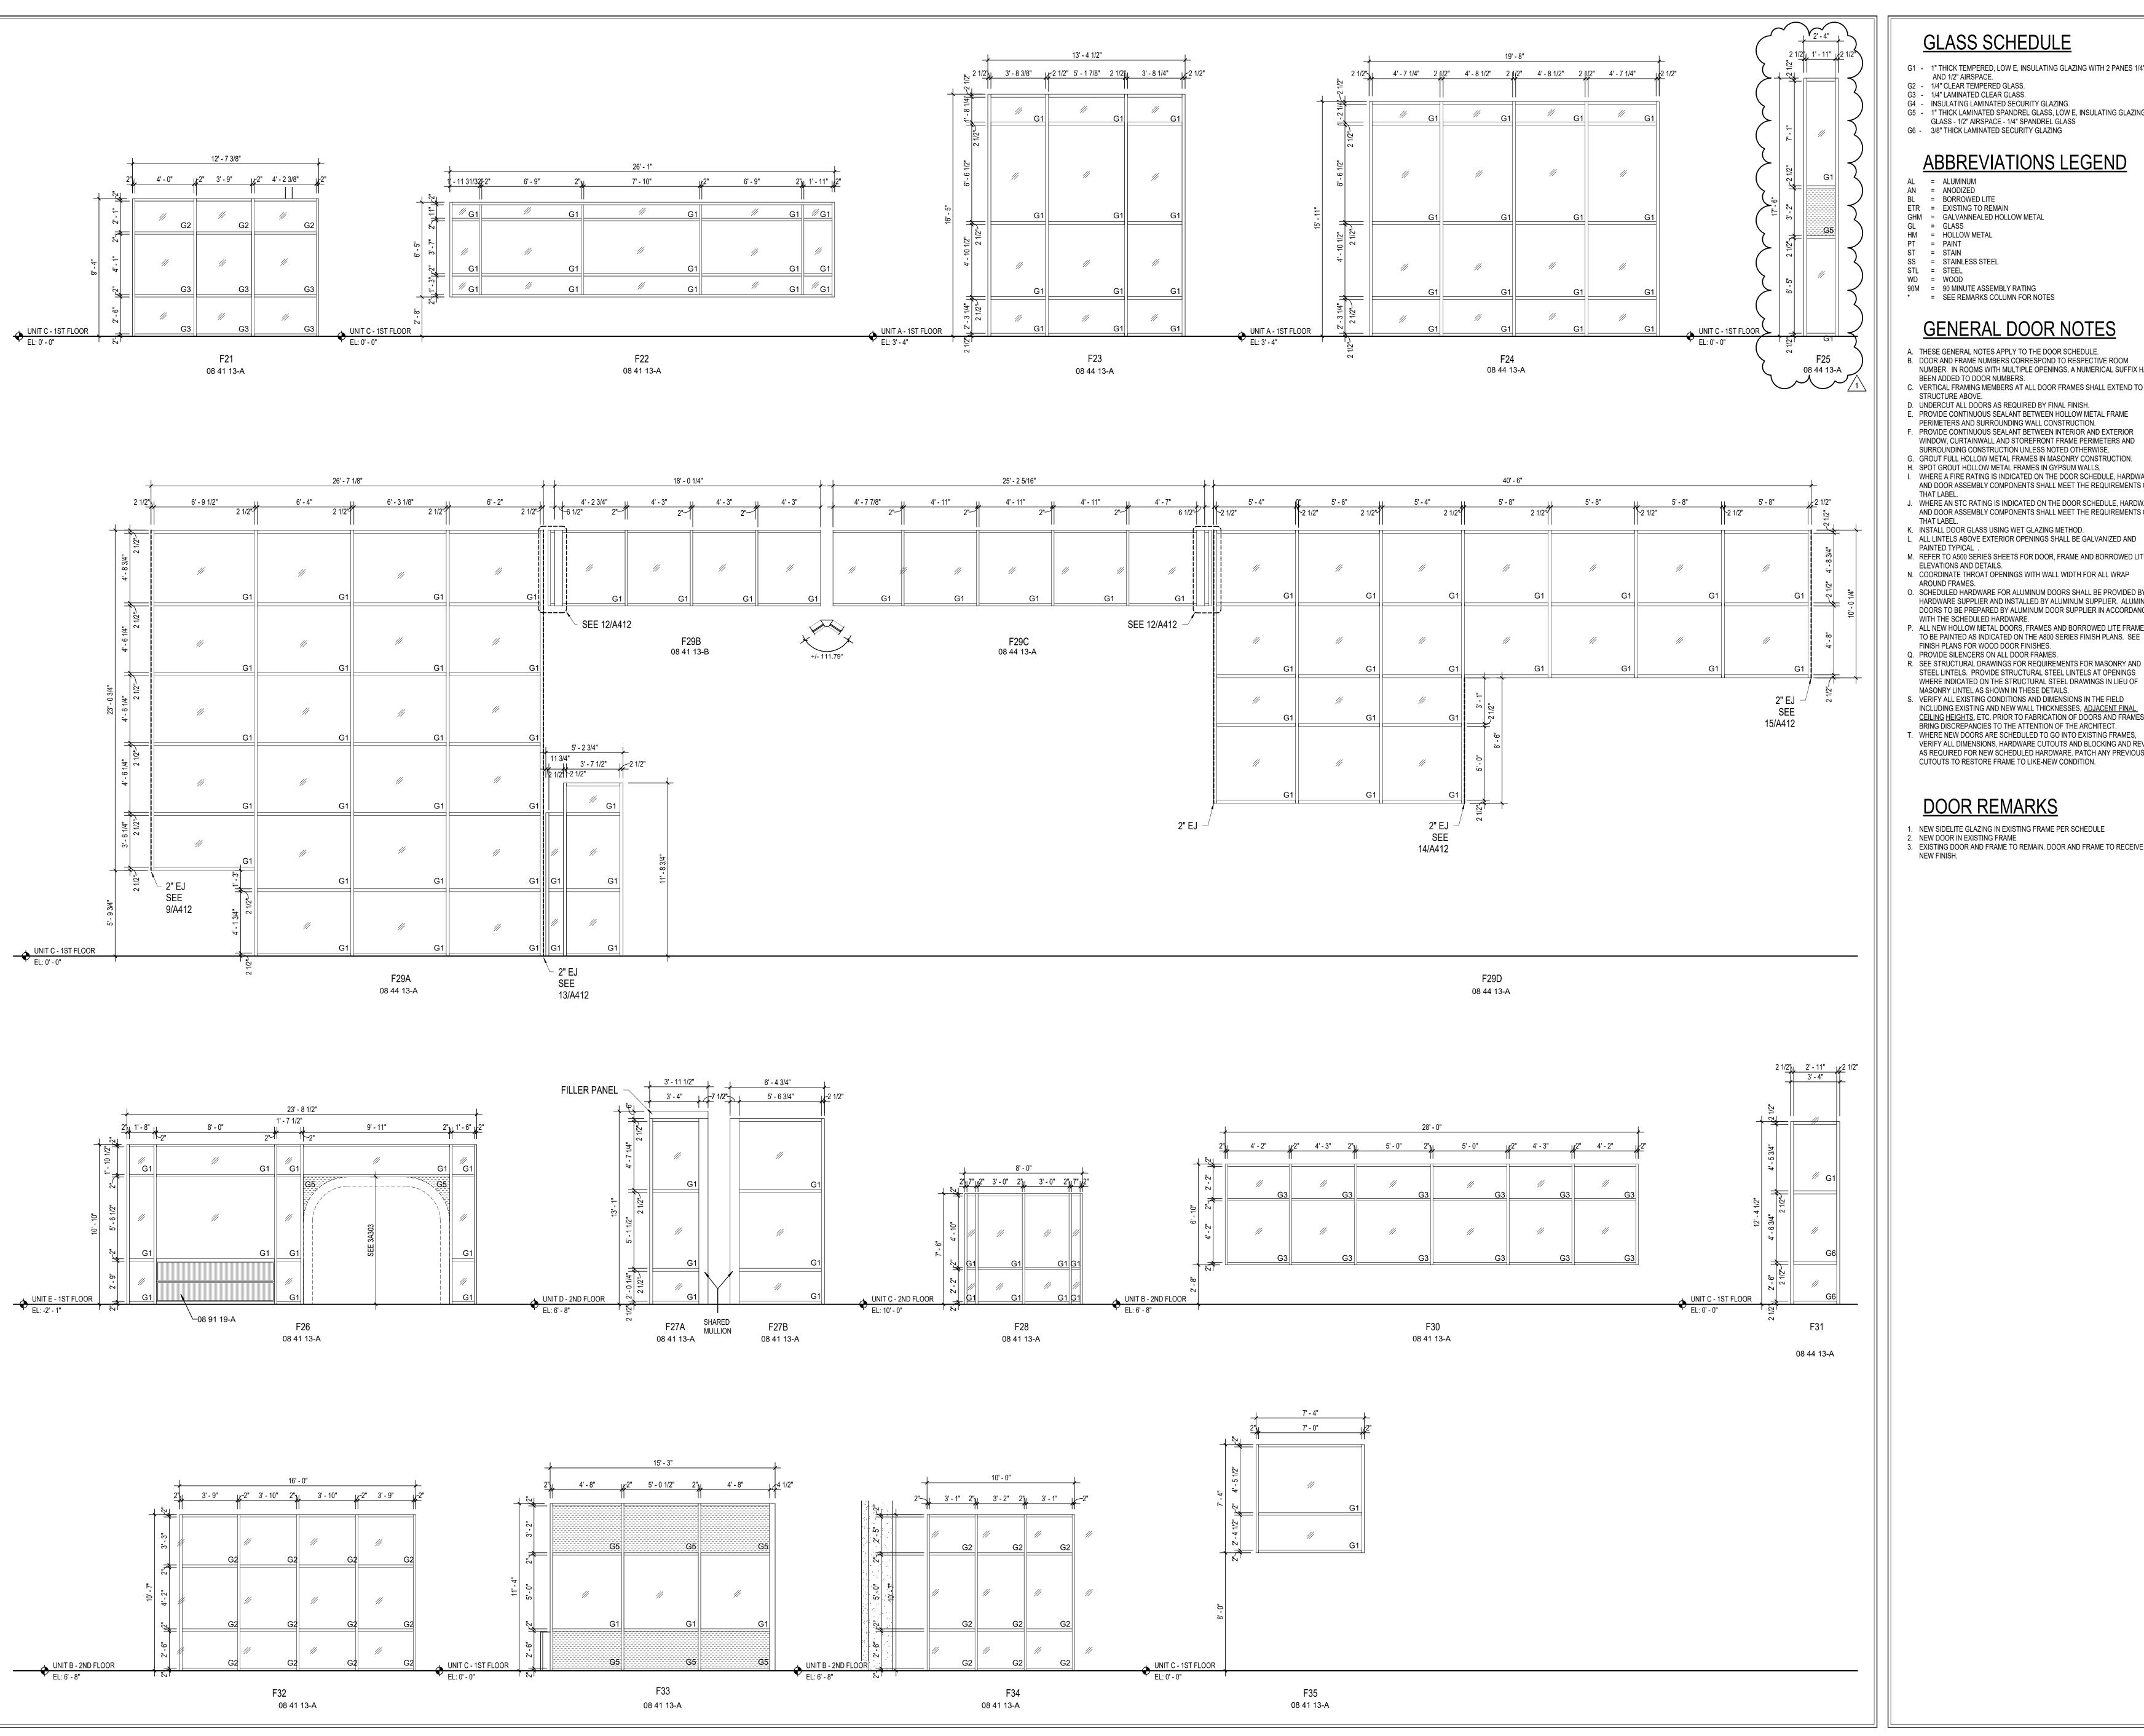
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DRAWING TITLE: DOOR AND FRAME SCHEDULE



DRAWING NUMBER A501

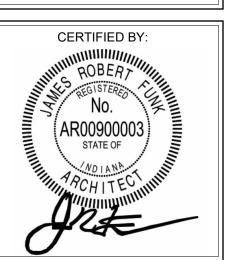

GLASS SCHEDULE

- G1 1" THICK TEMPERED, LOW E, INSULATING GLAZING WITH 2 PANES 1/4" GLASS
- AND 1/2" AIRSPACE. G2 - 1/4" CLEAR TEMPERED GLASS.
- G3 1/4" LAMINATED CLEAR GLASS.
- G4 INSULATING LAMINATED SECURITY GLAZING. G5 - 1" THICK LAMINATED SPANDREL GLASS, LOW E, INSULATING GLAZING (1/4"
- GLASS 1/2" AIRSPACE 1/4" SPANDREL GLASS G6 - 3/8" THICK LAMINATED SECURITY GLAZING

ABBREVIATIONS LEGEND

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- GHM = GALVANNEALED HOLLOW METAL
- PT = PAINT ST = STAIN
- SS = STAINLESS STEEL STL = STEEL
- 90M = 90 MINUTE ASSEMBLY RATING * = SEE REMARKS COLUMN FOR NOTES

GENERAL DOOR NOTES

- A. THESE GENERAL NOTES APPLY TO THE DOOR SCHEDULE. B. DOOR AND FRAME NUMBERS CORRESPOND TO RESPECTIVE ROOM NUMBER. IN ROOMS WITH MULTIPLE OPENINGS, A NUMERICAL SUFFIX HAS BEEN ADDED TO DOOR NUMBERS.
- STRUCTURE ABOVE. D. UNDERCUT ALL DOORS AS REQUIRED BY FINAL FINISH.
- E. PROVIDE CONTINUOUS SEALANT BETWEEN HOLLOW METAL FRAME PERIMETERS AND SURROUNDING WALL CONSTRUCTION. F. PROVIDE CONTINUOUS SEALANT BETWEEN INTERIOR AND EXTERIOR
- WINDOW, CURTAINWALL AND STOREFRONT FRAME PERIMETERS AND SURROUNDING CONSTRUCTION UNLESS NOTED OTHERWISE. G. GROUT FULL HOLLOW METAL FRAMES IN MASONRY CONSTRUCTION.
- H. SPOT GROUT HOLLOW METAL FRAMES IN GYPSUM WALLS. I. WHERE A FIRE RATING IS INDICATED ON THE DOOR SCHEDULE, HARDWARE AND DOOR ASSEMBLY COMPONENTS SHALL MEET THE REQUIREMENTS OF
- J. WHERE AN STC RATING IS INDICATED ON THE DOOR SCHEDULE, HARDWARE AND DOOR ASSEMBLY COMPONENTS SHALL MEET THE REQUIREMENTS OF
- K. INSTALL DOOR GLASS USING WET GLAZING METHOD. . ALL LINTELS ABOVE EXTERIOR OPENINGS SHALL BE GALVANIZED AND
- PAINTED TYPICAL . M. REFER TO A500 SERIES SHEETS FOR DOOR, FRAME AND BORROWED LITE
- ELEVATIONS AND DETAILS. N. COORDINATE THROAT OPENINGS WITH WALL WIDTH FOR ALL WRAP AROUND FRAMES.
- O. SCHEDULED HARDWARE FOR ALUMINUM DOORS SHALL BE PROVIDED BY HARDWARE SUPPLIER AND INSTALLED BY ALUMINUM SUPPLIER. ALUMINUM DOORS TO BE PREPARED BY ALUMINUM DOOR SUPPLIER IN ACCORDANCE WITH THE SCHEDULED HARDWARE.
- P. ALL NEW HOLLOW METAL DOORS, FRAMES AND BORROWED LITE FRAMES TO BE PAINTED AS INDICATED ON THE A800 SERIES FINISH PLANS. SEE FINISH PLANS FOR WOOD DOOR FINISHES.
- Q. PROVIDE SILENCERS ON ALL DOOR FRAMES. R. SEE STRUCTURAL DRAWINGS FOR REQUIREMENTS FOR MASONRY AND STEEL LINTELS. PROVIDE STRUCTURAL STEEL LINTELS AT OPENINGS
- WHERE INDICATED ON THE STRUCTURAL STEEL DRAWINGS IN LIEU OF MASONRY LINTEL AS SHOWN IN THESE DETAILS. S. VERIFY ALL EXISTING CONDITIONS AND DIMENSIONS IN THE FIELD
- INCLUDING EXISTING AND NEW WALL THICKNESSES, ADJACENT FINAL CEILING HEIGHTS, ETC. PRIOR TO FABRICATION OF DOORS AND FRAMES. BRING DISCREPANCIES TO THE ATTENTION OF THE ARCHITECT.
- WHERE NEW DOORS ARE SCHEDULED TO GO INTO EXISTING FRAMES, VERIFY ALL DIMENSIONS, HARDWARE CUTOUTS AND BLOCKING AND REVISE AS REQUIRED FOR NEW SCHEDULED HARDWARE. PATCH ANY PREVIOUS CUTOUTS TO RESTORE FRAME TO LIKE-NEW CONDITION.

- . NEW SIDELITE GLAZING IN EXISTING FRAME PER SCHEDULE
- NEW DOOR IN EXISTING FRAME
 EXISTING DOOR AND FRAME TO REMAIN. DOOR AND FRAME TO RECEIVE NEW FINISH.






SCOPE DRAWINGS: These drawings indicate the general scope of the projec in terms of architectural design concept, the dimensions of the building, the major architectural elements and the type of structural, mechanical and electrical systems.

The drawings do not necessarily indicate or describe all work required for full performance and completion of the


> **REVISIONS:** ADDENDUM #1 01/29/2025

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> DRAWING TITLE: **ELEVATIONS**

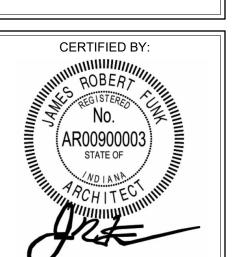

DRAWING NUMBER A503



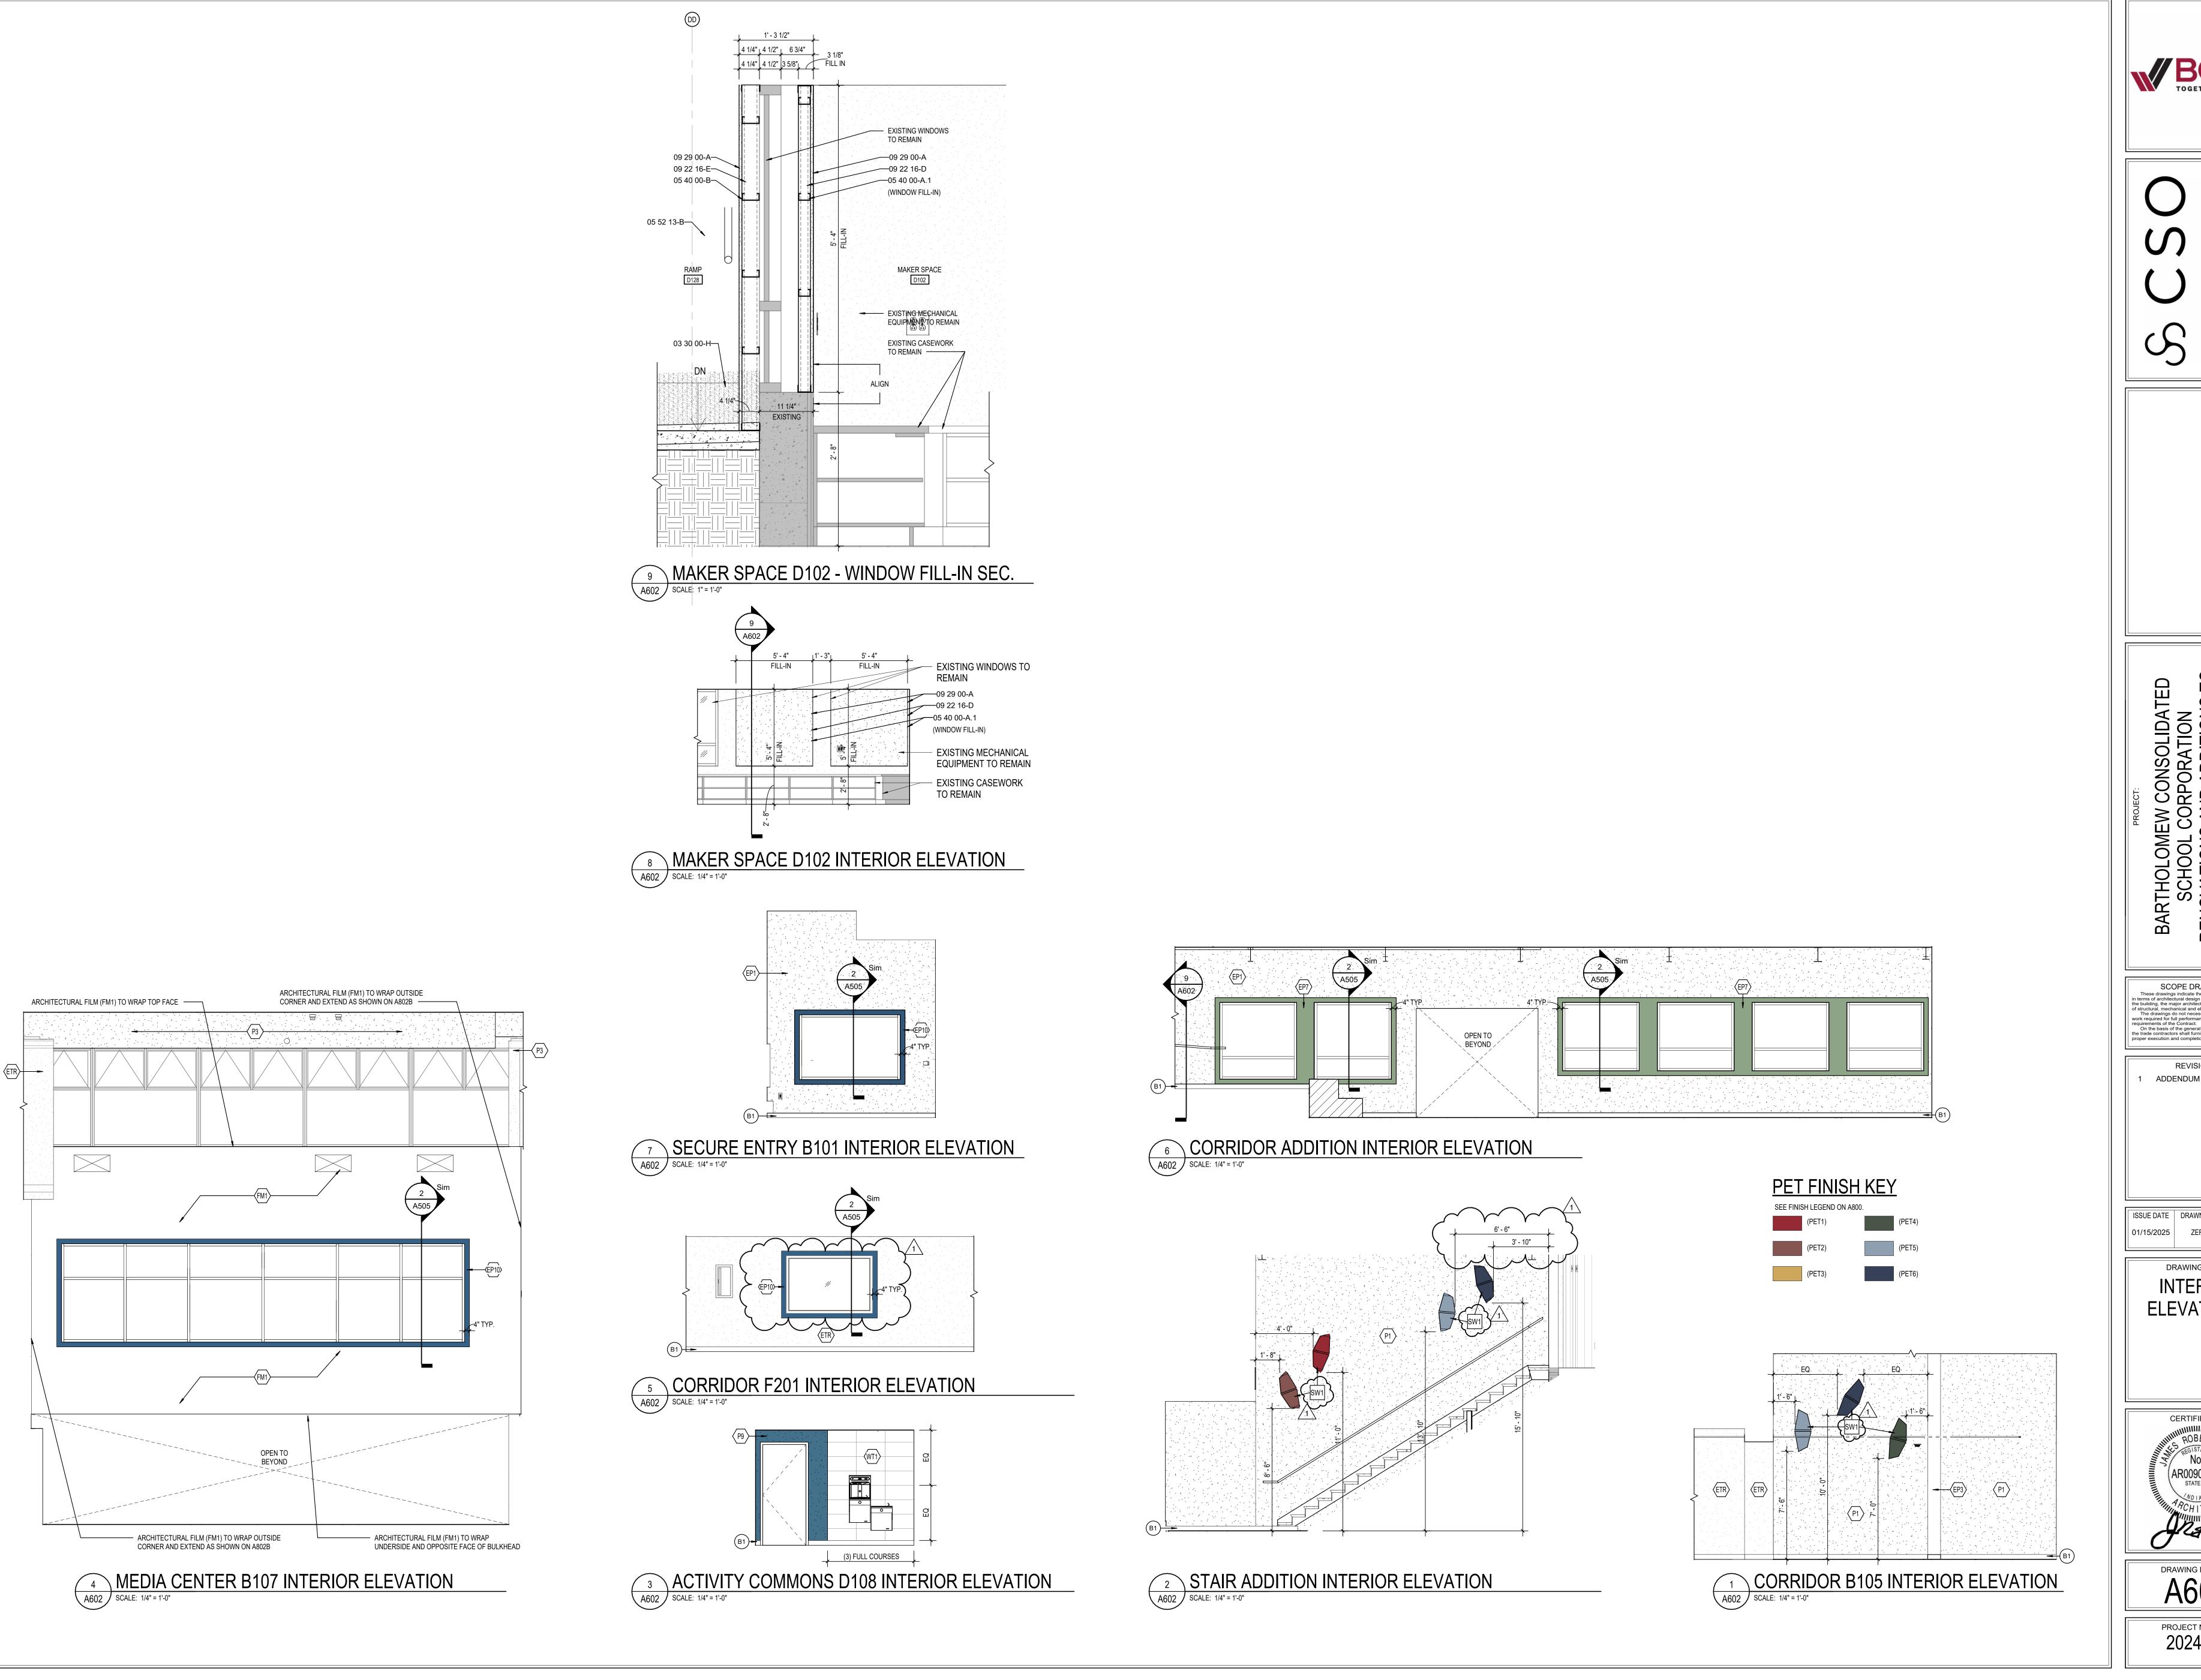

SCOPE DRAWINGS:

These drawings indicate the general scope of the project in terms of architectural design concept, the dimensions of the building, the major architectural elements and the type of structural, mechanical and electrical systems.


The drawings do not necessarily indicate or describe all work required for full performance and completion of the requirements of the Contract.

On the basis of the general scope indicated or described the trade contractors shall furnish all items required for the proper execution and completion of the work.


REVISIONS: ADDENDUM #1 01/29/2025

ISSUE DATE | DRAWN BY | CHECKED BY 01/15/2025 ZER ECN

DRAWING TITLE: **INTERIOR ELEVATIONS**

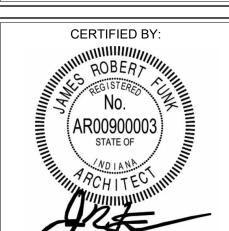


DRAWING NUMBER A602

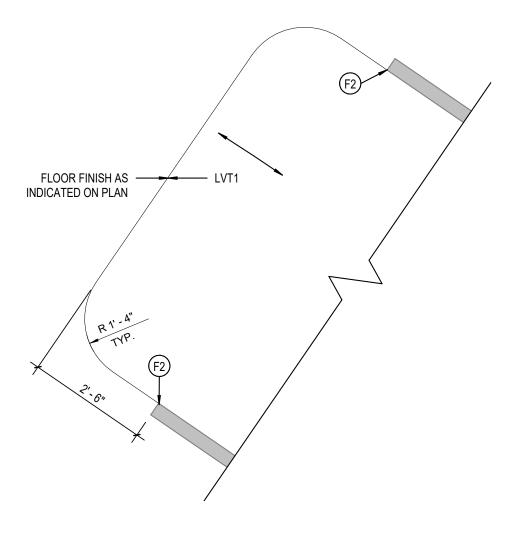

TYP. RAMP FLOOR GRAPHIC DETAIL

SCALE: 1/2" = 1'-0"

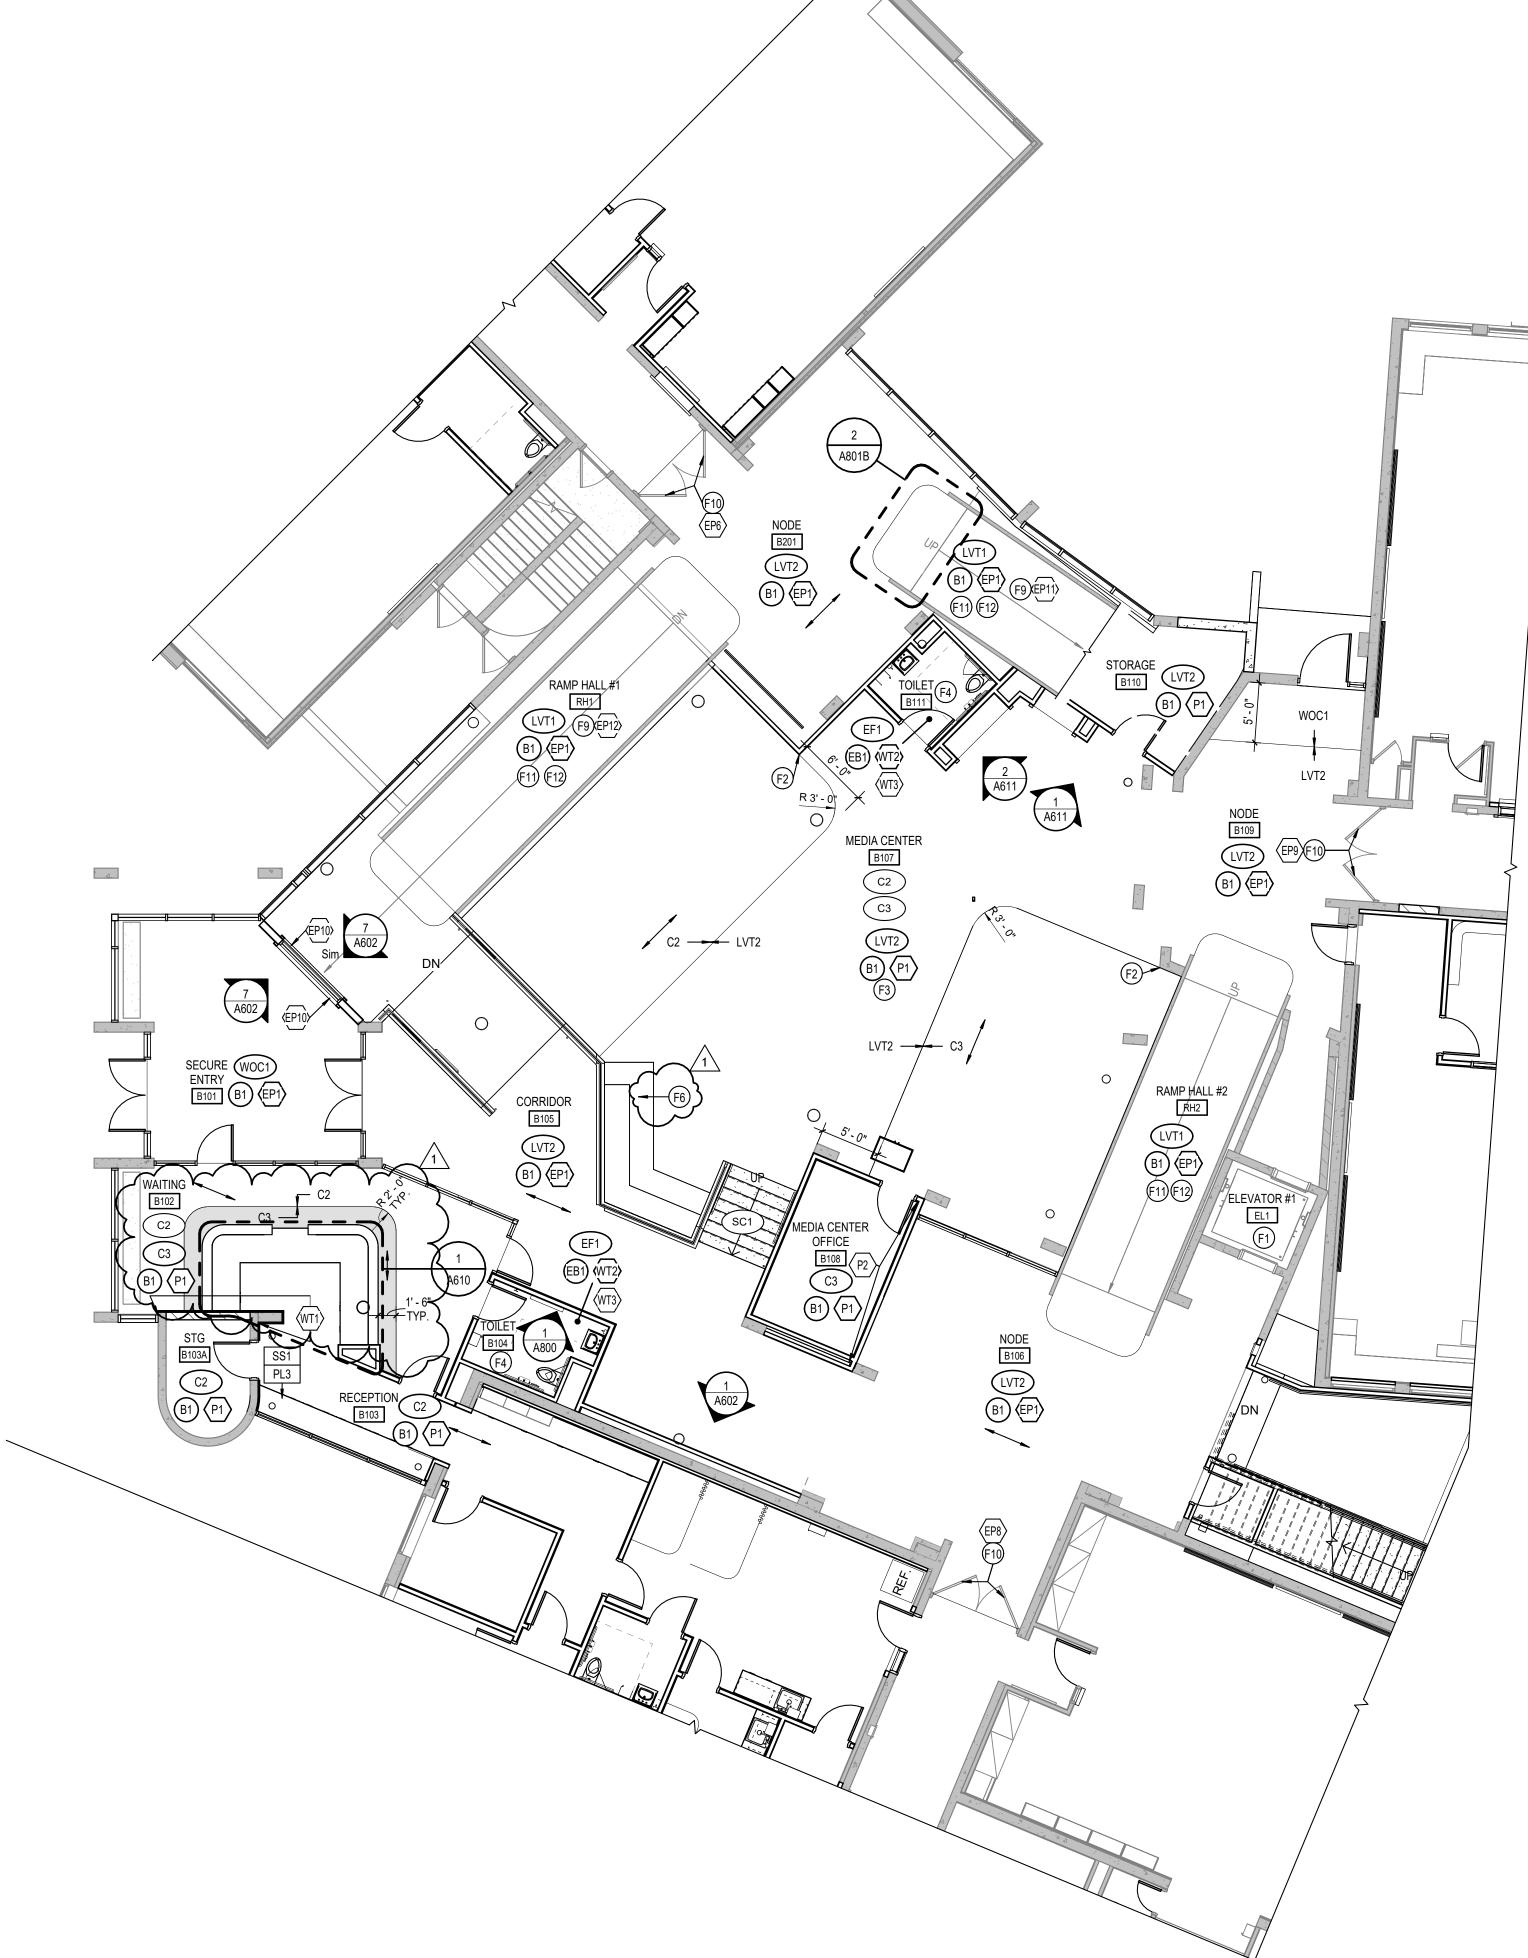

1 GROUND LEVEL FINISH PLAN - UNIT B

SCALE: 1/8" = 1'-0"

GENERAL FINISH NOTES

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- WILL GOVERN OVER PREVIOUS SUPPLEMENTAL DRAWINGS.

 2. THE SCHEDULED MATERIALS SHALL NOT BE INSTALLED BEFORE THE CONTRACTOR'S PHYSICAL COLOR SAMPLE SUBMITTALS HAVE BEEN APPROVED, AS REQUIRED IN THE SPECIFICATIONS. IF ANY MATERIAL IS INSTALLED BEFORE
- APPROVAL, THE CONTRACTOR WILL BE RESPONSIBLE FOR THE REMOVAL, REPLACEMENT PURCHASE, AND INSTALLATION OF ALL ERRONEOUS PRODUCT.

 3. ALL SURFACES RECEIVING FINISHES SHALL BE PROPERLY PREPARED PER MANUFACTURERS' SPECIFICATIONS PRIOR TO INSTALLATION. CONTRACTOR
- SHALL BE RESPONSIBLE FOR FIELD VERIFYING CONDITIONS.

 4. CONTRACTOR RESPONSIBLE FOR PROTECTING INSTALLED FINISHES AND FINISHES EXISTING TO REMAIN DURING CONSTRUCTION PROCESS. ALL EXISTING
- TO REMAIN SURFACES SHALL BE PROPERLY CLEANED.

 5. WHERE DEMOLITION OCCURS, SURFACE TO BE PROPERLY PATCHED AND REPAIRED TO MATCH SURROUNDING SURFACES BEFORE FINISH IS APPLIED.

 6. FOR CHANGE IN FLOOR FINISH MATERIALS OF DIFFERENT HEIGHTS, PROVIDE
- TRANSITION STRIP TO MEET CODE/ADA REQUIREMENTS. IF TRANSITIONING AT DOOR OPENING, TRANSITION TO BE ON CENTER OF DOOR LEAF/PANEL, U.N.O. SEE TRANSITION DETAILS ON A800 FOR ADDITIONAL INFORMATION.

 7. WHERE CARPET AND LVT TRANSITIONS OCCUR, INSTALL FACTORY FINISHED
- EDGE OF CARPET TO FACTORY FINISHED EDGE OF LVT; DO NOT USE CUT EDGES AT ANY TRANSITIONS.
 SEE INTERIOR PAINT SPECIFICATIONS FOR SCHEDULE OF COATING TYPE PER SUBSTRATE AND SHEEN. CONTRACTOR TO PROVIDE CRISP, CLEAN LINES
- BETWEEN ALL PAINT TRANSITIONS.

 9. DO NOT PAINT INTERIOR BRICK, ROUGH FACE CMU, OR OTHER FACTORY FINISHED ITEMS, U.N.O.
- DO NOT PAINT INTERIOR CONCRETE IF EXISTING IS UNPAINTED. IF EXISTING CONCRETE IS PAINTED, PAINT TO MATCH ADJACENT WALL FINISH.
 DO NOT PAINT TUBE EXTERIOR OR TRIM, U.N.O.
- 11. DO NOT PAINT TUBE EXTERIOR OR TRIM, U.N.O.
 12. ALL EXPOSED STRUCTURAL ELEMENTS TO BE PAINTED (P3), U.N.O. SEE
- SPECIFICATIONS FOR ADDITIONAL INFORMATION.

 13. ALL METAL STAIR COMPONENTS, INCLUDING RAILINGS, STRINGERS, AND RISERS TO BE PAINTED (EP3), U.N.O. DO NOT PAINT ANODIZED ALUMINUM OR FACTORY FINISHED METALS. SEE SPECIFICATIONS FOR ADDITIONAL INFORMATION.

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 15. ALL GWB SOFFITS/BULKHEADS' VERTICAL FACES PAINTED TO MATCH ADJACENT WALLS AND UNDERSIDE TO BE PAINTED (P12), U.N.O. REFER TO REFLECTED CEILING PLANS AND SPECIFICATIONS FOR ALL CEILING MATERIALS, THEIR LOCATIONS, AND ADDITIONAL INFORMATION.
- 16. PAINT WALLS BEFORE INSTALLING MARKER BOARDS, TACKBOARDS, ETC.
 17. ALL HOLLOW METAL DOORS & FRAMES ARE TO BE PAINTED (EP3).
 18. WOOD DOORS ARE TO BE PLAIN SLICED WHITE MAPLE, STAINED TO MATCH PLASTIC LAMINATE (PL1). SEE SPECIFICATIONS FOR ADDITIONAL INFORMATION.
- FOR CORNER GUARDS, REFER TO SPECIFICATIONS AND A900 SERIES FOR INFORMATION AND LOCATIONS. COLORS TO BE SELECTED FROM MANUFACTURER'S FULL RANGE, U.N.O. IN FINISH LEGEND. CORNER GUARDS TO BE APPLIED TO GWB ONLY.
 ALL WINDOW STOOLS TO BE (SS3). REFER TO A400 SERIES FOR WINDOW SECTIONS AND DETAILS.
- 21. WHERE WALL TILE OCCURS, ALL OUTSIDE CORNERS AND EXPOSED TILE EDGES
 TO BE TRIMMED WITH SCHLUTER JOLLY IN BRUSHED STAINLESS STEEL FINISH.
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 23. RESTROOM SINKS TO BE SELECTED FROM MANUFACTURER'S FULL RANGE. SEE SPECIFICATIONS FOR ADDITIONAL INFORMATION.

24. ALL CUSTODIAL MOP SINK LOCATIONS TO RECEIVE FRP. LENGTH AS NECESSARY, MINIMUM OF 2'-0" ON EITHER SIDE OF SINK. FRP TO START AT TOP OF BASE AND

RUN FULL PANEL WIDTH (4'-0"). COLOR TO BE SELECTED FROM MANUFACTURER'S FULL RANGE.

25. WALL PADDING TO BE SELECTED FROM MANUFACTURER'S FULL RANGE. REFER TO 900 SERIES DRAWINGS AND SPECIFICATIONS FOR ADDITIONAL INFORMATION.

26. CUBICLE CURTAIN TO BE SELECTED FROM MANUFACTURER'S FULL RANGE.

FINISH TAG KEY

XXX FLOOR FINISH

BASE FINISH

WALL FINISH

777.22 7 1111011

XXX HORIZONTAL FINISH (COUNTERTOP)
XXX VERTICAL FINISH (CASEWORK)

COUNTERTOP, CASEWORK OR MISCELLANEOUS FINISH ONLY REFER TO FINISH LEGEND

ACCENT WALL FINISH

FLOORING INSTALL DIRECTION

FINISH PLAN NOTES

- F1 NO WORK IN THIS AREA, UNLESS NOTED OTHERWISE.
 F2 ALIGN FLOOR TRANSITION TO OUTSIDE CORNER OR AS INDICATED ON PLAN.
- F3 PATCH/REPAIR FLOOR, WALL, AND BASE AS REQUIRED BY DEMOLITION AND NEW CONSTRUCTION TO MATCH EXISTING.
- F4 REFER TO 1/A800 FOR RESTROOM WALL TILE INSTALL; TYP. ALL WALLS.
 F5 INSTALL PLASTIC LAMINATE (PL2) AS REQUIRED TO UNFINISHED EDGES/FACES OF EXISTING CASEWORK.
- F6 SEATING TO RECEIVE ARCHITECTURAL FILM (FM1) ON VERTICAL SURFACES AND SOLID SURFACE (SS3) ON HORIZONTAL SURFACES. SEE FLOOR AND WALL
- TRANSITION DETAILS ON A800.
 PAINT (P11) AND SHEET VINYL (SV2) TO ALIGN W/ EXTENTS OF CYCLORAMA BUILT-IN COVE BASE WALL SYSTEM; SEE A900 SERIES AND SPECS FOR MORE INFORMATION.
 F8 FULL HEIGHT WALL PADDING TO BE INSTALLED ON ALL WALLS. INSTALL TO BE A

TIGHT FIT BETWEEN WOOD BASE AND WOOD CEILING TRIM AND FROM CORNER TO

- CORNER OR CORNER TO DOOR FRAME. SEE SPECIFICATIONS FOR MORE INFORMATION.

 F9 TURE EXTERIOR TO RECEIVE PAINT (FP-) INDICATED ON PLAN
- F9 TUBE EXTERIOR TO RECEIVE PAINT (EP-) INDICATED ON PLAN.F10 DOORS AND FRAME TO RECEIVE PAINT (EP-) INDICATED ON PLAN.
- F11 SEE 2/A801B FOR RAMP FLOOR GRAPHIC DETAILS.
- F12 EXISTING RAMP HANDRAILS TO RECEIVE PAINT (EP3).
 F13 INSTALL WALL BASE (B1) ON EXISTING CASEWORK. ALL WALLS TO RECEIVE EPOXY
- BASE (EB1).
 F14 REFERENCE 1/A505 AND 2/A505 FOR ALL WINDOWS IN CORRIDOR.



g, Indianapolis, IN 46240

8831 Keystone Crossing, India 317.848.7800 | cso

BARTHOLOMEW CONSOLIDATED SCHOOL CORPORATION
RENOVATIONS AND ADDITIONS TO FRANCES SMITH ELEMENTAF 4505 WAYCROSS DRIVE, COLUMBUS, IN 4720

SCOPE DRAWINGS:
drawings indicate the general scope of the project architectural design concept, the dimensions of g, the major architectural elements and the type II, mechanical and electrical systems. awings do not necessarily indicate or describe all red for full performance and completion of the tots of the Contract. basis of the general scope indicated or described ontractors shall furnish all items required for the cution and completion of the work.

1 ADDENDUM #1 01/29/2025


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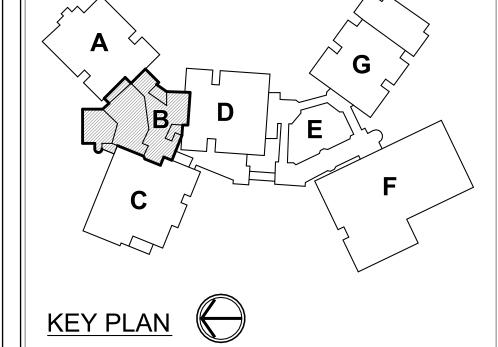
01/15/2025 ZER ECN

DRAWING TITLE:

GROUND LEVEL FINISH PLAN -UNIT B



A801B

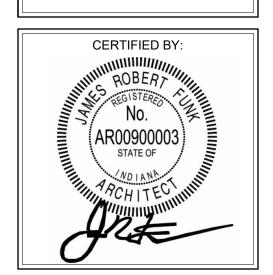



GROUND LEVEL FINISH PLAN - UNIT C

GENERAL FINISH NOTES

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- TRANSITION STRIP TO MEET CODE/ADA REQUIREMENTS. IF TRANSITIONING AT DOOR OPENING, TRANSITION TO BE ON CENTER OF DOOR LEAF/PANEL, U.N.O. SEE TRANSITION DETAILS ON A800 FOR ADDITIONAL INFORMATION. WHERE CARPET AND LVT TRANSITIONS OCCUR, INSTALL FACTORY FINISHED
- EDGE OF CARPET TO FACTORY FINISHED EDGE OF LVT; DO NOT USE CUT EDGES AT ANY TRANSITIONS. 8. SEE INTERIOR PAINT SPECIFICATIONS FOR SCHEDULE OF COATING TYPE PER SUBSTRATE AND SHEEN. CONTRACTOR TO PROVIDE CRISP, CLEAN LINES
- FINISHED ITEMS, U.N.O. 10. DO NOT PAINT INTERIOR CONCRETE IF EXISTING IS UNPAINTED. IF EXISTING

9. DO NOT PAINT INTERIOR BRICK, ROUGH FACE CMU, OR OTHER FACTORY

BETWEEN ALL PAINT TRANSITIONS.

- CONCRETE IS PAINTED, PAINT TO MATCH ADJACENT WALL FINISH. 11. DO NOT PAINT TUBE EXTERIOR OR TRIM, U.N.O.
- 12. ALL EXPOSED STRUCTURAL ELEMENTS TO BE PAINTED (P3), U.N.O. SEE SPECIFICATIONS FOR ADDITIONAL INFORMATION.
- 13. ALL METAL STAIR COMPONENTS, INCLUDING RAILINGS, STRINGERS, AND RISERS TO BE PAINTED (EP3), U.N.O. DO NOT PAINT ANODIZED ALUMINUM OR FACTORY FINISHED METALS. SEE SPECIFICATIONS FOR ADDITIONAL INFORMATION. 14. ALL WALL-MOUNTED GRILLES, METAL PANELS, MISC. METALS, ETC. ARE TO BE FACTORY FINISHED TO MATCH ADJACENT WALLS, U.N.O.
- 15. ALL GWB SOFFITS/BULKHEADS' VERTICAL FACES PAINTED TO MATCH ADJACENT WALLS AND UNDERSIDE TO BE PAINTED (P12), U.N.O. REFER TO REFLECTED CEILING PLANS AND SPECIFICATIONS FOR ALL CEILING MATERIALS, THEIR LOCATIONS, AND ADDITIONAL INFORMATION. 16. PAINT WALLS BEFORE INSTALLING MARKER BOARDS, TACKBOARDS, ETC.
- 17. ALL HOLLOW METAL DOORS & FRAMES ARE TO BE PAINTED (EP3). 18. WOOD DOORS ARE TO BE PLAIN SLICED WHITE MAPLE, STAINED TO MATCH PLASTIC LAMINATE (PL1). SEE SPECIFICATIONS FOR ADDITIONAL INFORMATION. 19. FOR CORNER GUARDS, REFER TO SPECIFICATIONS AND A900 SERIES FOR
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FINISH TAG KEY

FULL RANGE.

(XXX) FLOOR FINISH

XXX HORIZONTAL FINISH (COUNTERTOP) XXX VERTICAL FINISH (CASEWORK)

COUNTERTOP, CASEWORK OR MISCELLANEOUS FINISH ONLY REFER TO FINISH LEGEND

ACCENT WALL FINISH

FLOORING INSTALL DIRECTION

FINISH PLAN NOTES

- F1 NO WORK IN THIS AREA, UNLESS NOTED OTHERWISE. F2 ALIGN FLOOR TRANSITION TO OUTSIDE CORNER OR AS INDICATED ON PLAN.
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- F4 REFER TO 1/A800 FOR RESTROOM WALL TILE INSTALL; TYP. ALL WALLS. F5 INSTALL PLASTIC LAMINATE (PL2) AS REQUIRED TO UNFINISHED EDGES/FACES OF
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- F8 FULL HEIGHT WALL PADDING TO BE INSTALLED ON ALL WALLS. INSTALL TO BE A TIGHT FIT BETWEEN WOOD BASE AND WOOD CEILING TRIM AND FROM CORNER TO CORNER OR CORNER TO DOOR FRAME. SEE SPECIFICATIONS FOR MORE
- F9 TUBE EXTERIOR TO RECEIVE PAINT (EP-) INDICATED ON PLAN. F10 DOORS AND FRAME TO RECEIVE PAINT (EP-) INDICATED ON PLAN.
- F11 SEE 2/A801B FOR RAMP FLOOR GRAPHIC DETAILS.
- F13 INSTALL WALL BASE (B1) ON EXISTING CASEWORK. ALL WALLS TO RECEIVE EPOXY

KEY PLAN

- F12 EXISTING RAMP HANDRAILS TO RECEIVE PAINT (EP3).
- F14 REFERENCE 1/A505 AND 2/A505 FOR ALL WINDOWS IN CORRIDOR.



SCOPE DRAWINGS: structural, mechanical and electrical systems.

The drawings do not necessarily indicate or describe al


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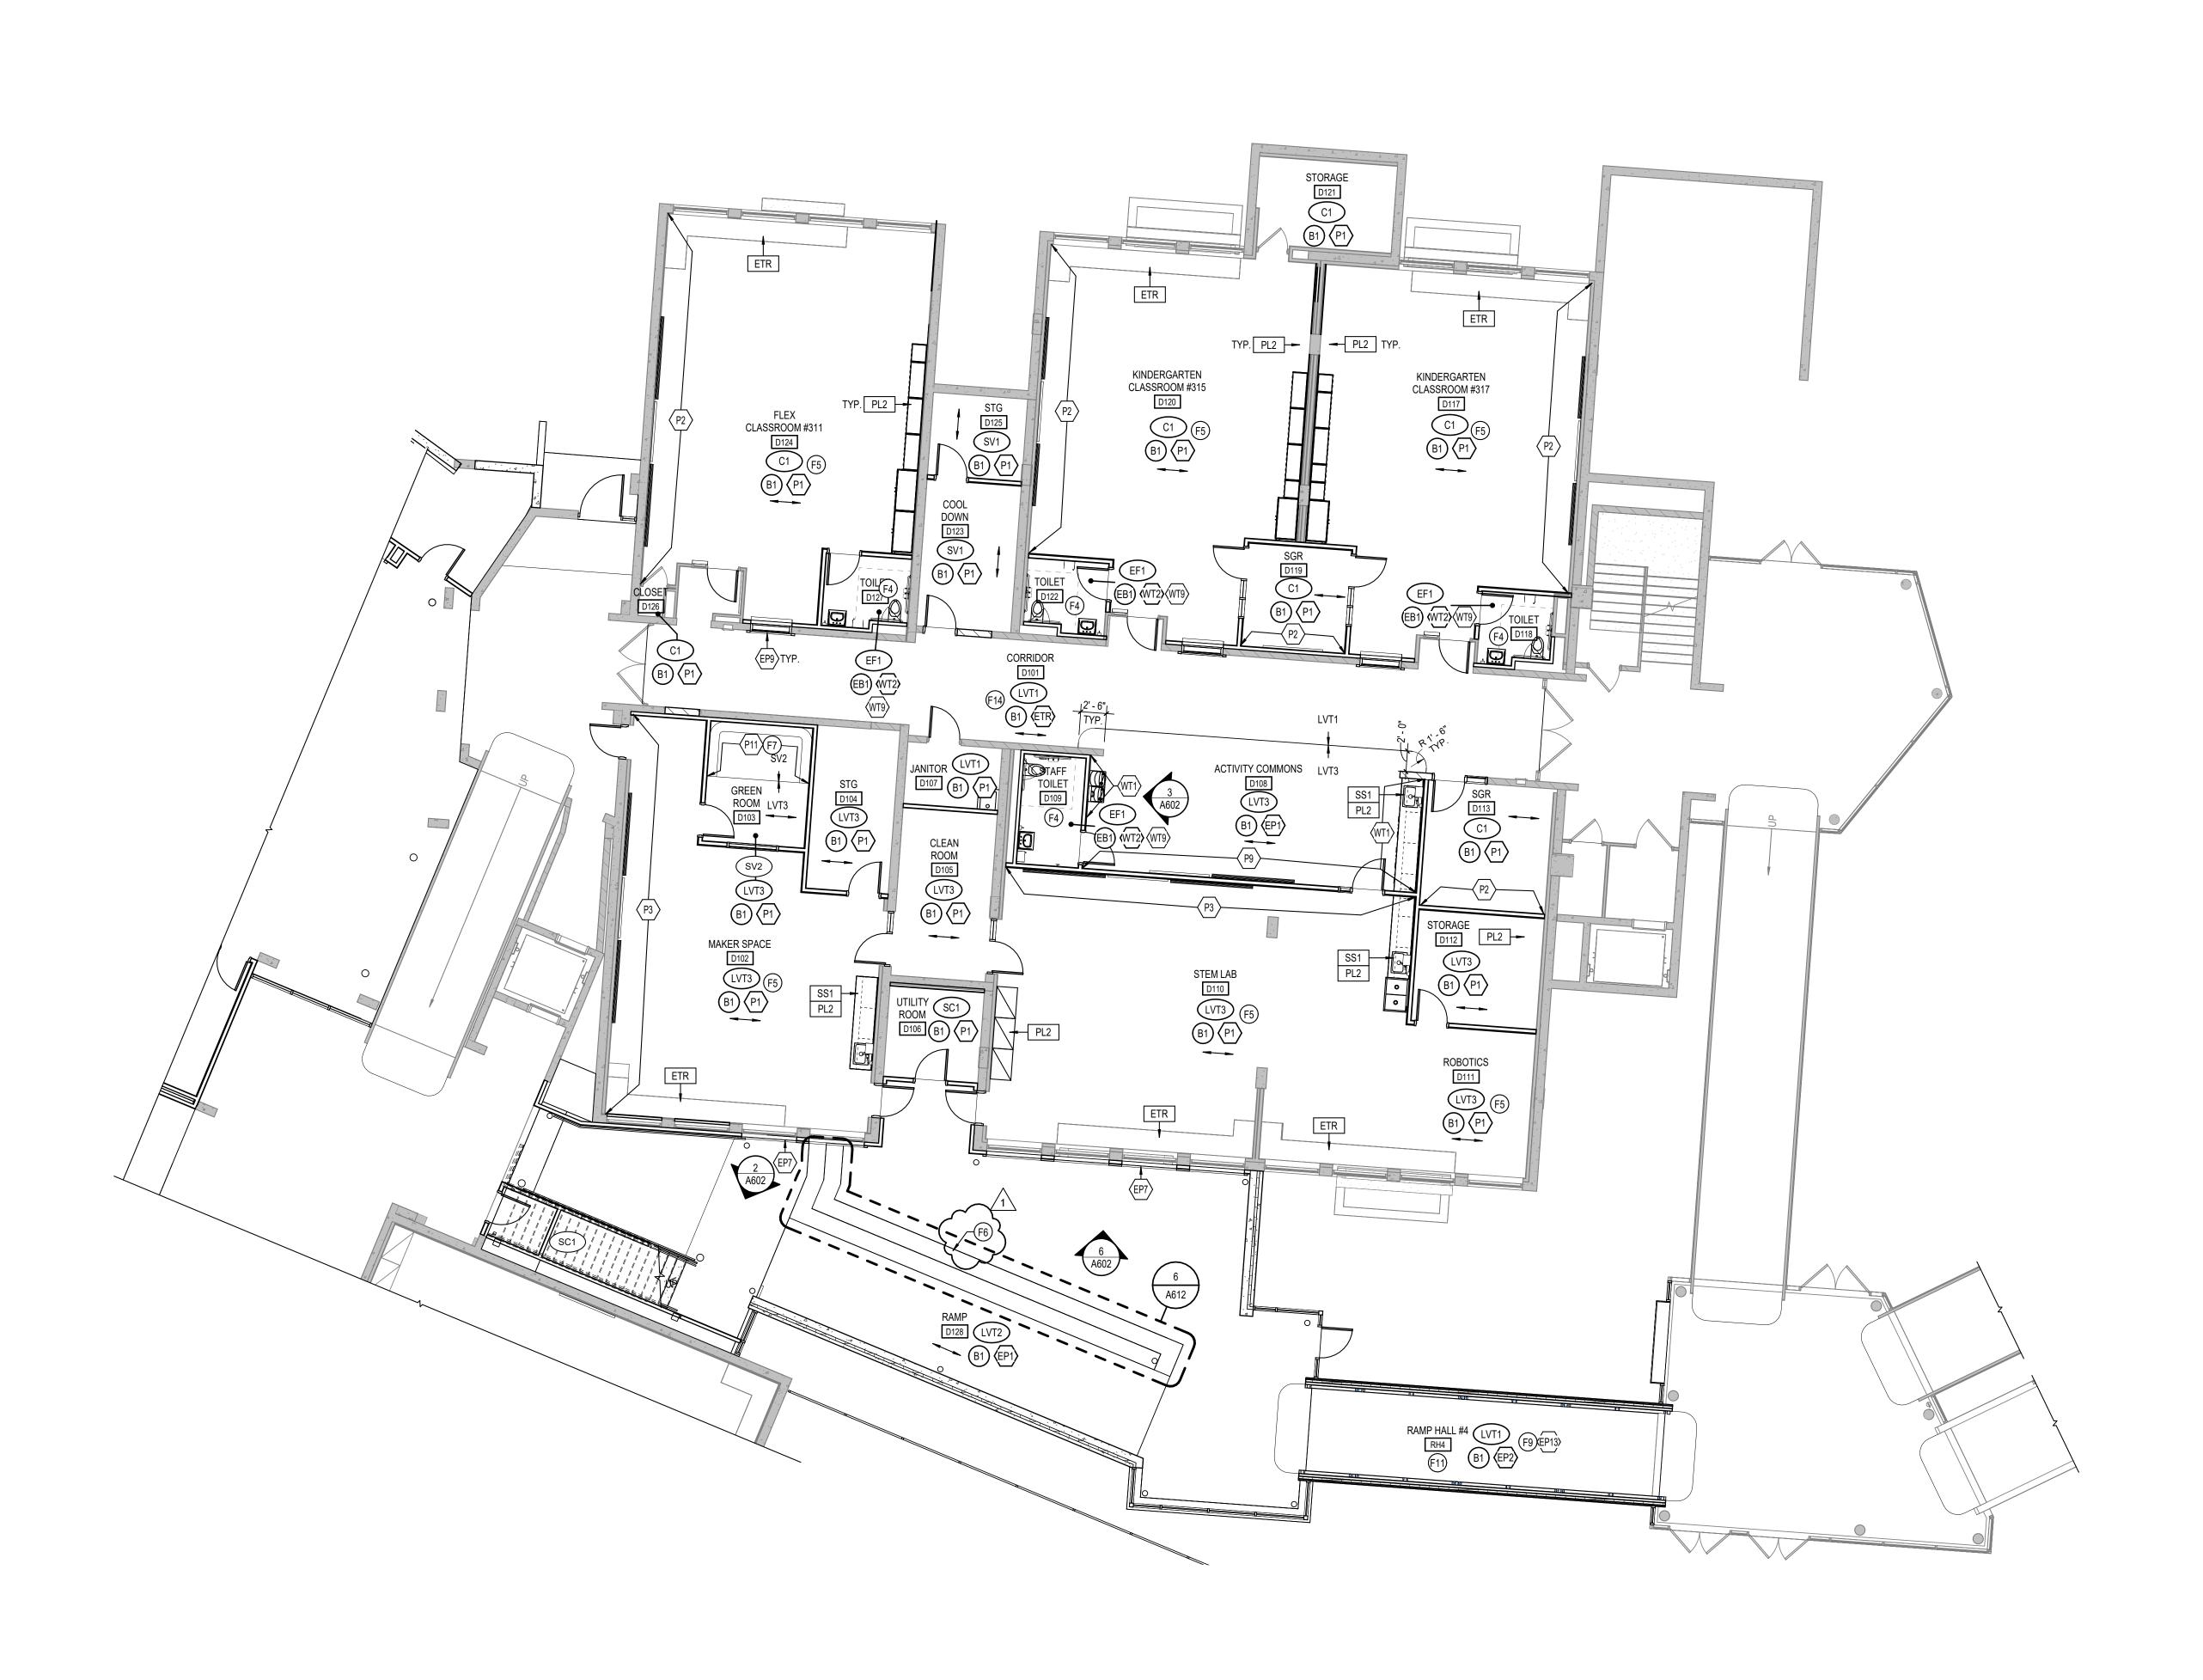
DRAWING TITLE:

01/15/2025 ZER ECN

FINISH PLAN -



DRAWING NUMBER A801C

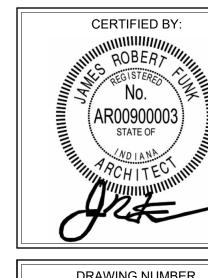

GROUND LEVEL FINISH PLAN - UNIT D

GENERAL FINISH NOTES

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- TO BE TRIMMED WITH SCHLUTER JOLLY IN BRUSHED STAINLESS STEEL FINISH. SEE WALL TRANSITION DETAILS ON A800. 22. WALL TILE TO BE INSTALLED WITH THE MINIMUM RECOMMENDED GROUT THICKNESS. GROUT COLOR TO BE SELECTED FROM MANUFACTURER'S FULL
- RANGE. REFER TO SPECIFICATIONS FOR ADDITIONAL INFORMATION. 23. RESTROOM SINKS TO BE SELECTED FROM MANUFACTURER'S FULL RANGE. SEE SPECIFICATIONS FOR ADDITIONAL INFORMATION. 24. ALL CUSTODIAL MOP SINK LOCATIONS TO RECEIVE FRP. LENGTH AS NECESSARY, MINIMUM OF 2'-0" ON EITHER SIDE OF SINK. FRP TO START AT TOP OF BASE AND

RUN FULL PANEL WIDTH (4'-0"). COLOR TO BE SELECTED FROM MANUFACTURER'S

25. WALL PADDING TO BE SELECTED FROM MANUFACTURER'S FULL RANGE. REFER TO 900 SERIES DRAWINGS AND SPECIFICATIONS FOR ADDITIONAL INFORMATION. 26. CUBICLE CURTAIN TO BE SELECTED FROM MANUFACTURER'S FULL RANGE.

FINISH TAG KEY

XXX FLOOR FINISH

FULL RANGE.

XXX HORIZONTAL FINISH (COUNTERTOP) XXX VERTICAL FINISH (CASEWORK)

COUNTERTOP, CASEWORK OR MISCELLANEOUS FINISH ONLY REFER TO FINISH LEGEND

ACCENT WALL FINISH

FLOORING INSTALL DIRECTION

FINISH PLAN NOTES

- F1 NO WORK IN THIS AREA, UNLESS NOTED OTHERWISE.
- F2 ALIGN FLOOR TRANSITION TO OUTSIDE CORNER OR AS INDICATED ON PLAN. F3 PATCH/REPAIR FLOOR, WALL, AND BASE AS REQUIRED BY DEMOLITION AND NEW CONSTRUCTION TO MATCH EXISTING.
- F4 REFER TO 1/A800 FOR RESTROOM WALL TILE INSTALL; TYP. ALL WALLS. F5 INSTALL PLASTIC LAMINATE (PL2) AS REQUIRED TO UNFINISHED EDGES/FACES OF
- EXISTING CASEWORK. F6 SEATING TO RECEIVE ARCHITECTURAL FILM (FM1) ON VERTICAL SURFACES AND
- SOLID SURFACE (SS3) ON HORIZONTAL SURFACES. SEE FLOOR AND WALL TRANSITION DETAILS ON A800. 7 PAINT (P11) AND SHEET VINYL (SV2) TO ALIGN W/ EXTENTS OF CYCLORAMA BUILT-IN
- COVE BASE WALL SYSTEM; SEE A900 SERIES AND SPECS FOR MORE INFORMATION. F8 FULL HEIGHT WALL PADDING TO BE INSTALLED ON ALL WALLS. INSTALL TO BE A TIGHT FIT BETWEEN WOOD BASE AND WOOD CEILING TRIM AND FROM CORNER TO CORNER OR CORNER TO DOOR FRAME. SEE SPECIFICATIONS FOR MORE
- F9 TUBE EXTERIOR TO RECEIVE PAINT (EP-) INDICATED ON PLAN. F10 DOORS AND FRAME TO RECEIVE PAINT (EP-) INDICATED ON PLAN.
- F11 SEE 2/A801B FOR RAMP FLOOR GRAPHIC DETAILS.
- F12 EXISTING RAMP HANDRAILS TO RECEIVE PAINT (EP3).
- F13 INSTALL WALL BASE (B1) ON EXISTING CASEWORK. ALL WALLS TO RECEIVE EPOXY
- F14 REFERENCE 1/A505 AND 2/A505 FOR ALL WINDOWS IN CORRIDOR.




SCOPE DRAWINGS:

REVISIONS: ADDENDUM #1 01/29/2025


ISSUE DATE | DRAWN BY | CHECKED BY

01/15/2025 ZER ECN DRAWING TITLE:


GROUND LEVEL FINISH PLAN -UNIT D

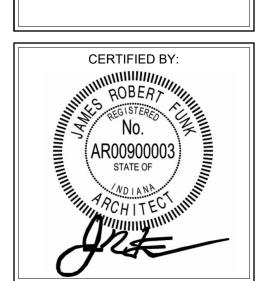

A801D

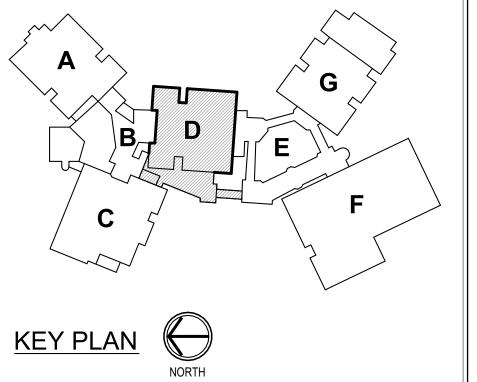

NEW SPECIALTY EQUIPMENT SCHEDULE							
TYPE MARK	DESCRIPTION	SPEC SECTION	MANUFACTURER	MODEL NO.	REMARKS	FURNISHED BY	INSTALLED BY
AP1	REFRIGERATOR W/ ICE MAKER.	-	-	-	COORDINATE HOOK-UPS PER ELECTRICAL/PLUMBING DRAWINGS.	OWNER	OWNER
AP2	VENDING MACHINE	-	-	-	EXISTING TO SALVAGE, REMOVED AND RELOCATED	OWNER	OWNER
AP3	MINI FRIDGE		FRIGIDAIRE	FFPE3322UM		CONTRACTOR	CONTRACTOR
CY1	CYCLORAMA BUILT-IN COVE BASE WALL SYSTEM	11 62 00	PRO-CYC	-	PROVIDE BASE TO WALL AND WALL TO WALL COVE FOR COMPLETE SYSTEM	CONTRACTOR	CONTRACTOR
DC1	Non-Rated Wall, 1491 Steel, Surface Mounted		Activar Construction Products Group	1491			
FEC	1026 Aluminum, 1 1/2" square trim		Activar Construction Products Group	Academy 1026			
MB1	6'-0"W X 5'-0"H SALVAGED MARKER BOARD	10 11 00	CLARIDGE	Series 1	MATCH MOUNTING HEIGHT OF EXISTING	<varies></varies>	<varies></varies>
MB2	4'-0" High Fixed Marker Board	10 11 00	Claridge	Series 1		-	-
RS1	MANUALLY OPERATED SINGLE ROLLER SHADE	12 24 13	DRAPER INC.	-	ROLLER SHADE TO BE FULL WIDTH OF WINDOW	CONTRACTOR	CONTRACTOR
RS2	14'-6" LENGHTH DUAL ROLLER SHADE		DRAPER INC.	Dual Roller FlexShade	ROLLER SHADE TO BE INSTALLED ABOVE CEILING	CONTRACTOR	CONTRACTOR
RS3	9'-4" LENGHTH DUAL ROLLER SHADE		DRAPER INC.	Dual Roller FlexShade	ROLLER SHADE TO BE INSTALLED ABOVE CEILING	CONTRACTOR	CONTRACTOR
SW1	SOUND-ABSORBING WALL UNIT	09 84 33	TURF ACOUSTICS	CUSTOM	CONTACT MICHELLE MOUSER AT MICHELLE@GREATAPG.COM FOR ADDITIONAL INFORMATION.	CONTRACTOR	CONTRACTOR
SWD1	STACKED WASHER / DRYER		WHIRLPOOL	WETLV27HW		OWNER	OWNER
T9	24" x 24" ACCESS PANEL		NYSTROM	NTL 24x24	-	CONTRACTOR	CONTRACTOR
T10	BABY CHANGING STATION - WALL MOUNTED		Koala Kare	KB300-SS	MOUNT PER MFR'S INSTRUCTIONS TO MEET ACCESSIBILITY REQUIREMENTS	CONTRACTOR	CONTRACTOR
T11	ROBE HOOK - SURFACE MOUNTED		BOBRICK	B-672	MOUNT @ 40" AFF TO TOP	CONTRACTOR	CONTRACTOR
VM1	FLAT PANEL MONITOR		-	-		CONTRACTOR	CONTRACTOR
VM2	FLAT PANEL MONITOR		-	-		CONTRACTOR	CONTRACTOR
xCO1							
XMB1	8'-0" W X 5'-0" H SALVAGED MARKER BOARD	10 11 00	CLARIDGE	SEE SPECS	EXISTING TO SALVAGE, REMOVED AND RELOCATED, MOUNT TOP @ +(7'-0")	<varies></varies>	<varies></varies>
XMB2	8'-0" W X 5'-0" H SALVAGED MARKER BOARD	10 11 00	CLARIDGE	SEE SPECS	EXISTING TO SALVAGE, REMOVED AND RELOCATED	-	-
XTB0	4'-0"W X 4'-0"H TACK BOARD	10 11 00	CLARIDGE	SEE SPECS	EXISTING TO SALVAGE, REMOVED AND RELOCATED	CONTRACTOR	CONTRACTOR
XTB1	6'-0"W X 5'-0"H SALVAGED TACK BOARD	10 11 00	CLARIDGE	SEE SPECS	EXISTING TO SALVAGE, REMOVED AND RELOCATED	CONTRACTOR	CONTRACTOR
XTB4	10'-0"W X 5'-0"W SALVAGED TACK BOARD	10 11 00	CLARIDGE	SEE SPECS	EXISTING TO SALVAGE, REMOVED AND RELOCATED	CONTRACTOR	CONTRACTOR

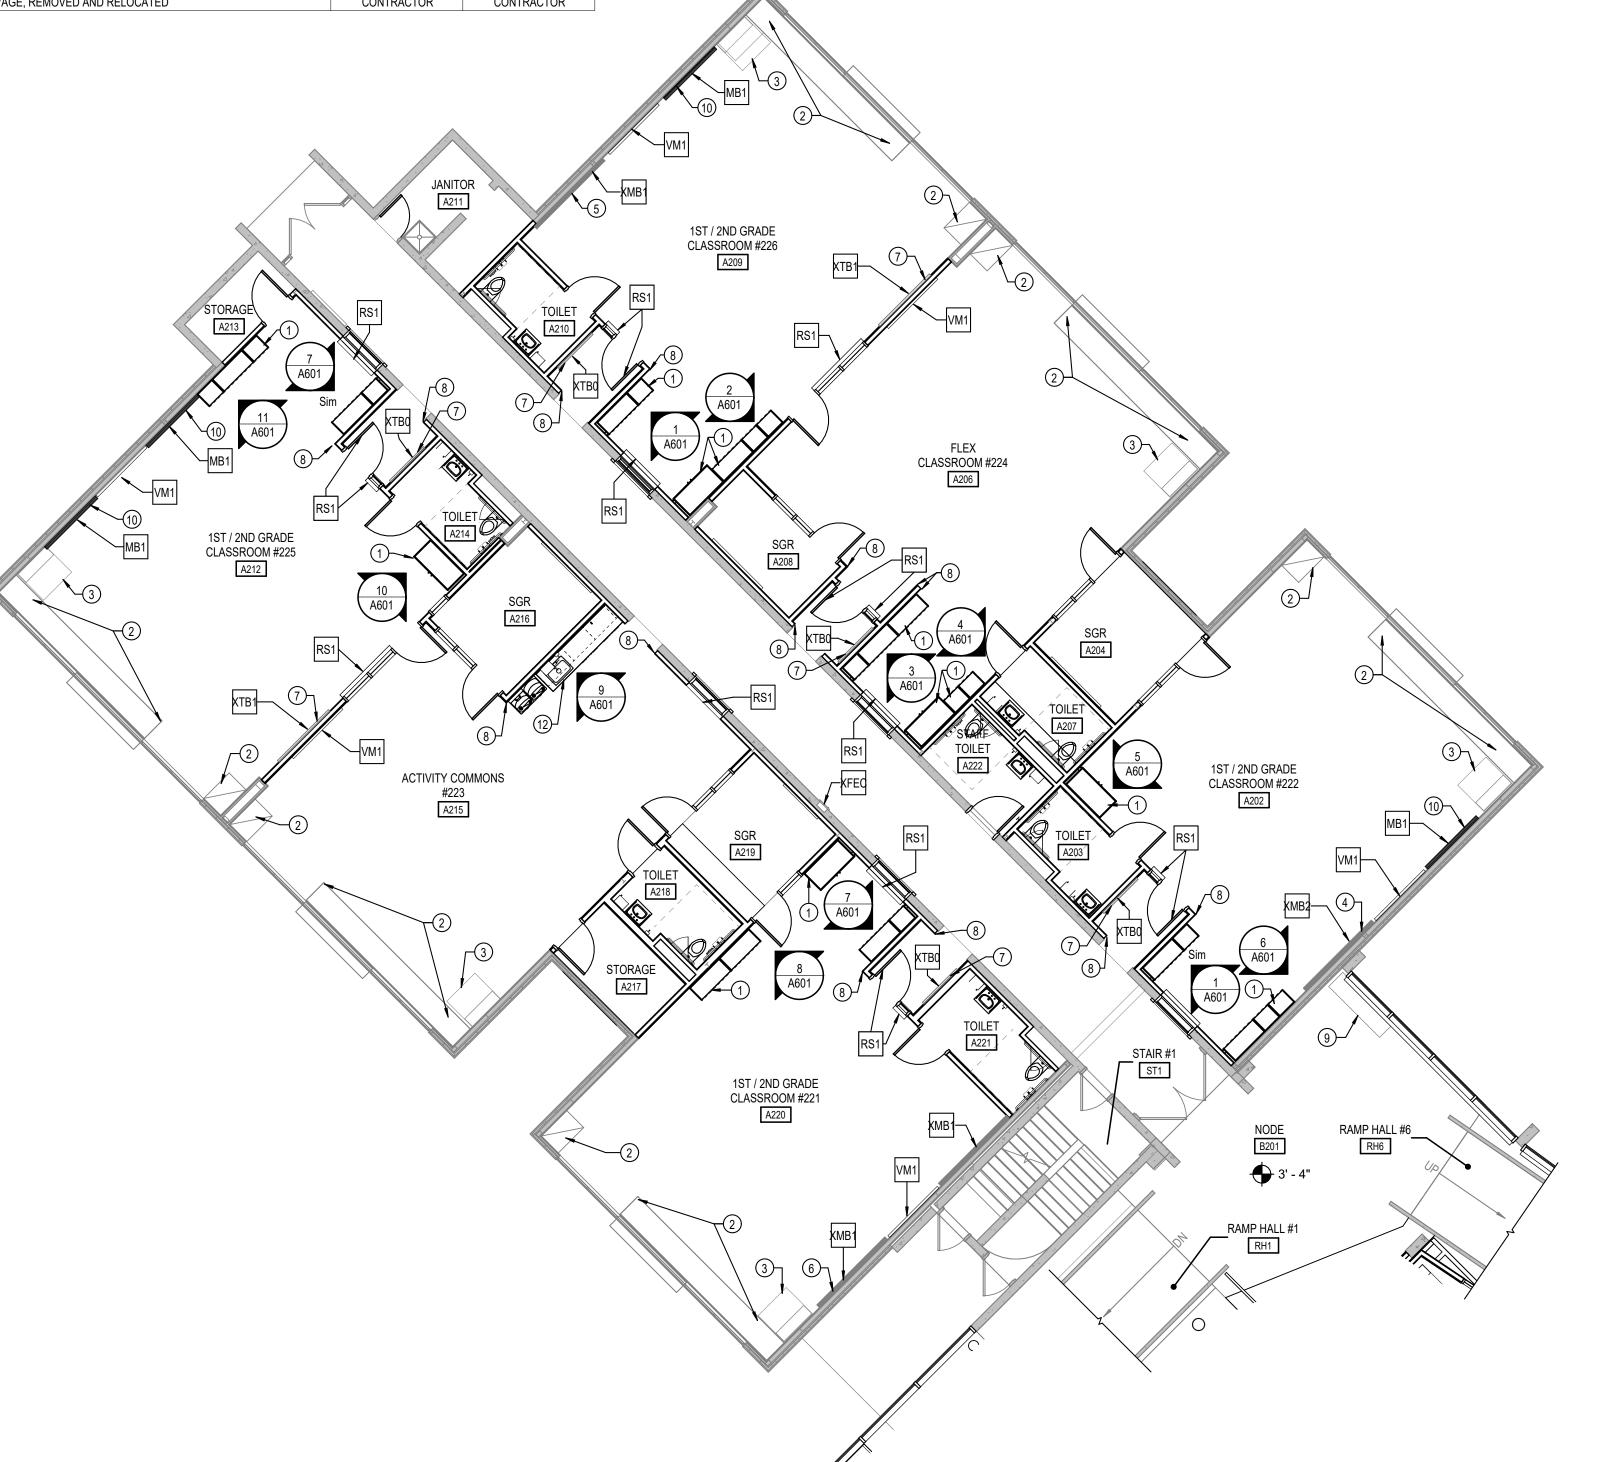

GROUND LEVEL EQUIPMENT PLAN - UNIT A

SCALE: 1/8" = 1'-0"

GENERAL EQUIPMENT NOTES

- A. SEE A701 FOR ENLARGED TOILET ROOM PLANS INCLUDING TOILET ACCESSORIES AND SCHEDULES.
- B. REFER TO A600 SERIES DRAWINGS FOR CASEWORK AND MILLWORK ELEVATIONS AND SCHEDULES.

EQUIPMENT PLAN NOTES

- 1 REUSED EXISTING CASEWORK, SEE A900 SERIES AND A600 SERIES FOR MORE INFORMATION. PROVIDE MATCHING NEW END PANELS AND FILLER PANELS AT NEWLY EXPOSED SIDES OR DAMAGED SIDES OF CABINETS AND TOP TO BULKHEADS AS REQUIRED. FIELD VERIFY ALL EXISTING AND NEW CONDITIONS PRIOR TO RELOCATION AND INSTALLATION.
- 2 EXISTING CASEWORK, INCLUDING SHELVING, CABINETS AND/OR COUNTERTOPS WHERE APPLICABLE, TO REMAIN. 3 VERTICAL UNIT VENTILATOR. SEE MECHANICAL DRAWINGS FOR MORE INFORMATION.
- 4 RELOCATE EXISTING MARKER BOARD FROM OPPOSITE SIDE OF ROOM TO THIS WALL AS INDICATED. MOUNTING HEIGHT TO MATCH EXISTING.
- 5 EXISTING VISUAL DISPLAY UNITS TO REMAIN AT SAME LOCATION, INCLUDING TACK BOARDS AND MARKER BOARDS. 6 RELOCATED EXISTING MARKER BOARD. MOUNTING HEIGHT TO MATCH EXISTING.
- 7 RELOCATED EXISTING TACK BOARD. MOUNTING HEIGHT TO MATCH EXISTING. 8 CORNER GUARD, MATCH DOOR FRAME HEIGHT. REFER TO 800 SERIES FOR FINISH
- INFORMATION. 9 MECHANICAL UNIT, SEE MECHANICAL DRAWINGS FOR MORE INFORMATION.
- 10 NEW MARKER BOARD. MOUNTING HEIGHT TO MATCH EXISTING. 12 NEW CASEWORK, SEE A600 SERIES FOR CASEWORK DESCRIPTIONS AND A800 SERIES
- FOR FINISHES.
- 13 STACKED WASHER AND DRYER OWNER PROVIDED.






ADDENDUM #1 01/29/2025


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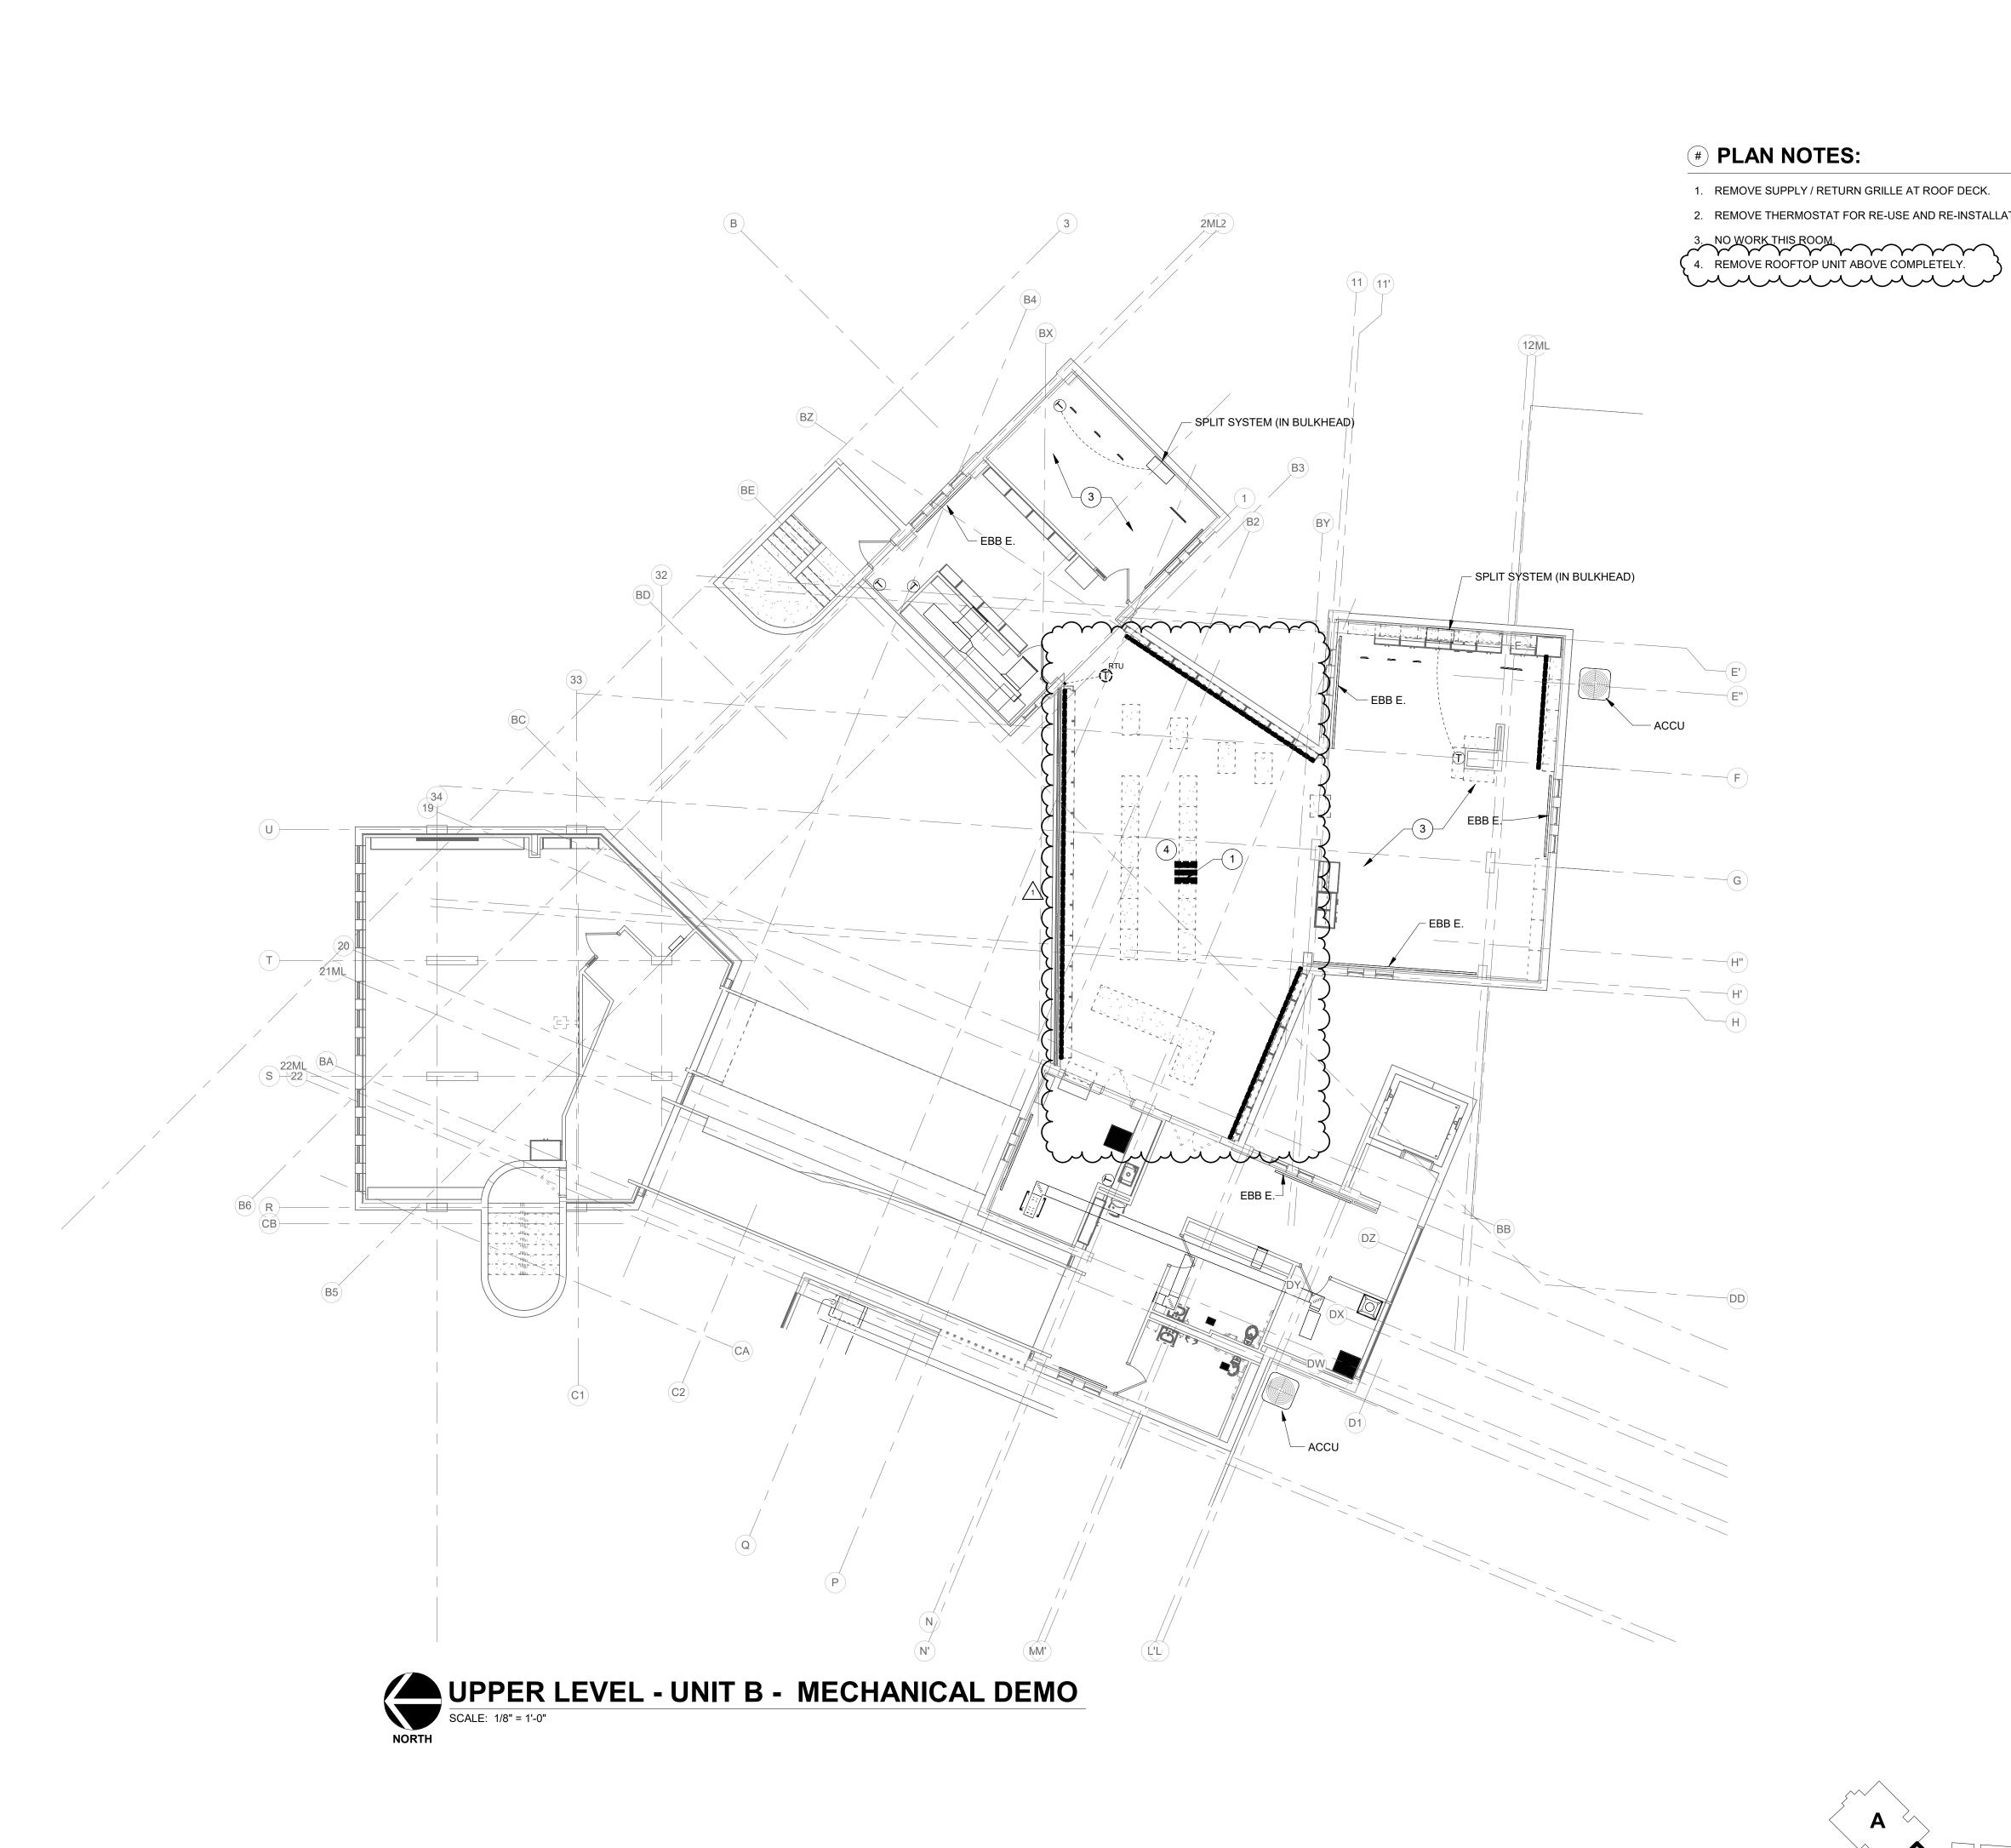
01/15/2025 ZER ECN DRAWING TITLE:

EQUIPMENT PLAN - UNIT A

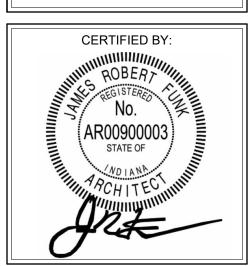

A901A



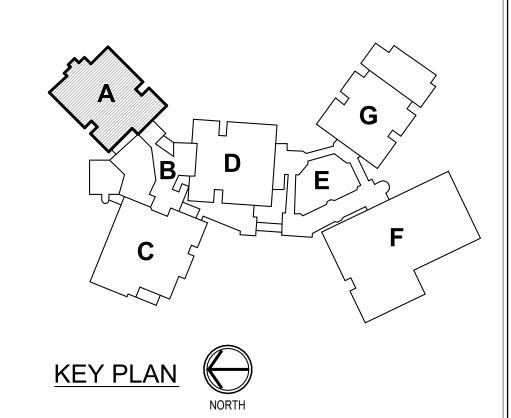




WORK TO BE REMOVED

WORK TO REMAIN

GENERAL NOTES - DEMOLITION:

1. SEE MD201 FOR GENERAL NOTES.

2. REMOVE THERMOSTAT FOR RE-USE AND RE-INSTALLATION. SEE M213B.

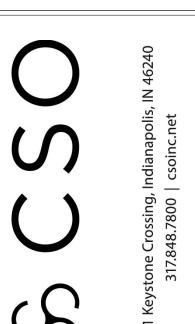



SCOPE DRAWINGS:

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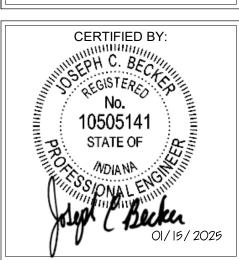
On the basis of the general scope indicated or described, the trade contractors shall furnish all items required for the proper execution and completion of the work.

REVISIONS: 1 ADDENDUM #01 01/29/25

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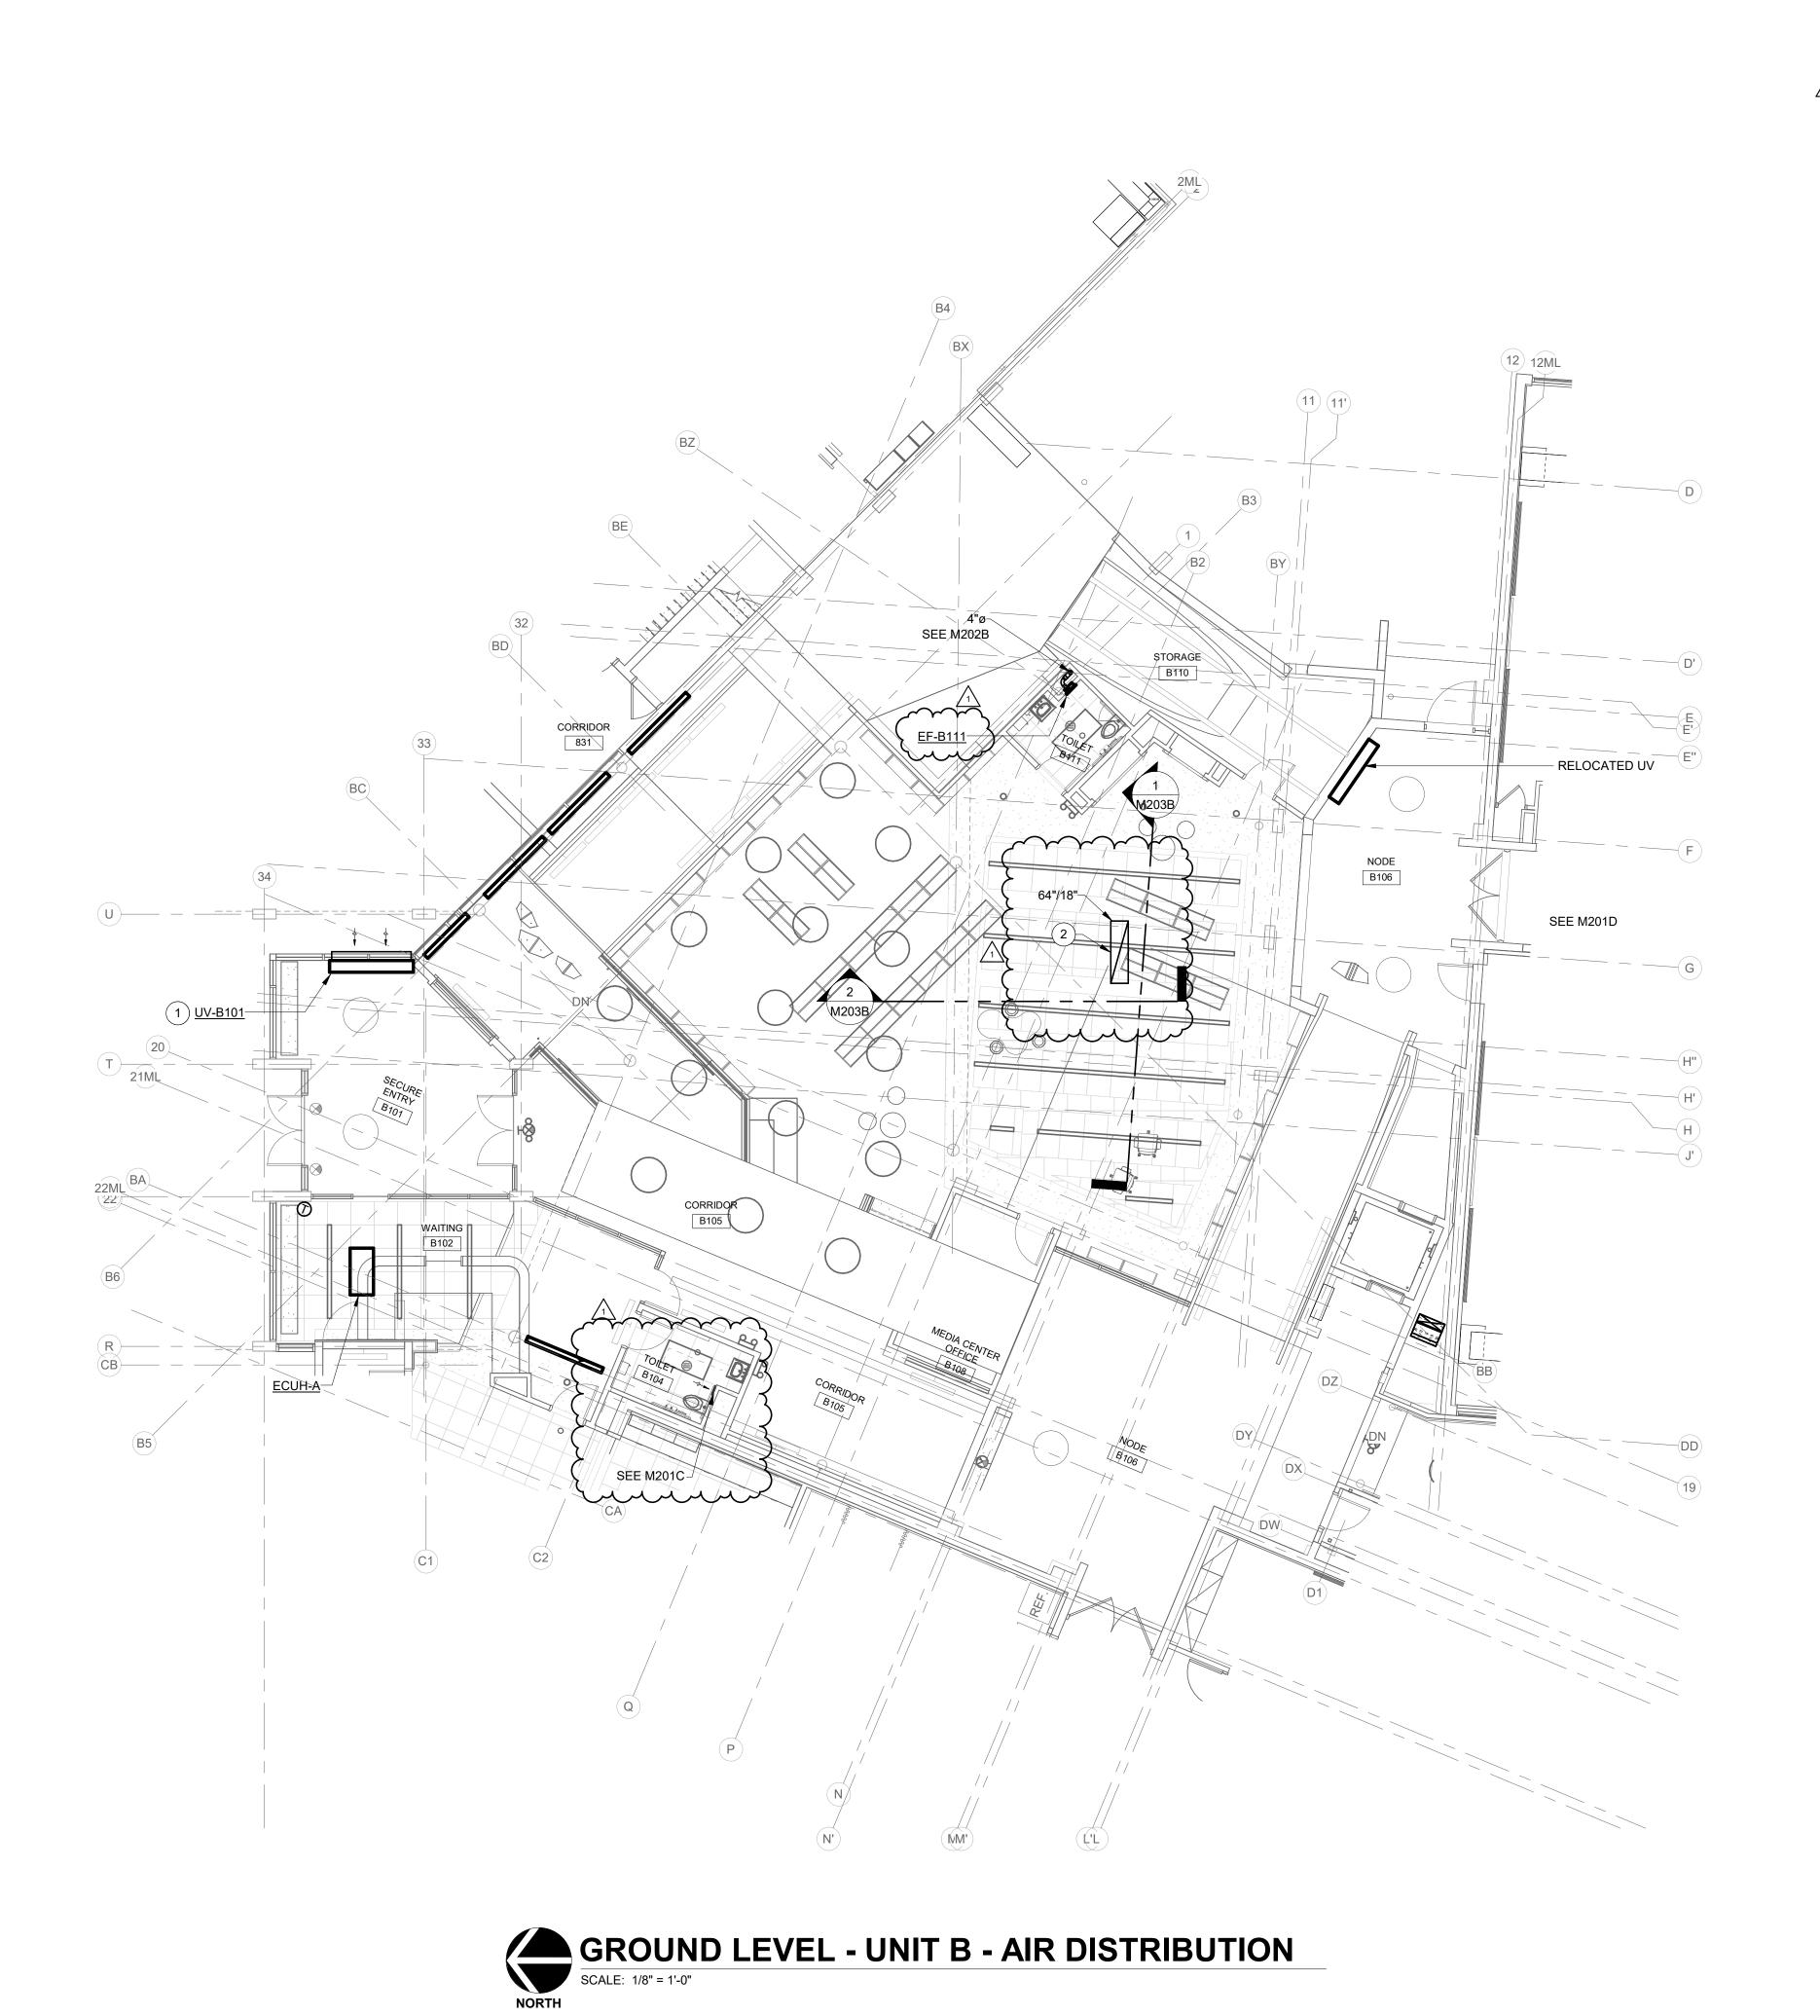
DRAWING TITLE: **UPPER LEVEL** UNIT B -MECHANICAL **DEMOLITION**



DRAWING NUMBER MD203B

PROJECT NUMBER 2024023







WORK TO BE INSTALLED

WORK TO REMAIN

GENERAL NOTES - AIR DISTRIBUTION:

SEE SHEET M201A FOR ADDITIONAL GENERAL NOTES.

PLAN NOTES:

1. INSTALL UNIT VENTILATOR, WALL SLEEVE AND LOUVER.

2. AHU-B1 RETURN DUCT THROUGH SECOND LEVEL SLAB. TERMINATION OF SLAB WITH EXPANDED METAL MESH OVER OPENING.

1 ADDENDUM #01 01/29/25

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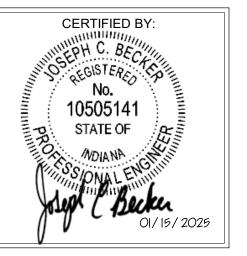
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01/15/25 JCB JCB

DRAWING TITLE:
GROUND LEVEL
- UNIT B AIR


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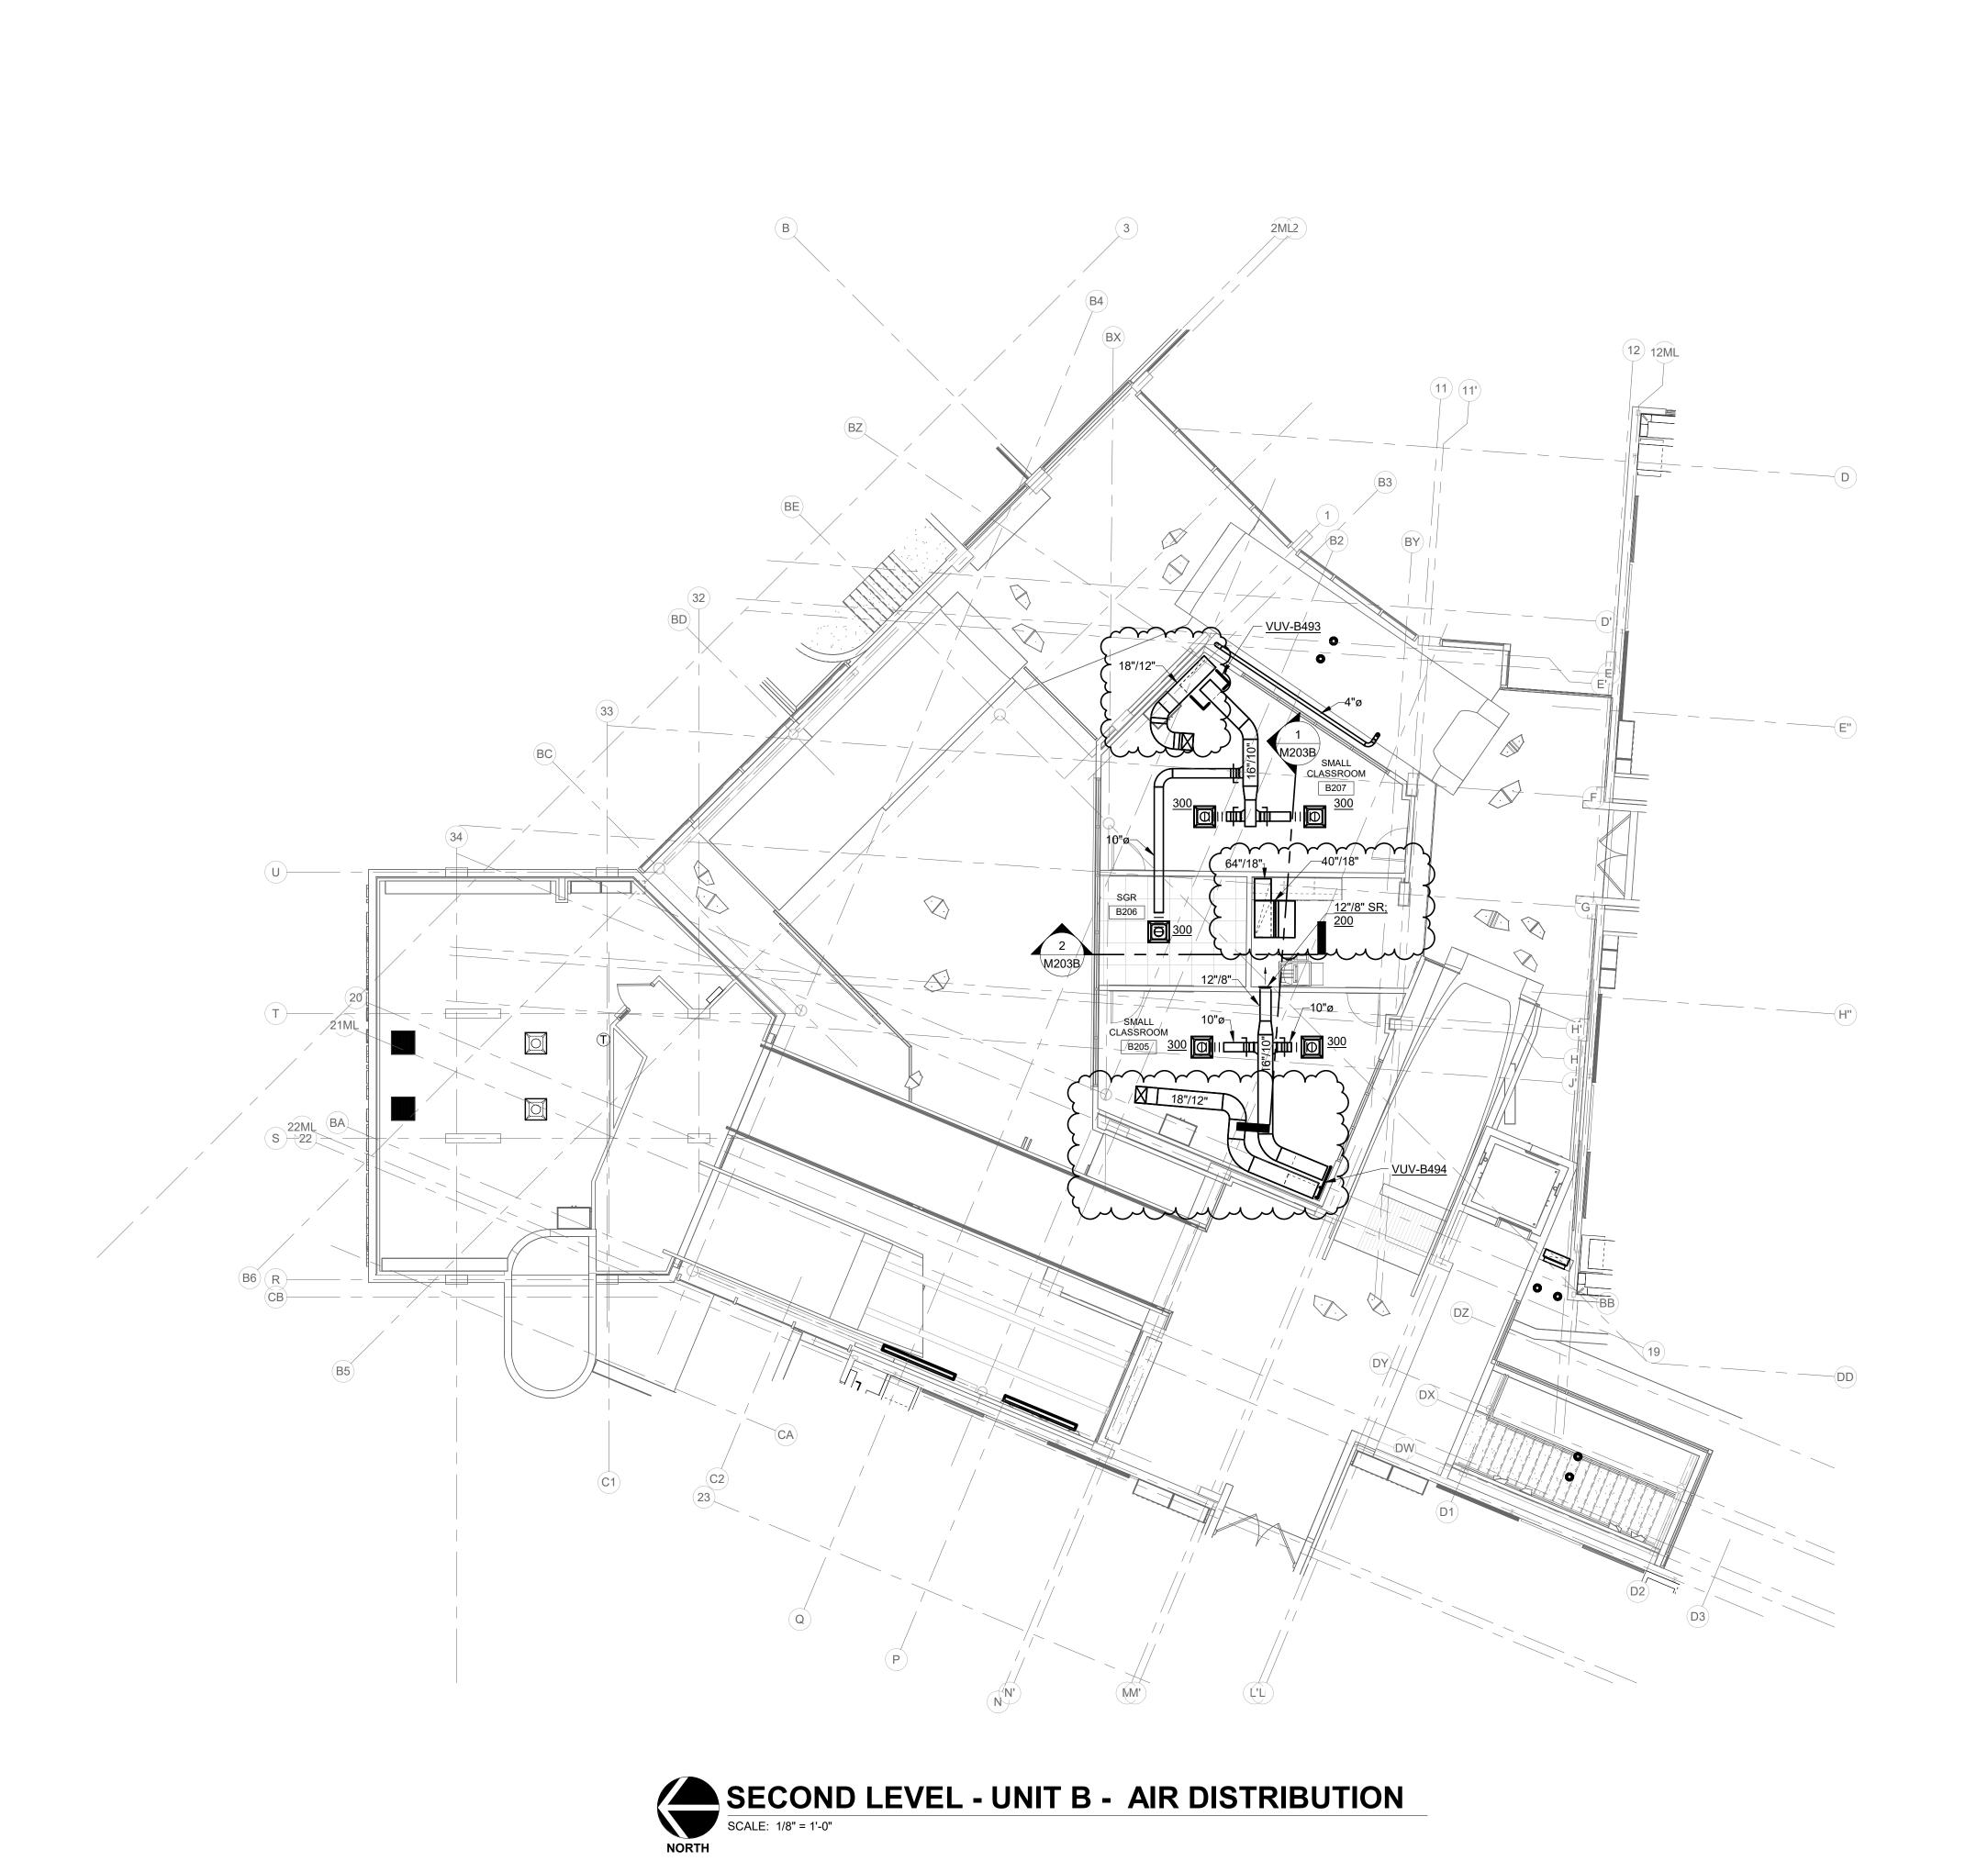


M201B

PROJECT NUMBER 2024023

0 2 4 6 8 16 24 32



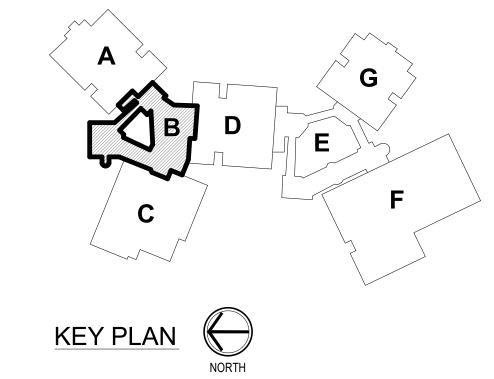



WORK TO BE INSTALLED

WORK TO REMAIN

GENERAL NOTES - AIR DISTRIBUTION:

SEE SHEET M201A FOR ADDITIONAL GENERAL NOTES.

PLAN NOTES:

1. PLAN NOTE #1.

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Systone Crossing, Indianapolis, IN 46240

Inc.

Consulting Engineers

ARTHOLOMEW CONSOLIDATED
SCHOOL CORPORATION
RENOVATIONS TO
RANCES SMITH ELEMENTAF

SCOPE DRAWINGS:
rawings indicate the general scope of the project rechitectural design concept, the dimensions of the major architectural elements and the type mechanical and electrical systems. wings do not necessarily indicate or describe all d for full performance and completion of the s of the Contract.

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REVISIONS: 1 ADDENDUM #01 01/29/25

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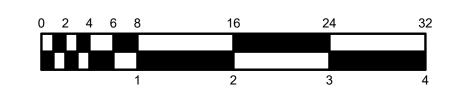
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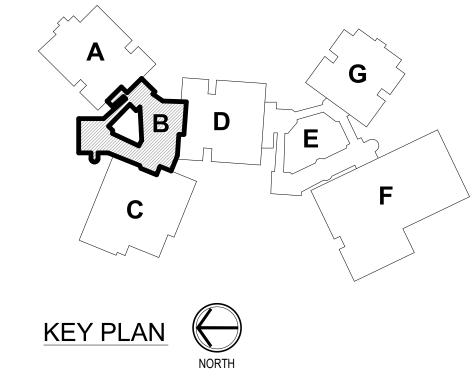
DRAWING TITLE:
SECOND LEVEL
- UNIT B AIR


AIR DISTRIBUTION



M202B





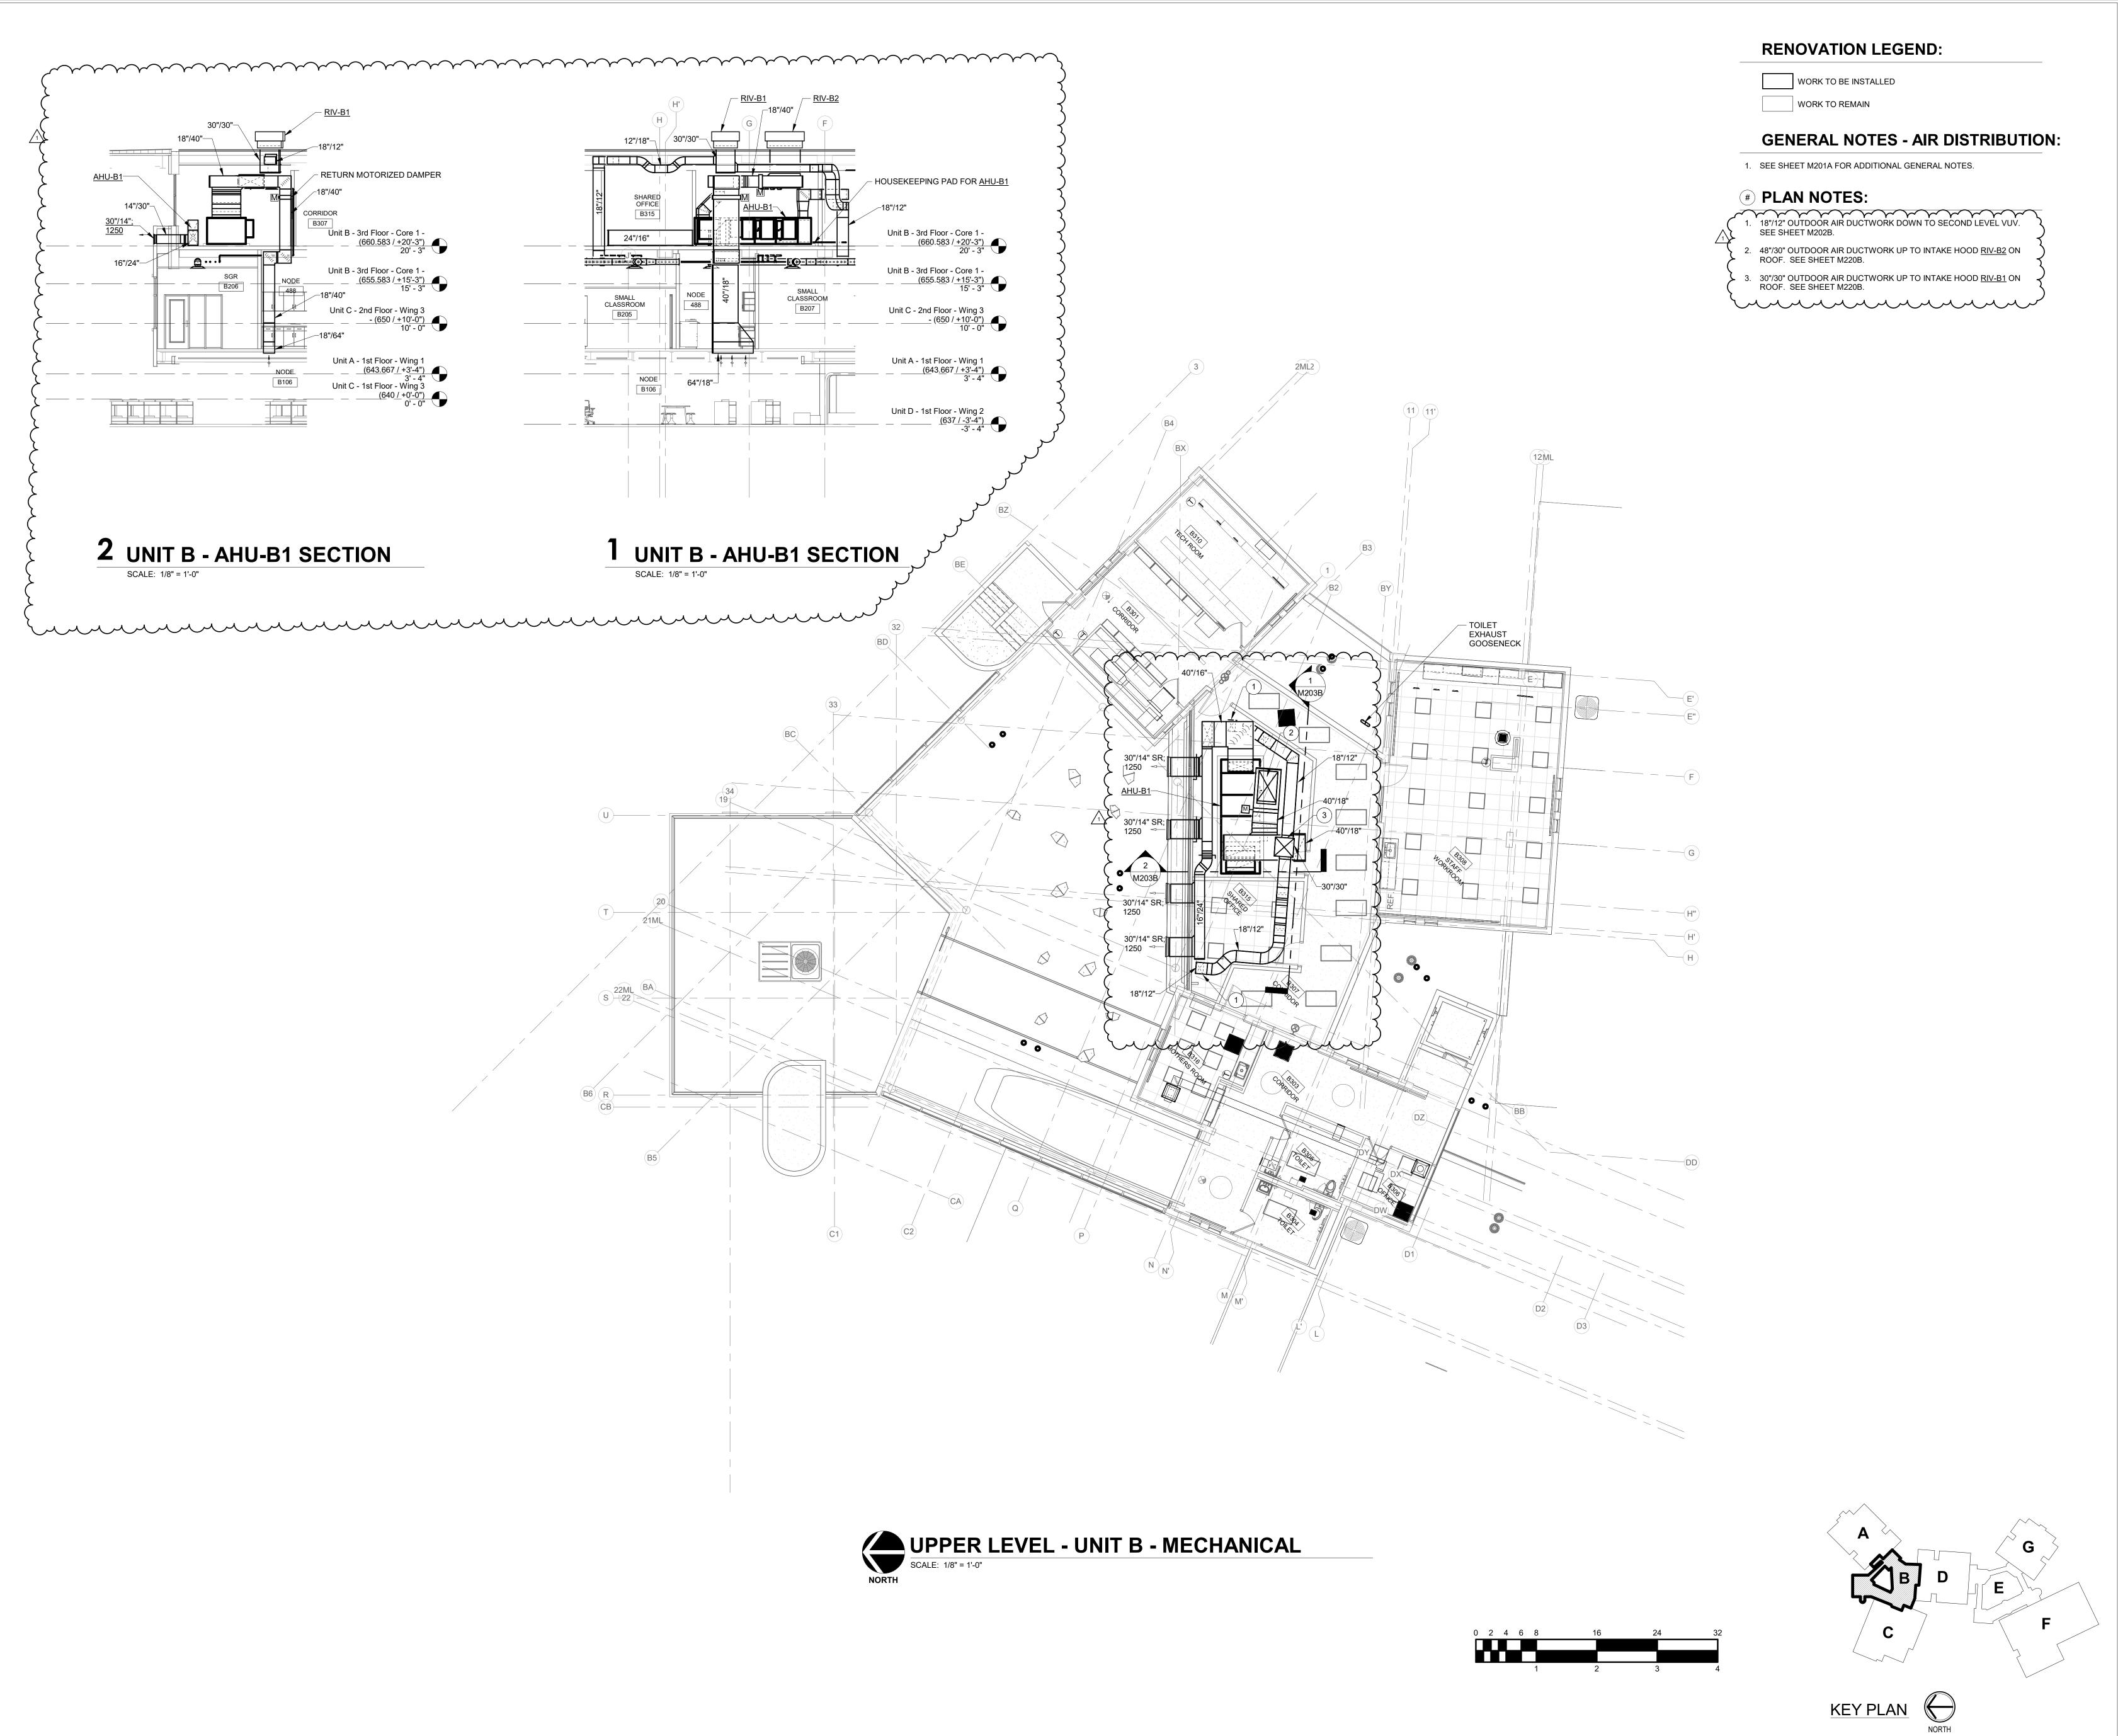



, Indianapolis, IN 46240

8831 Keystone Crossing, Ir

Consulting Engineers

BARTHOLOMEW CONSOLIDATED
SCHOOL CORPORATION
RENOVATIONS TO
FRANCES SMITH ELEMENTAR

SCOPE DRAWINGS:

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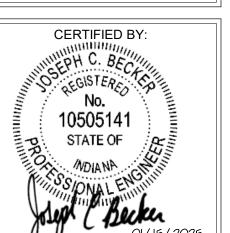
On the basis of the general scope indicated or described, the trade contractors shall furnish all items required for the proper execution and completion of the work.

REVISIONS: 1 ADDENDUM #01 01/29/25


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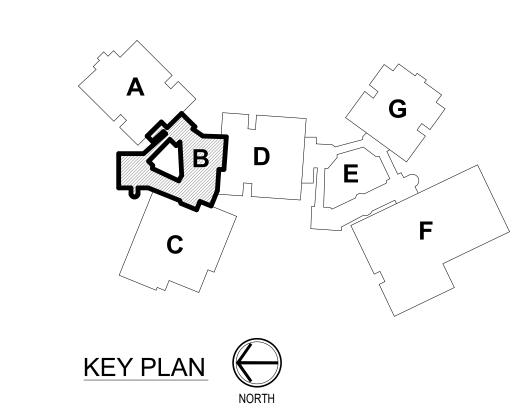
UPPER LEVEL UNIT B MECHANICAL




M203B





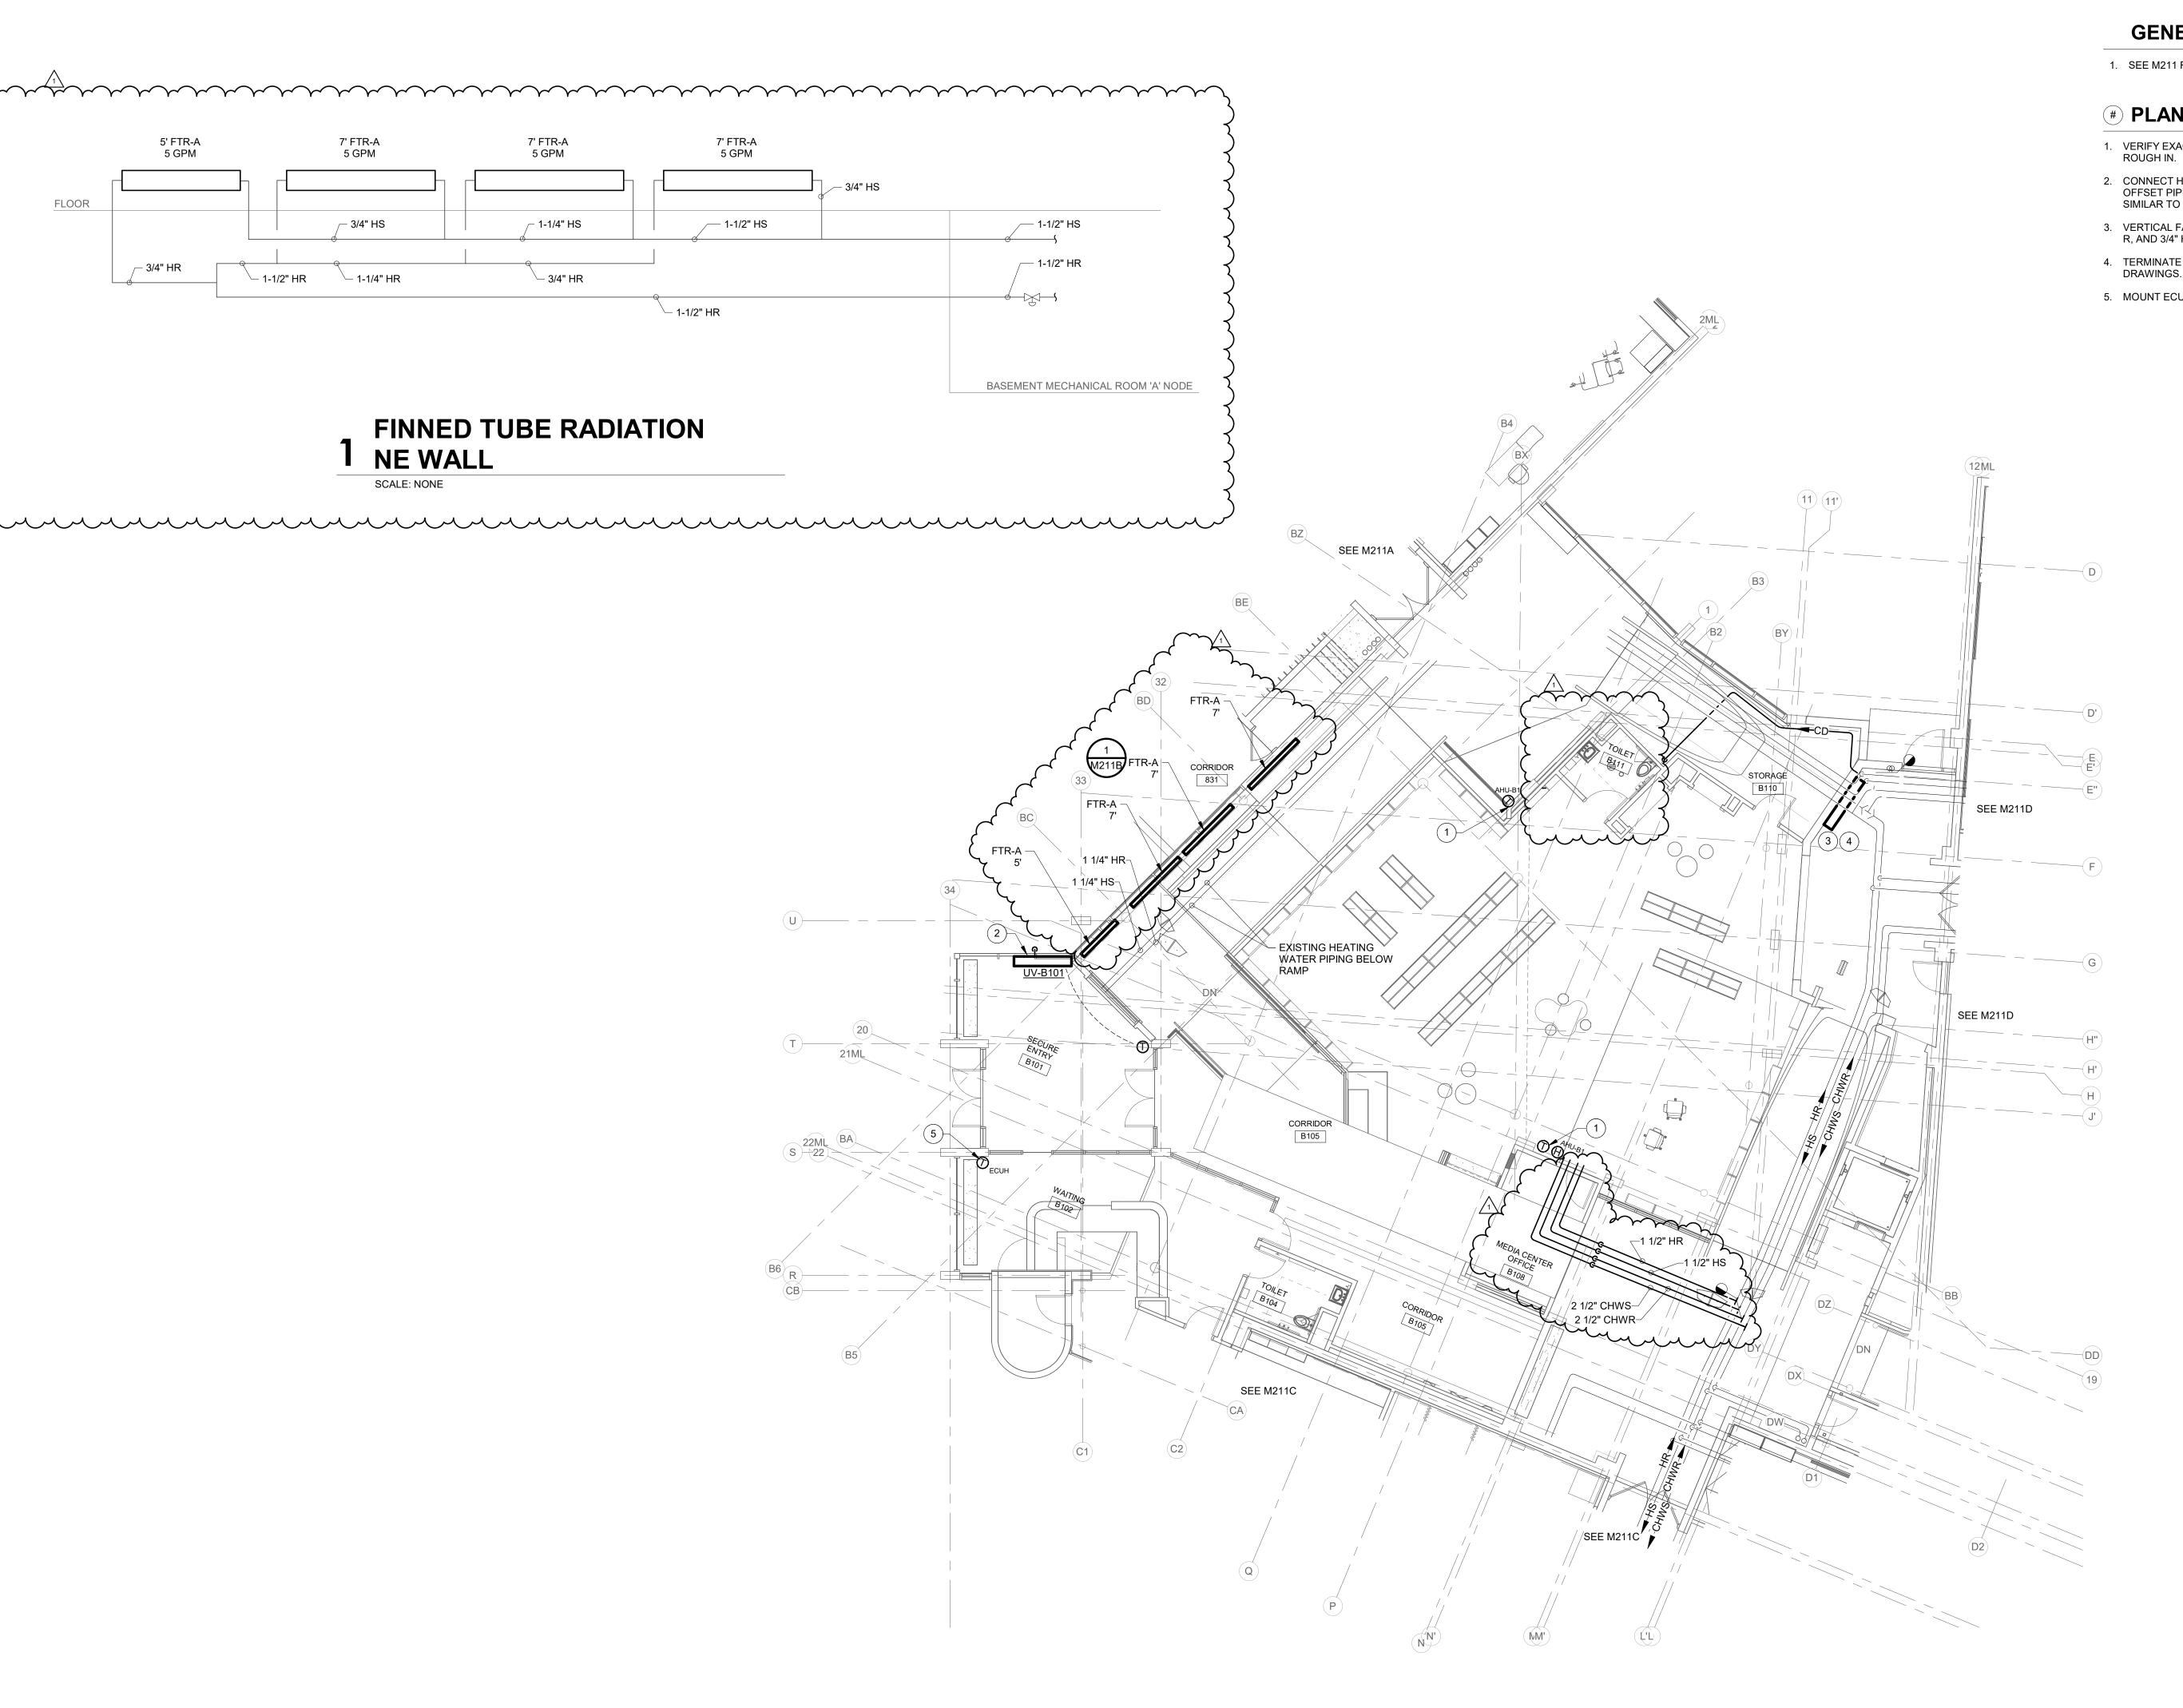

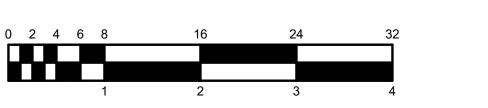



WORK TO BE INSTALLED WORK TO REMAIN

GENERAL NOTES - HYDRONICS:

1. SEE M211 FOR GENERAL NOTES.

PLAN NOTES:

- 1. VERIFY EXACT LOCATION OF THERMOSTAT WITH ENGINEER PRIOR TO
- CONNECT HEATING WATER PIPING FROM BELOW TO UNIT VENTILATOR.
 OFFSET PIPING AT FLOOR, AS REQUIRED. TERMINATE CONDENSATE
 SIMILAR TO EXISTING.
- 3. VERTICAL FAN COIL UNIT TO BE MOUNTED ON WALL. EXTEND 3/4" CHWS & R, AND 3/4" HS & HR PIPING TO UNIT AND CONNECT.
- TERMINATE CONDENSATE DRAIN OVER FLOOR DRAIN. SEE P-SERIES DRAWINGS.
- 5. MOUNT ECUH REMOTE THERMOSTAT ON INSULATED BASE.

SCOPE DRAWINGS:

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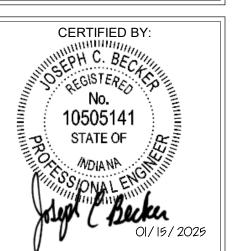
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1 ADDENDUM #01 01/29/25


DRAWING TITLE:

JCB

- UNIT B -**HYDRONICS**



DRAWING NUMBER M211B

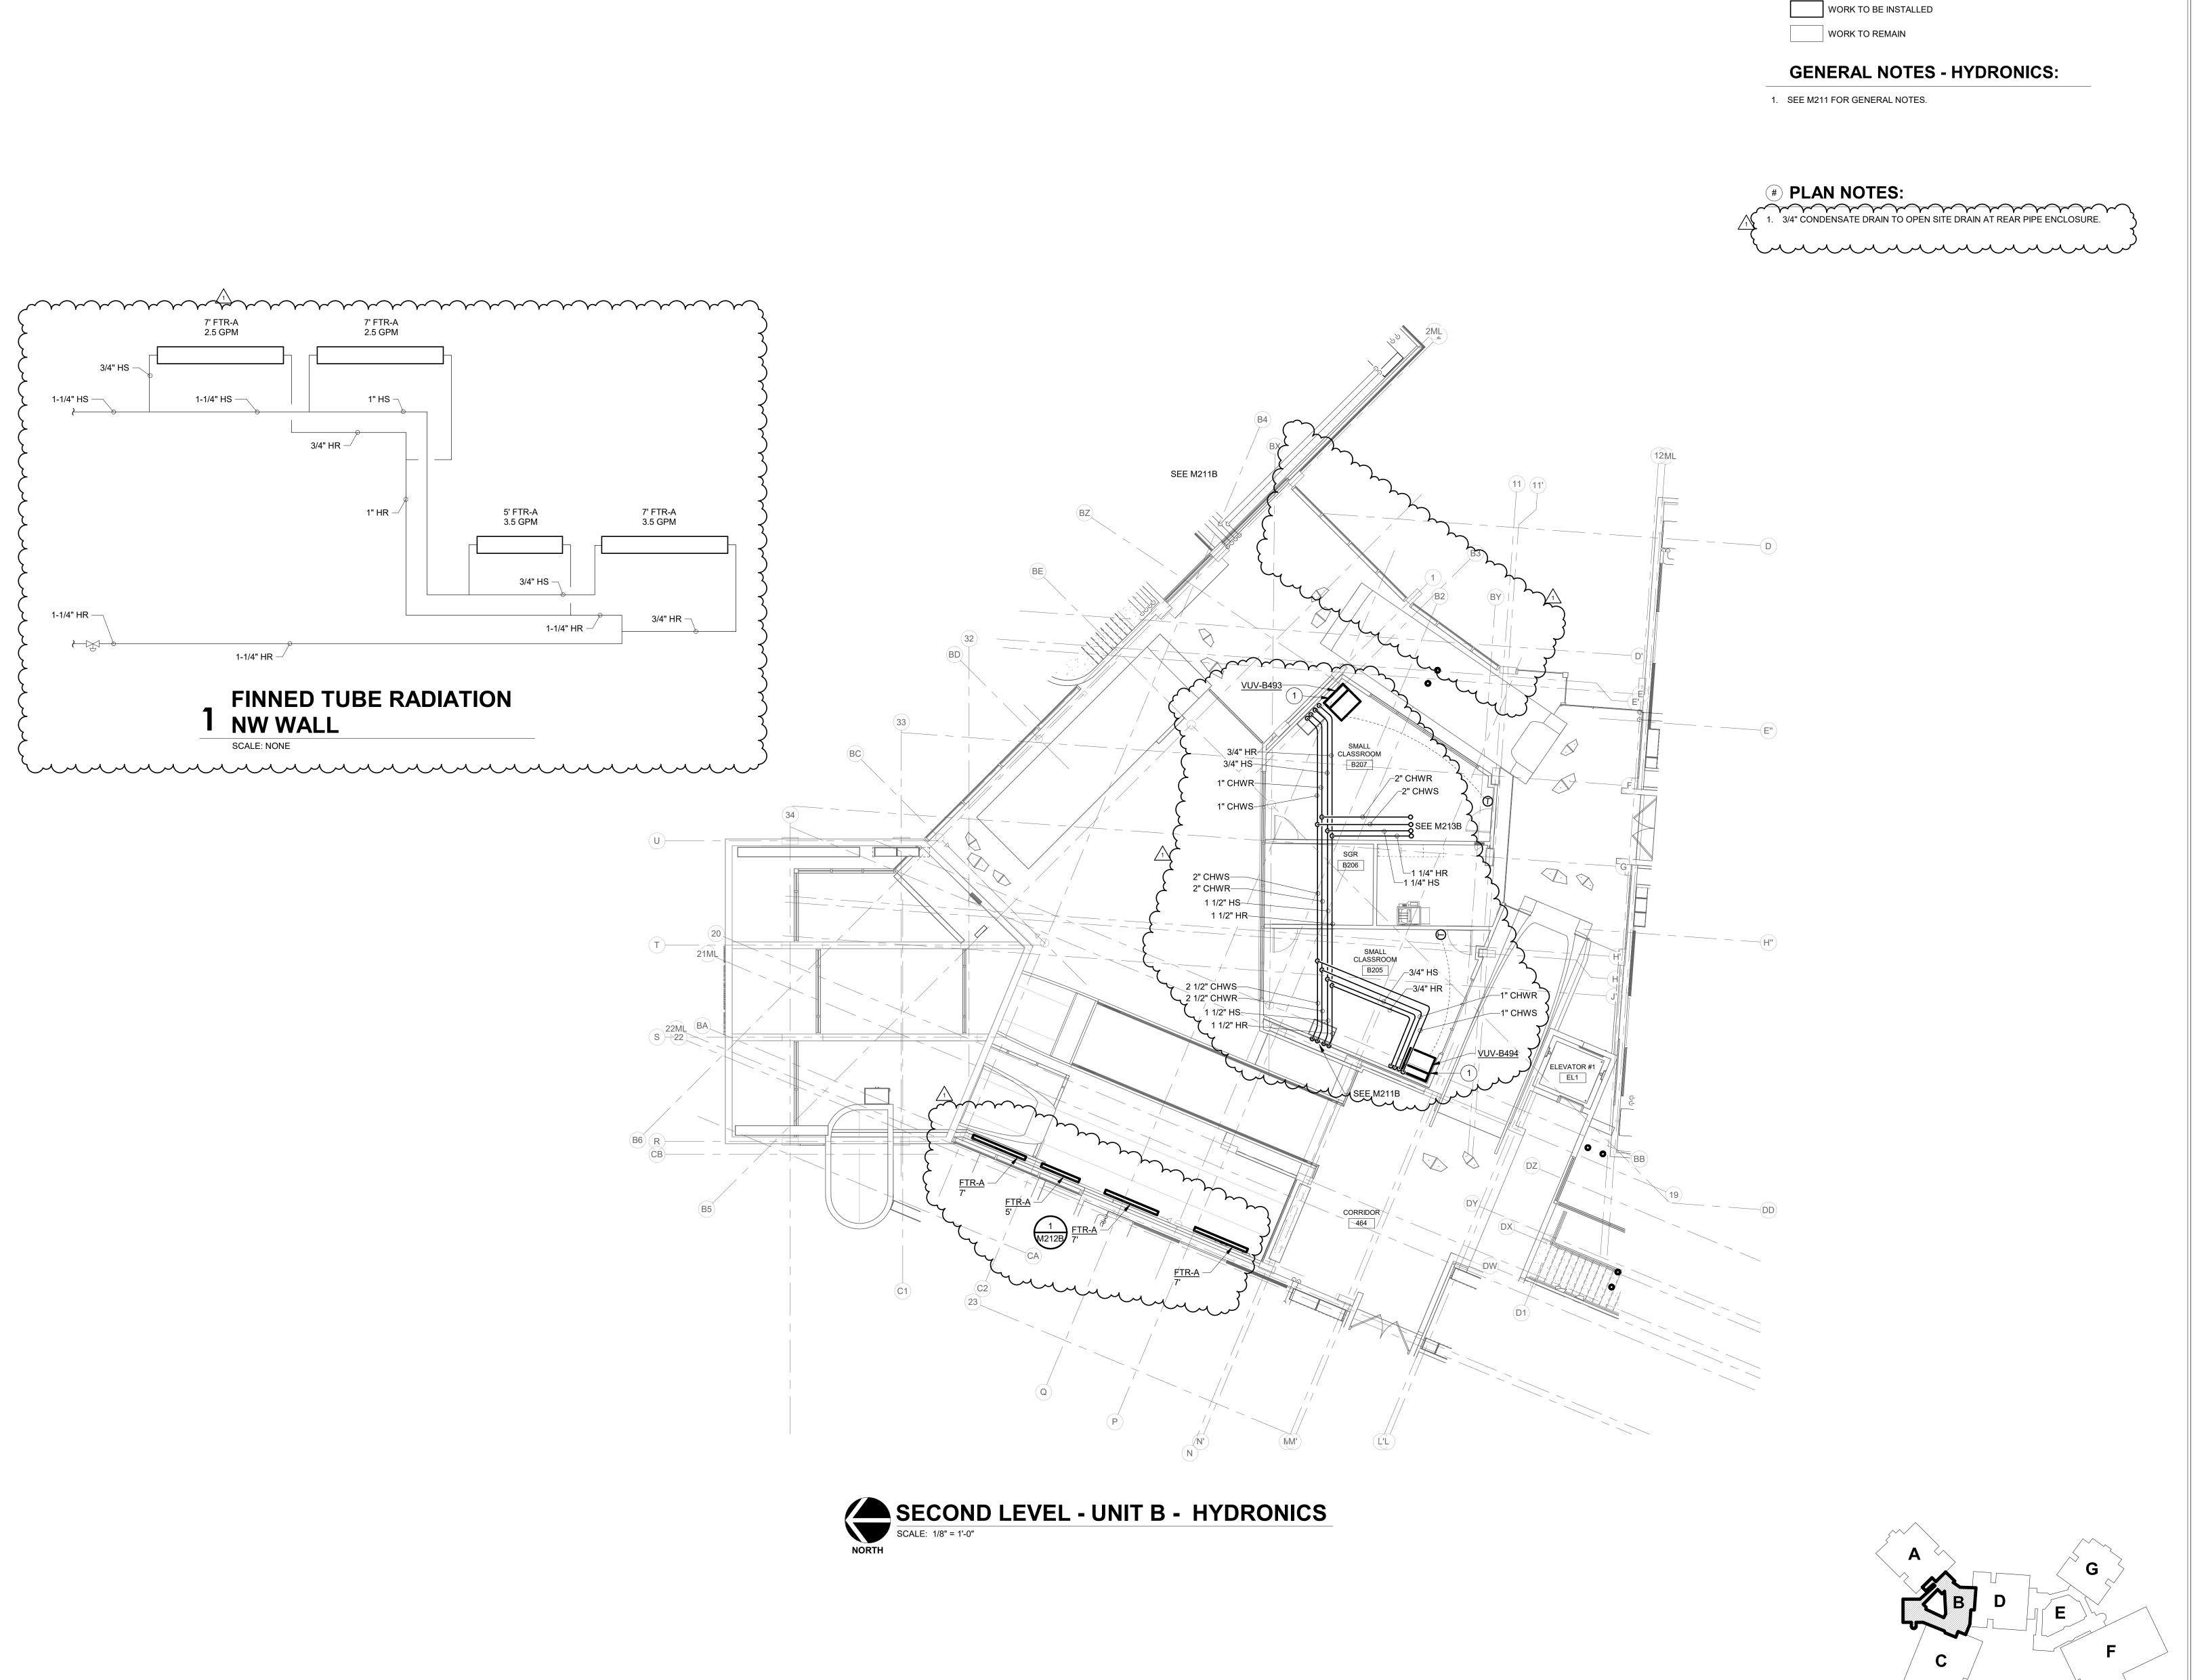



ssing, Indianapolis, IN 46240

S831 Keystone Crossing, Indianapo

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HOLOMEW CONSOLIDATED
CHOOL CORPORATION
RENOVATIONS TO
VCROSS DRIVE COLLIMBITS IN 47201

SCOPE DRAWINGS:

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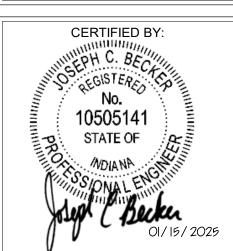
REVISIONS: 1 ADDENDUM #01 01/29/25

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DRAWING TITLE:

SECOND LEVEL - UNIT B -HYDRONICS



DRAWING NUMBER M212B

PROJECT NUMBER 2024023



WORK TO BE INSTALLED

WORK TO REMAIN


GENERAL NOTES - HYDRONICS:


1. SEE M211 FOR GENERAL NOTES.

PLAN NOTES:

1. 1-1/4" CONDENSATE DRAIN PIPING TO FLOOR DRAIN.



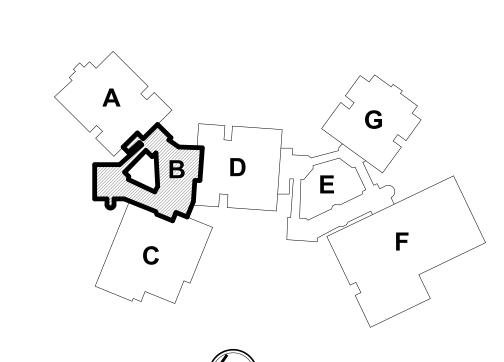

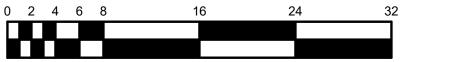





Keystone Crossing, Indianapolis, IN 46240

8831 Keystone 317.8

Consulting Engineers

732 North Capitol Aven Indianapolis, IN 46204 Phone: (317) 634-4672

SCHOOL CORPORATION
SCHOOL CORPORATION
-. FRANCES SMITH ELEMEN
4505 WAYCROSS DRIVE, COLUMBUS, IN

SCOPE DRAWINGS:

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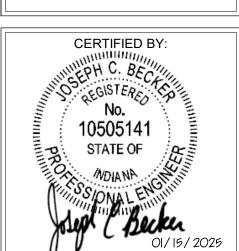
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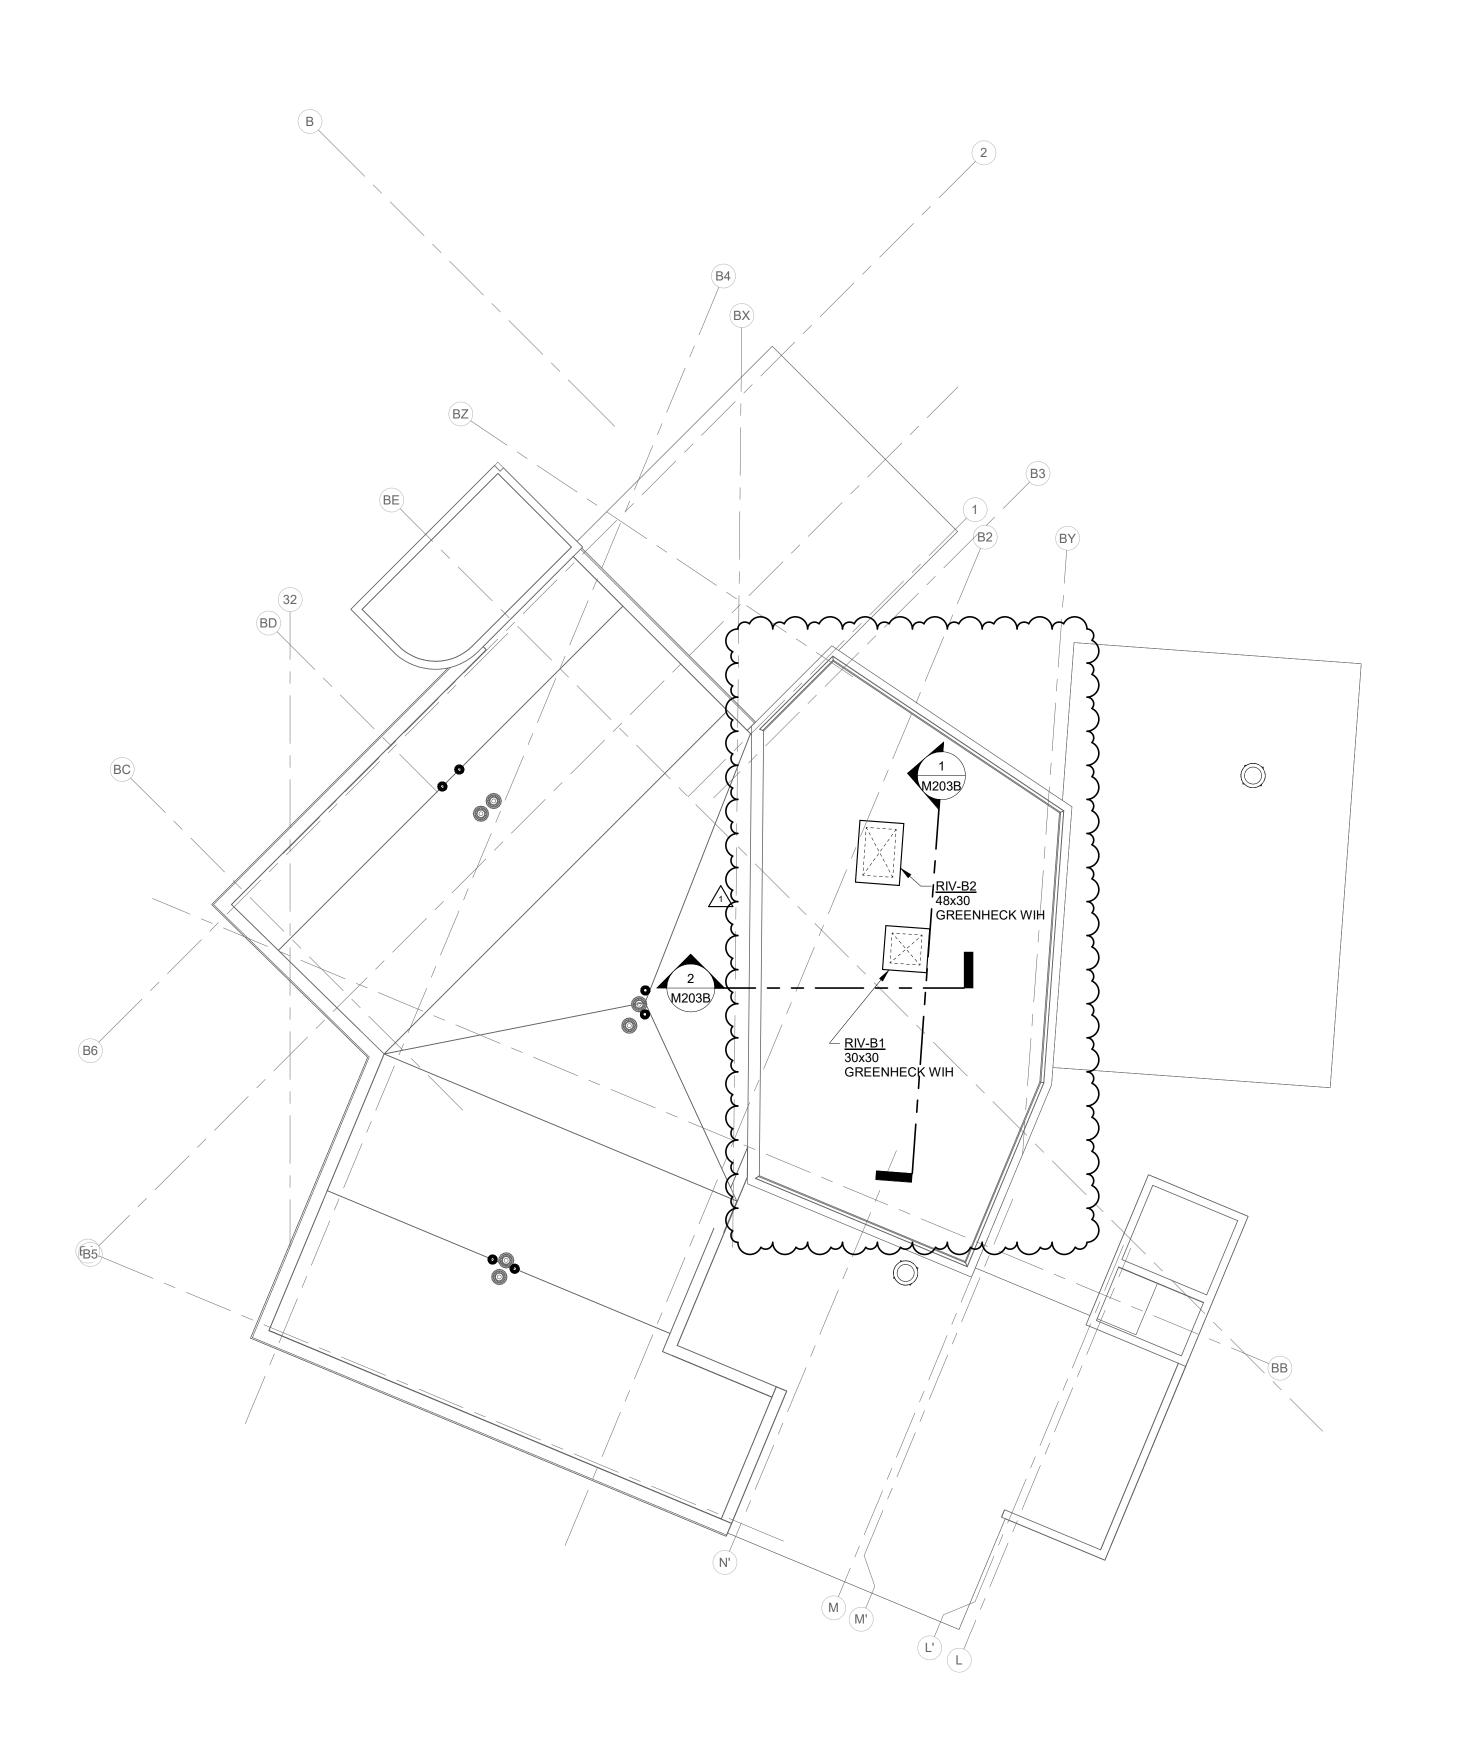
REVISIONS: 1 ADDENDUM #01 01/29/25

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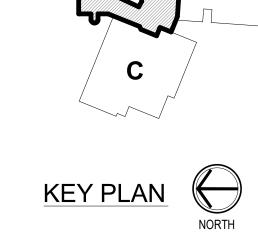
UPPER LEVEL -UNIT B -HYDRONICS



DRAWING NUMBER
M213B









1. SEE SHEET M201 FOR ADDITIONAL GENERAL NOTES.

WORK TO BE INSTALLED

GENERAL NOTES:

WORK TO REMAIN

PLAN NOTES:

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BARTHOLOMEW CONSOLIDATED
SCHOOL CORPORATION
RENOVATIONS TO
L. FRANCES SMITH ELEMENTARY
4505 WAYCROSS DRIVE, COLUMBUS, IN 47201

SCOPE DRAWINGS:

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REVISIONS: 1 ADDENDUM #01 01/29/25


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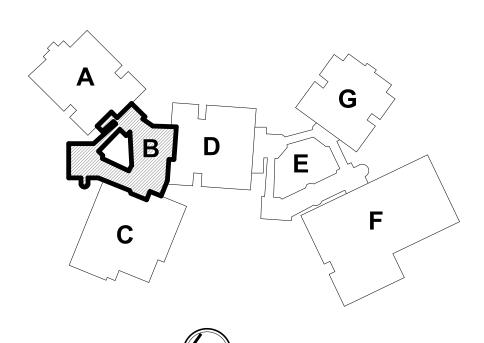
01/15/25 JCB


DRAWING TITLE: ROOF PLAN -UNIT B -MECHANICAL

10505141 STATE OF

DRAWING NUMBER M220B



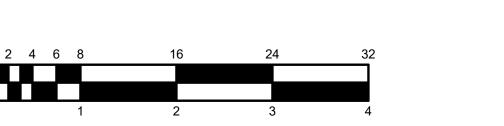

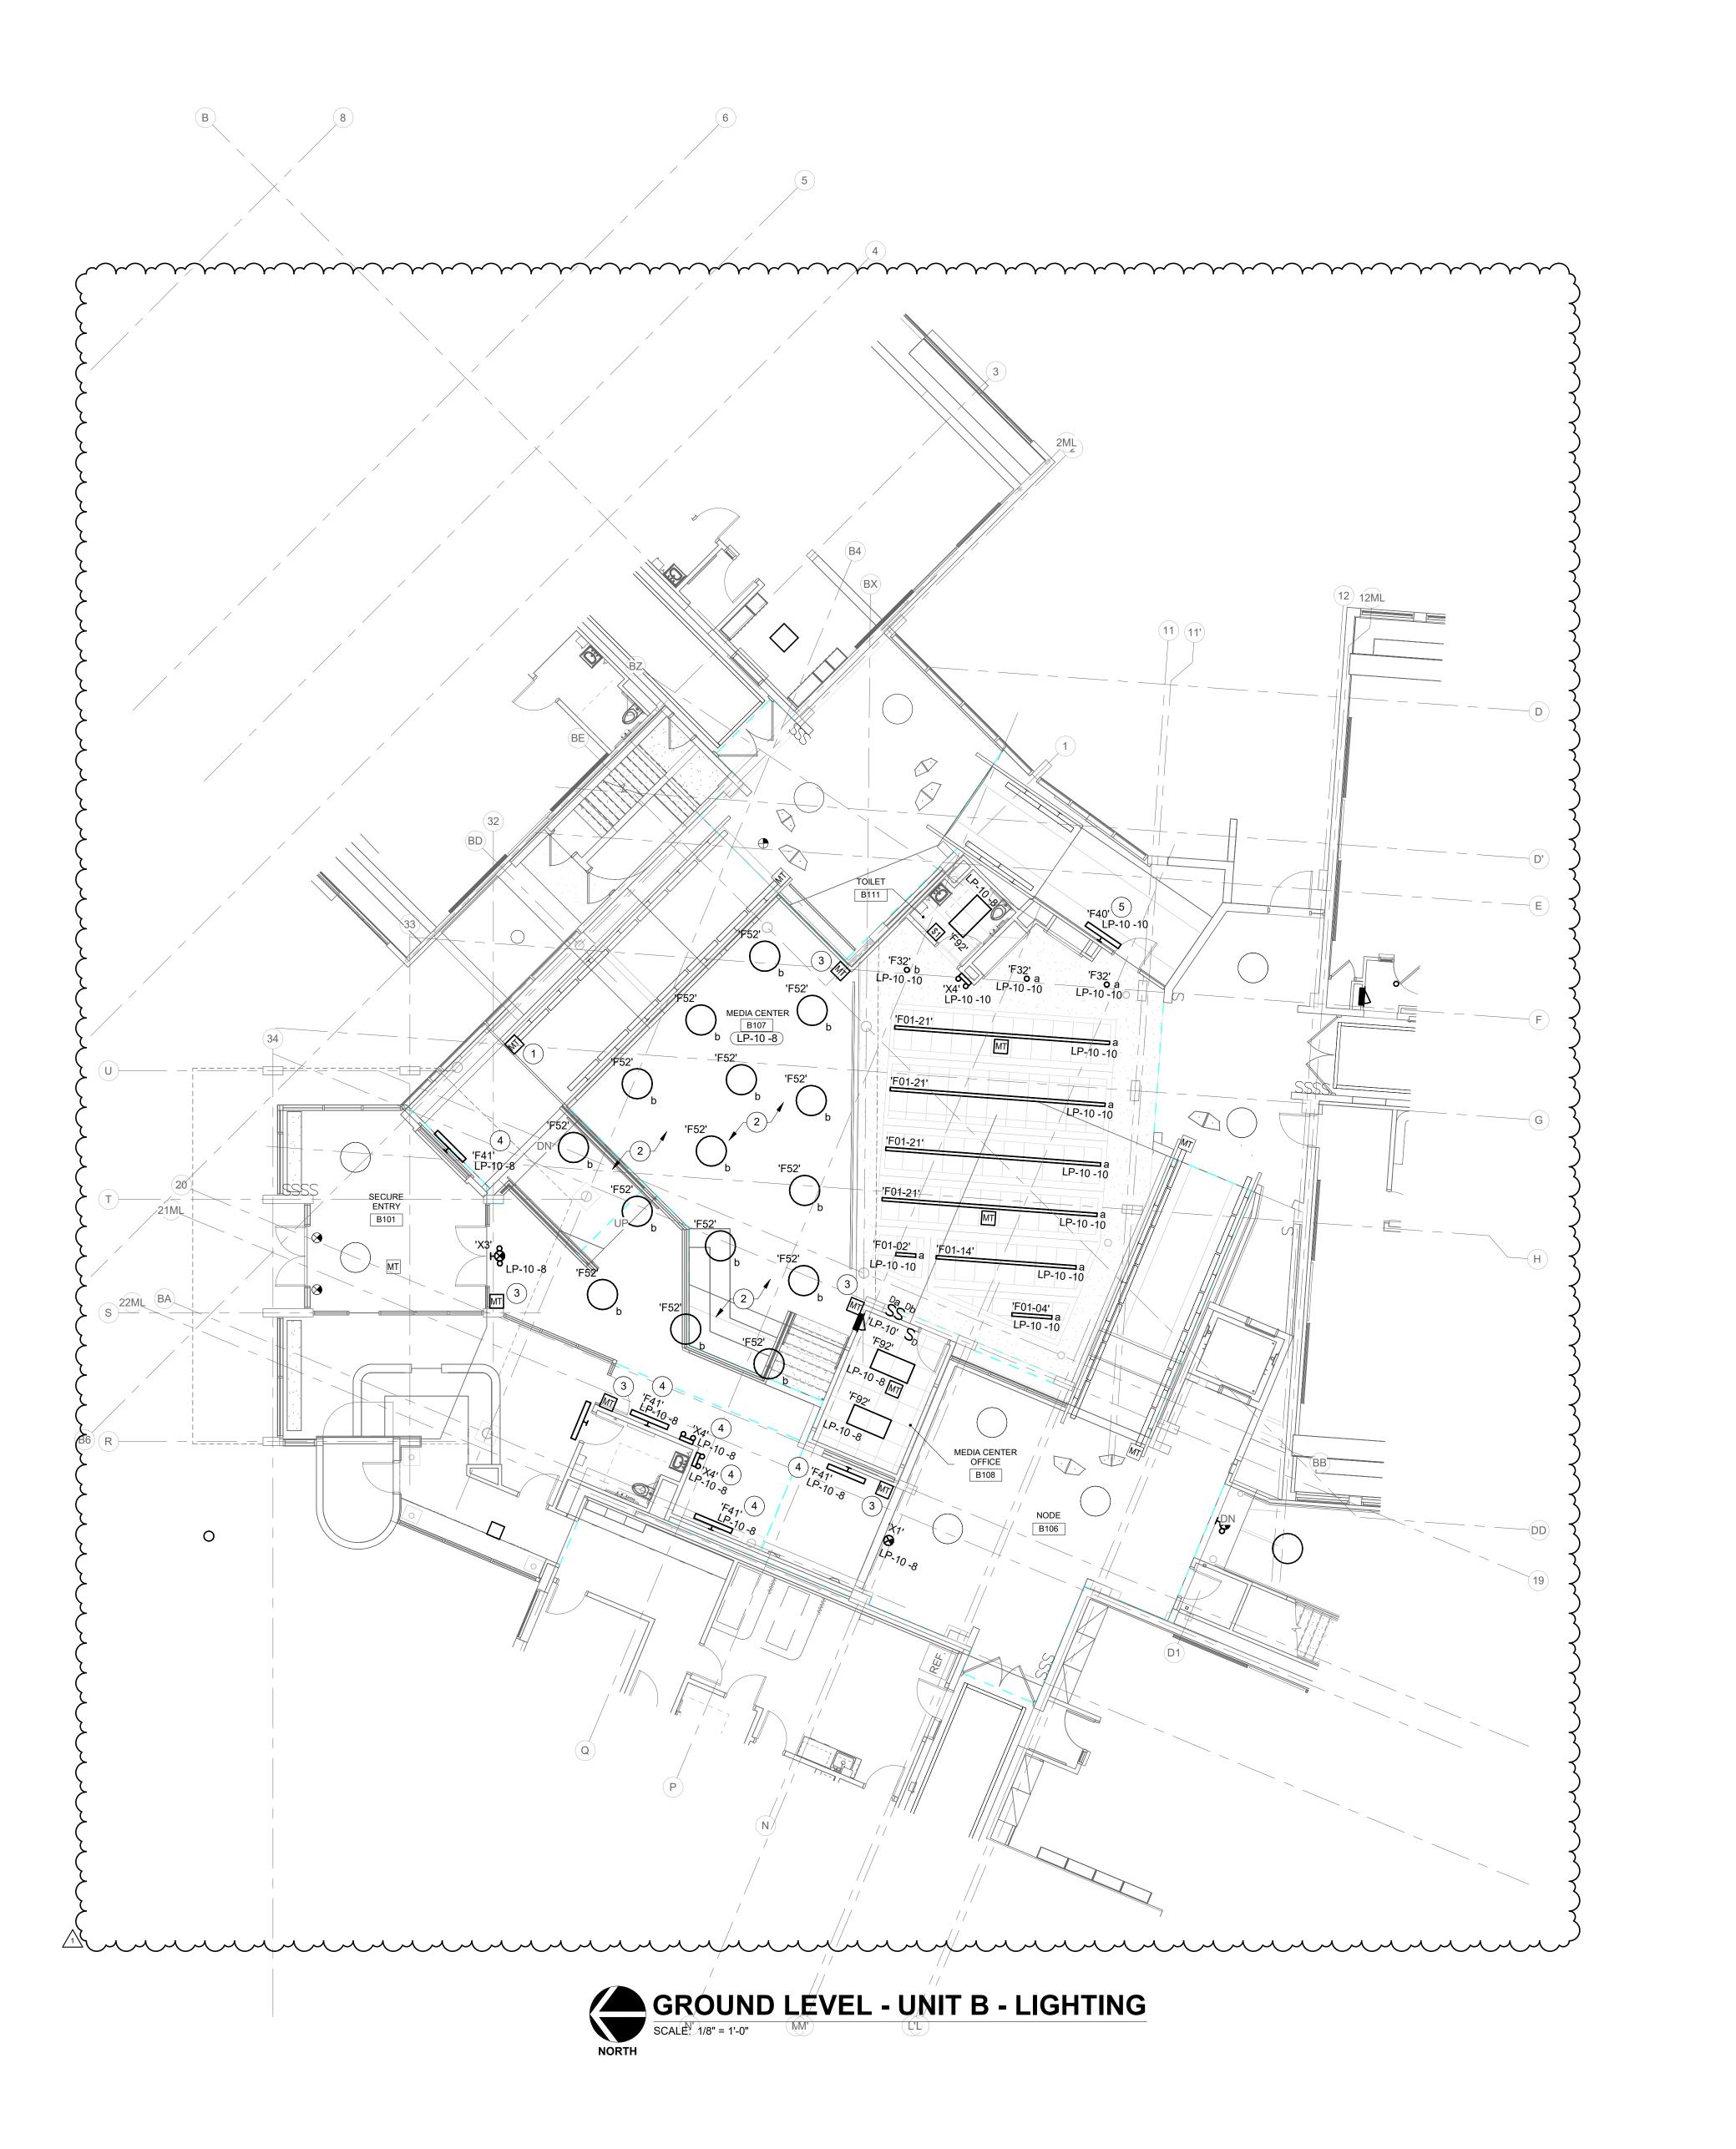

WORK TO BE INSTALLED

WORK TO REMAIN

GENERAL NOTES:

1. SEE E001 FOR GENERAL NOTES.

PLAN NOTES:

1. RECONNECT EXISTING LIGHTING CONTROL DEVICE AND TO REMAINING FIXTURES IN TUNNEL.

2. TYPE 'F52' LIGHT FIXTURES TO BE SUSPENDED 2'-0" BELOW CEILING DECK. DO NOT MOUNT LIGHT FIXTURES BELOW ANY WALK RAMPS. COORDINATE LOCATION WITH OTHER TRADES.

3. PROVIDE WALL MOUNTED OCCUPANCY SENSOR AND MOUNT +8'-6" AFF. MOUNT TO PROVIDE SUFFICIENT COVERAGE IN THE AREA.

LIGHT FIXTURE TO BE MOUNTED +8'-6" AFF. 5. LIGHT FIXTURE TO BE MOUNTED +8'-0" AFF.

munummun.

WBCSC TOGETHER WE LEARN

SCOPE DRAWINGS:

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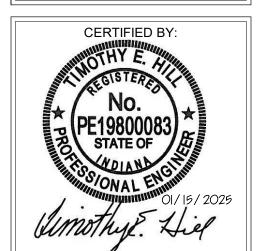
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01/15/25


DRAWING TITLE: GROUND LEVEL

- UNIT B -LIGHTING



E201B

PROJECT NUMBER 2024023

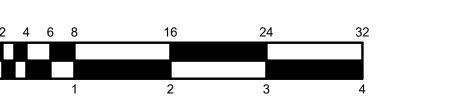





WORK TO BE INSTALLED

WORK TO REMAIN

GENERAL NOTES:


SEE E001 FOR GENERAL NOTES.

 CONNECT LIGHT FIXTURE(S) AT CLASSROOM ENTRY WAYS TO EXISTING CIRCUIT AND CONTROLS IN THE AREA. REWORK AS REQUIRED AND PROVIDE WIRING.

PLAN NOTES:

CONNECT TO EXISTING LIGHTING CIRCUIT IN CORRIDOR AND PROVIDE WIRING.

2. LIGHT FIXTURE TO BE INSTALLED +8'-0" AFF.

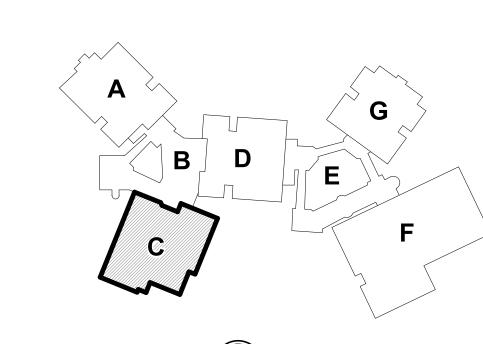







SCOPE DRAWINGS:


These drawings indicate the general scope of the project in terms of architectural design concept, the dimensions of the building, the major architectural elements and the type of structural, mechanical and electrical systems.

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1 ADDENDUM #01 01/29/25

DRAWING TITLE: LIGHTING



E201C

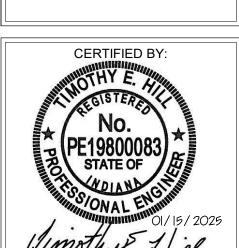GROUND LEVEL - UNIT D - LIGHTING

SCALE: 1/8" = 1'-0"

RENOVATION LEGEND:

WORK TO BE INSTALLED

WORK TO REMAIN

GENERAL NOTES:

SEE E001 FOR GENERAL NOTES.

 CONNECT LIGHT FIXTURE(S) AT CLASSROOM ENTRY WAYS TO EXISTING CIRCUIT AND CONTROLS IN THE AREA. REWORK AS REQUIRED AND PROVIDE WIRING.

PLAN NOTES:

TYPE 'F52' LIGHT FIXTURES TO BE MOUNTED +8'-0" FROM FLOOR AT TOP OF RAMP TO BOTTOM OF LIGHT FIXTURE(S).

2. LIGHT FIXTURES TO BE MOUNTED AT +8'-0" AFF.

WBCSC TOGETHER WE LEARN

SCOPE DRAWINGS:

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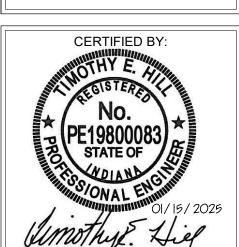
REVISIONS: 1 ADDENDUM #01 01/29/25

ISSUE DATE | DRAWN BY | CHECKED BY

MGE


01/15/25


DRAWING TITLE: GROUND LEVEL - UNIT D -LIGHTING



DRAWING NUMBER E201D

PROJECT NUMBER 2024023

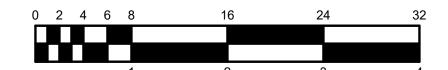

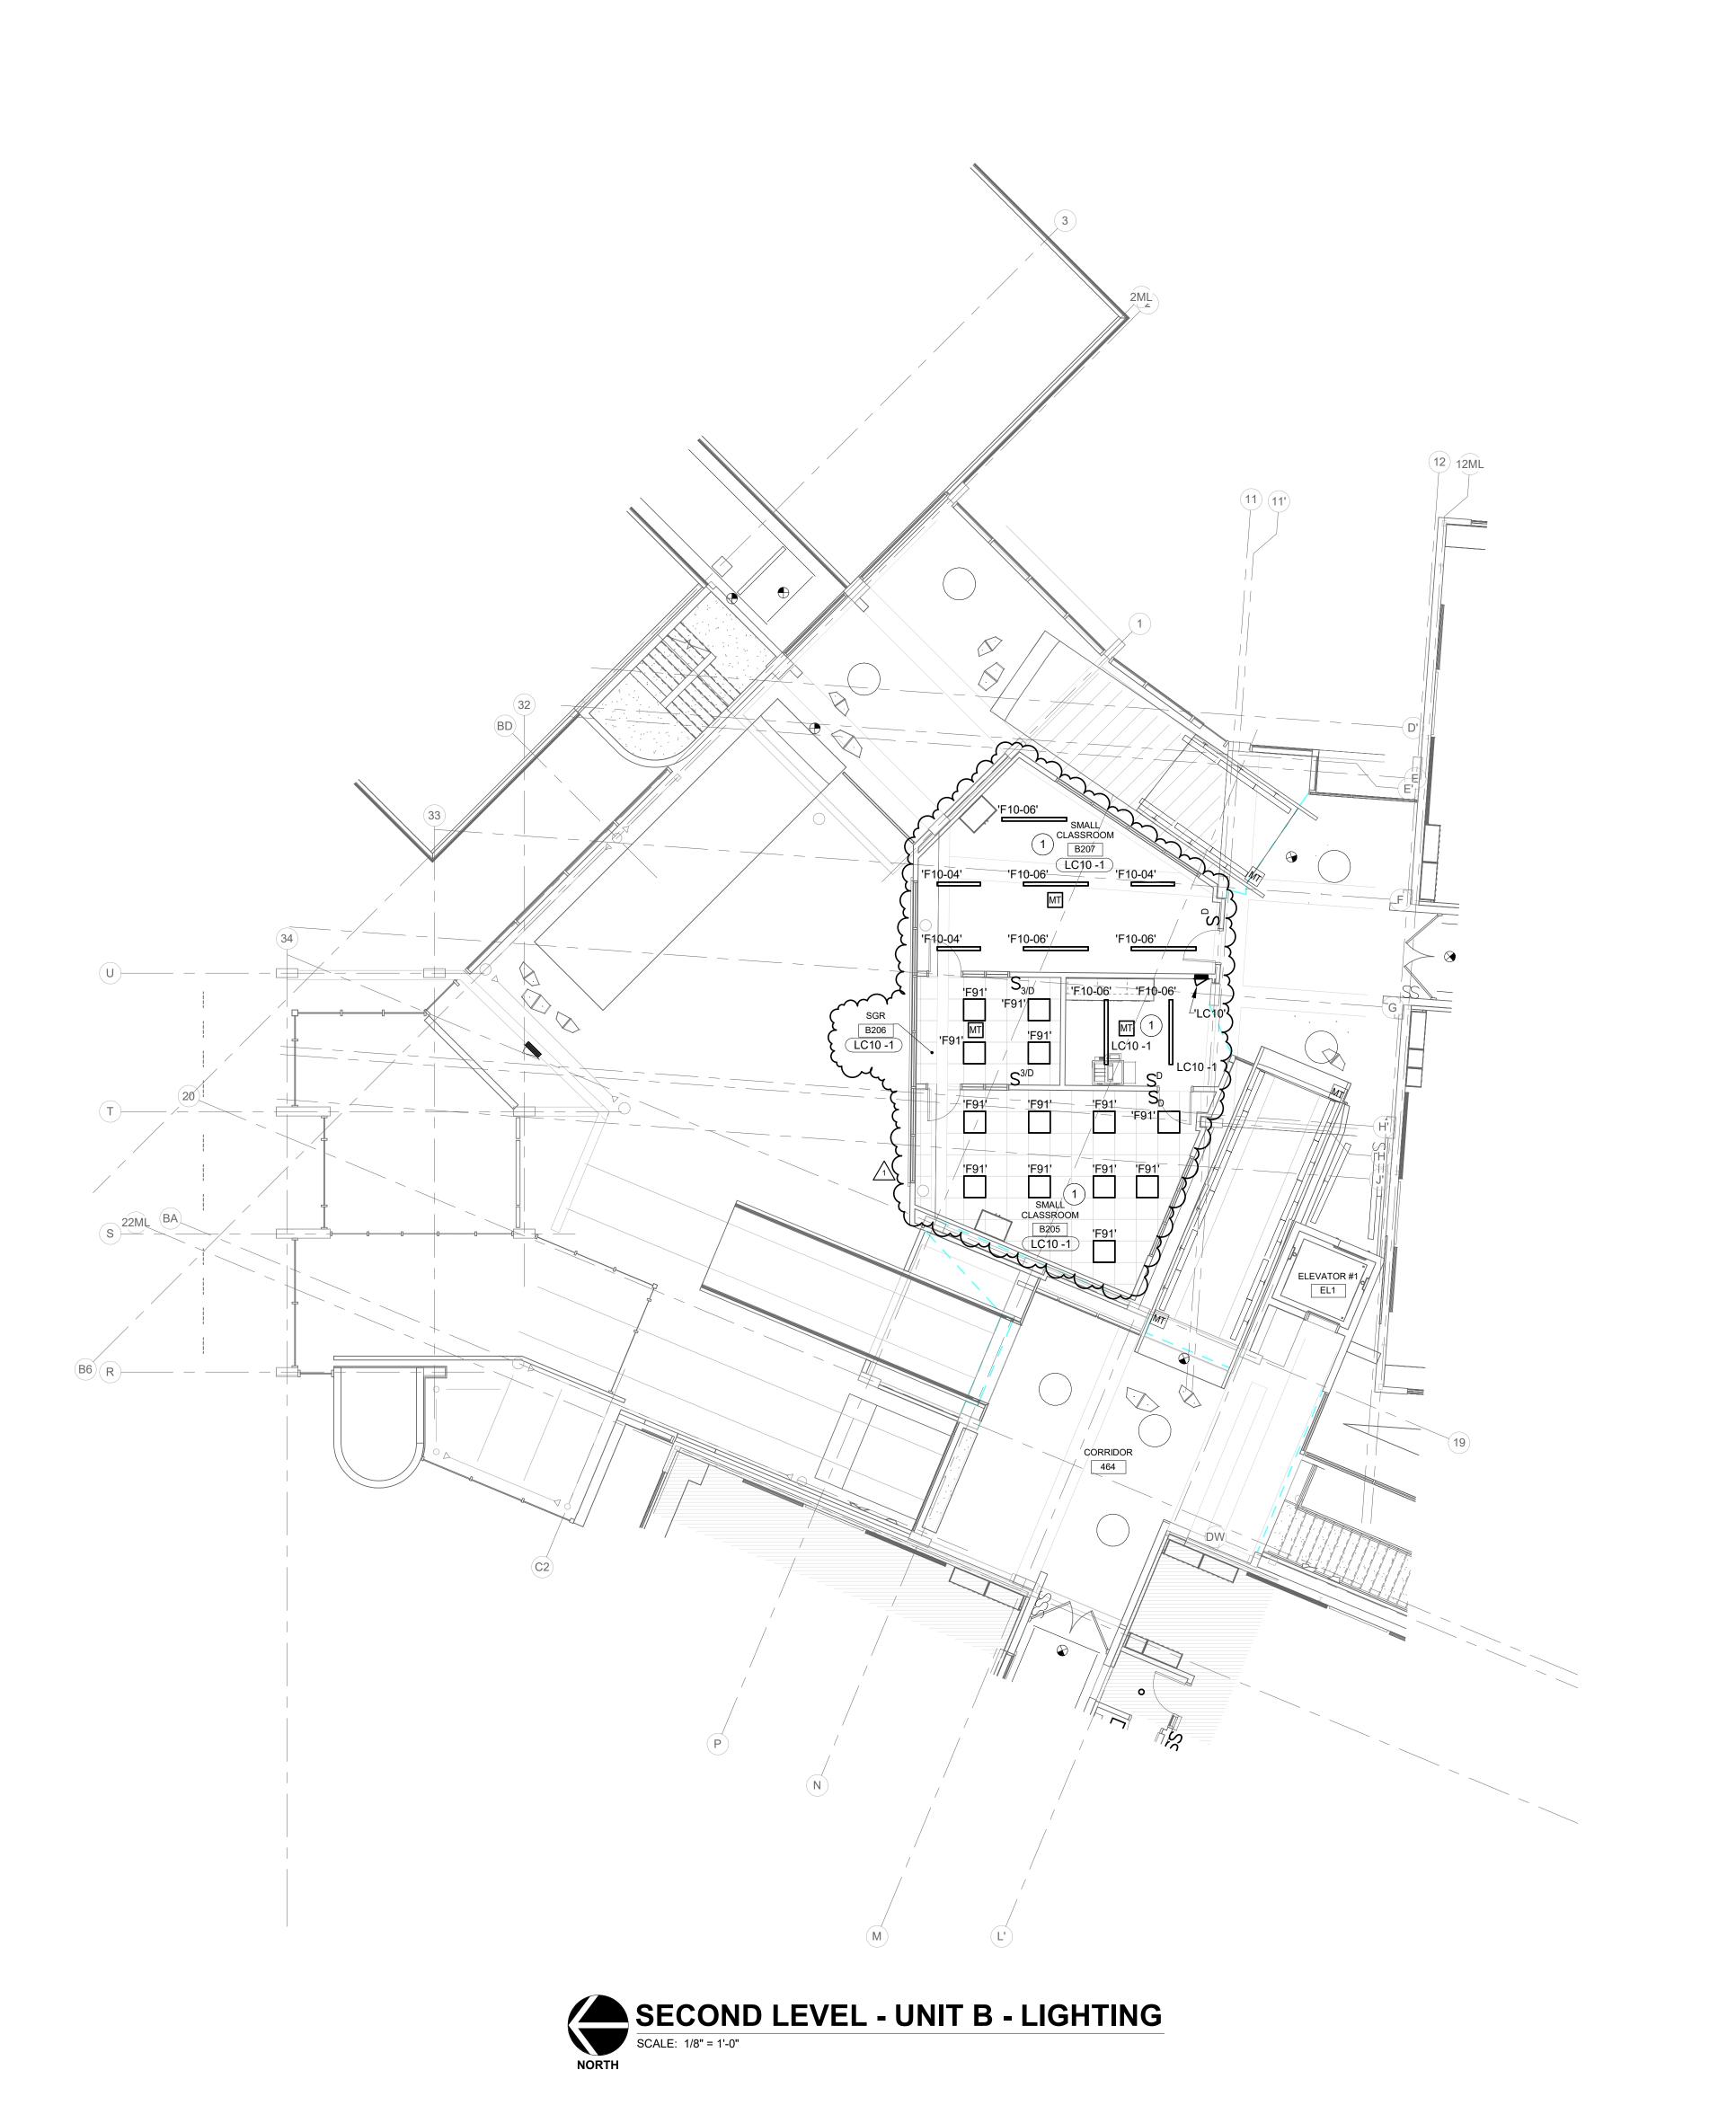



WORK TO BE INSTALLED

WORK TO REMAIN

GENERAL NOTES:

1. SEE E001 FOR GENERAL NOTES.

PLAN NOTES:

1. MOUNT LIGHT FIXTURES IN THIS SPACE AT +9'-0" AFF.

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WBCSC TOGETHER WE LEARN

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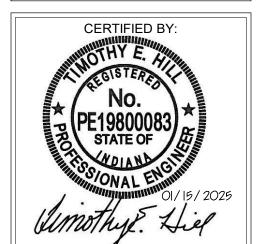
REVISIONS:

1 ADDENDUM #01 01/29/25

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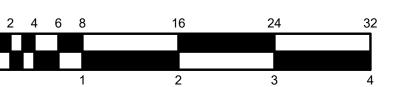
MGE DRAWING TITLE:

LIGHTING




E202B


PROJECT NUMBER 2024023





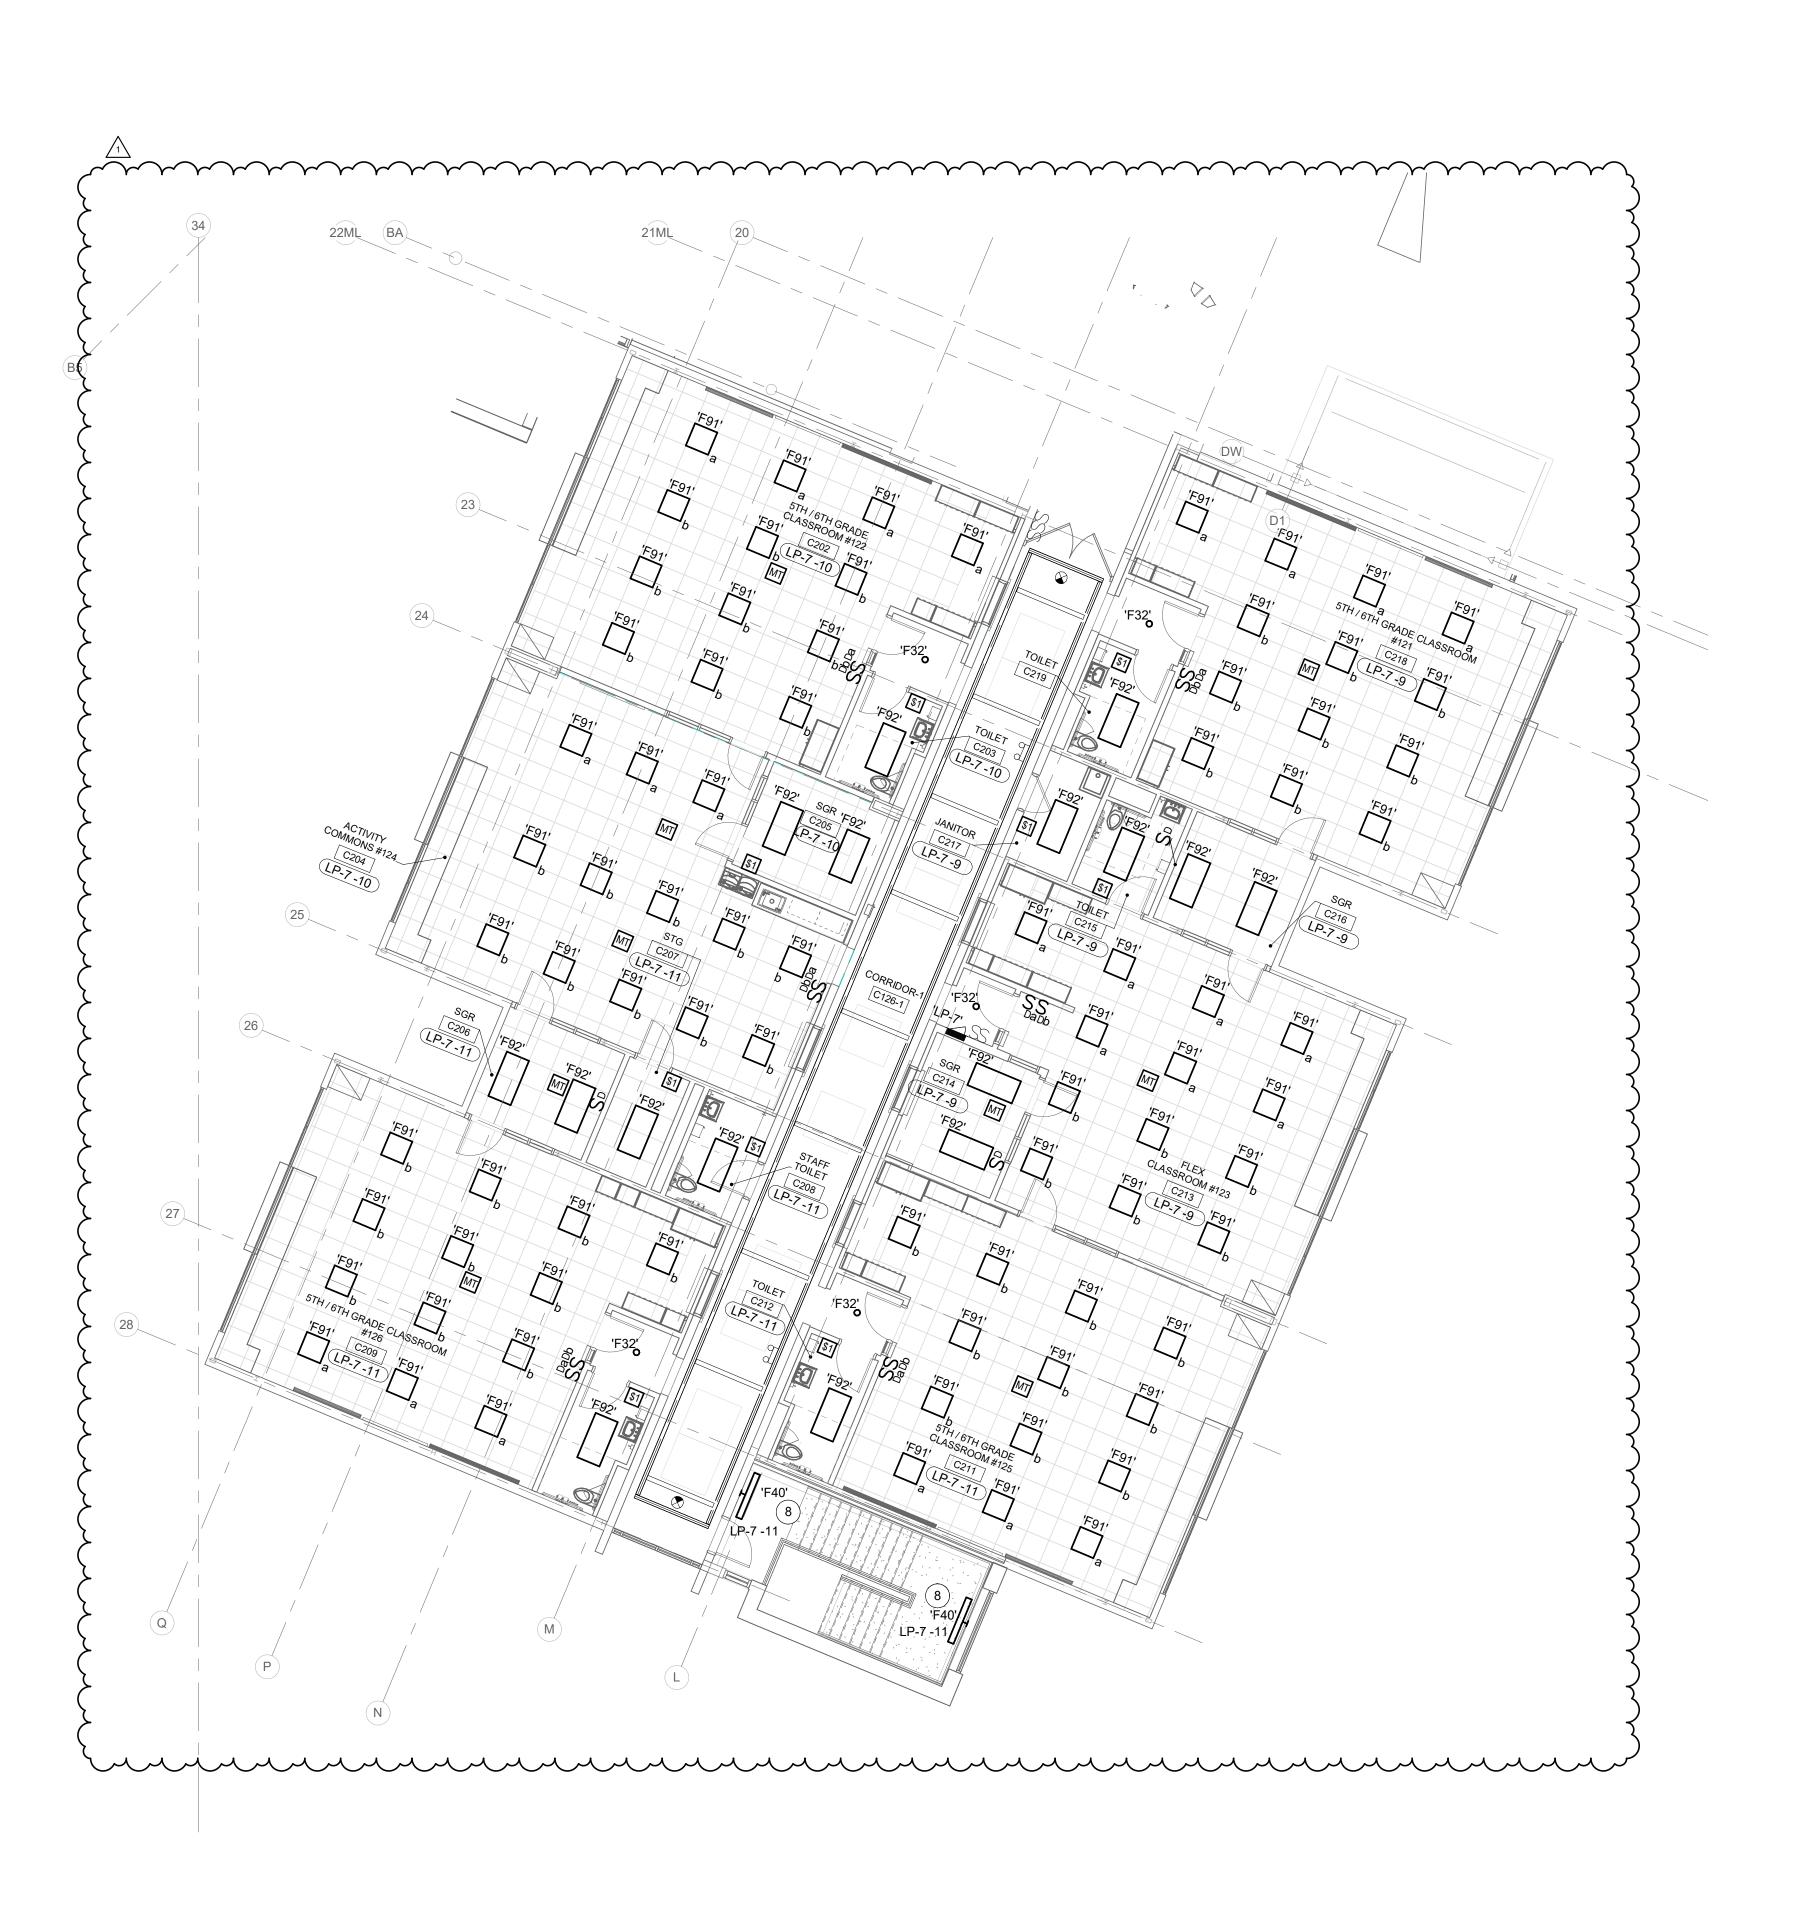



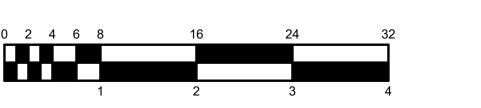

KEY PLAN NORTH



WORK TO BE INSTALLED

WORK TO REMAIN

GENERAL NOTES:

1. SEE E001 FOR GENERAL NOTES. 2. CONNECT LIGHT FIXTURE(S) AT CLASSROOM ENTRY WAYS TO EXISTING CIRCUIT AND CONTROLS IN THE AREA. REWORK AS REQUIRED AND PROVIDE WIRING.

PLAN NOTES:

1. LIGHT FIXTURES TO BE MOUNTED +8'-0" AFF.

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WBCSC TOGETHER WE LEARN

SCOPE DRAWINGS:

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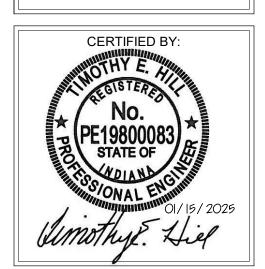
1 ADDENDUM #01 01/29/25

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01/15/25 MGE


DRAWING TITLE: SECOND LEVEL

LIGHTING



E202C



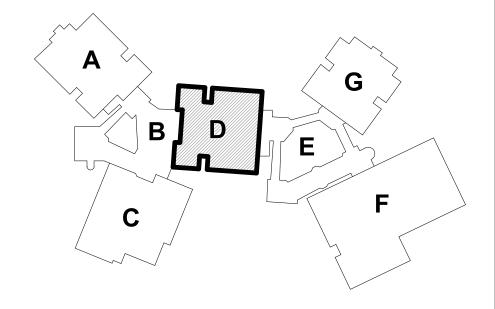







SEE E001 FOR GENERAL NOTES.

 CONNECT LIGHT FIXTURE(S) AT CLASSROOM ENTRY WAYS TO EXISTING CIRCUIT AND CONTROLS IN THE AREA. REWORK AS REQUIRED AND PROVIDE WIRING.

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WORK TO BE INSTALLED

GENERAL NOTES:

WORK TO REMAIN

SCOPE DRAWINGS:

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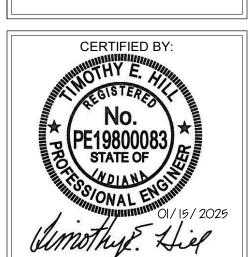
On the basis of the general scope indicated or described, the trade contractors shall furnish all items required for the proper execution and completion of the work.

1 ADDENDUM #01 01/29/25


ISSUE DATE | DRAWN BY | CHECKED BY MGE

01/15/25

DRAWING TITLE: SECOND LEVEL LIGHTING



E202D

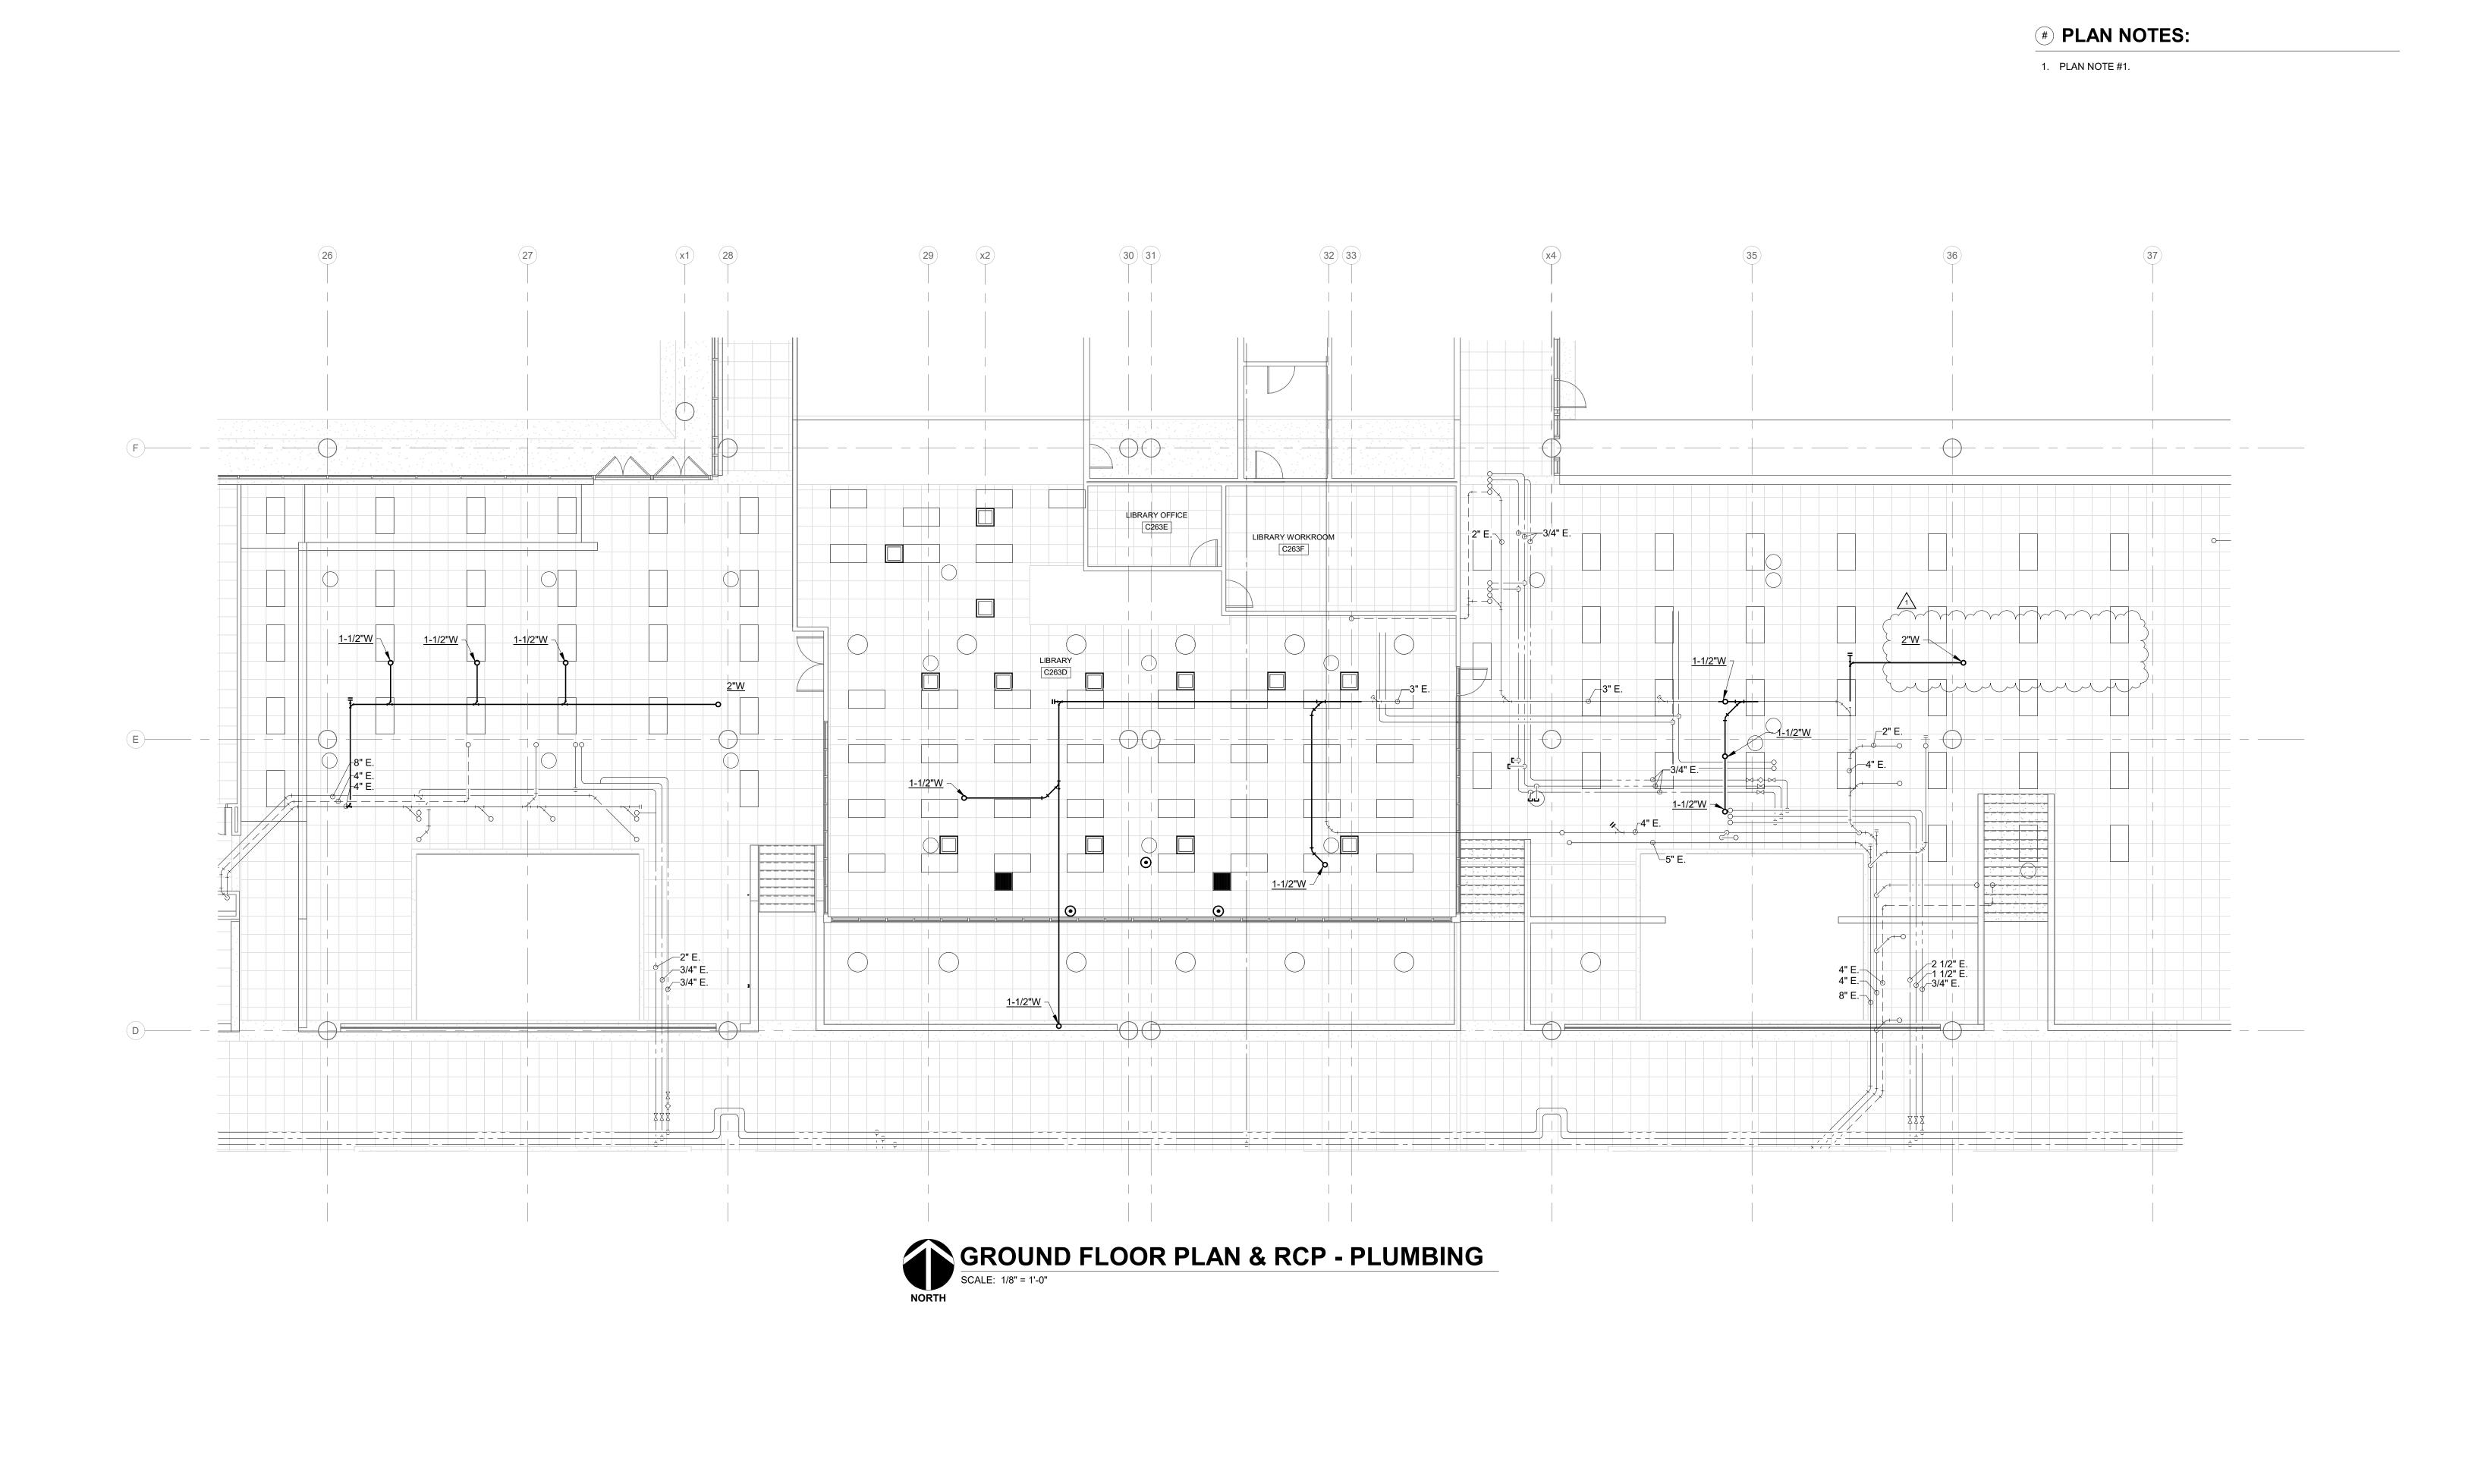



. REFER TO SHEET PM001 FOR ADDITIONAL GENERAL NOTES.

2. COORDINATE WITH MECHANICAL AND ELECTRICAL CONTRACTORS
TO TAKE DOWN / SUSPEND DIFFUSERS, LIGHT FIXTURES, AND OTHER
DEVICES WHERE CEILING IS BEING REMOVED TO COMPLETE WORK.

WORK TO BE INSTALLED

GENERAL NOTES:

WORK TO REMAIN

REINSTALL IN NEW CEILING.

8831 Keystone Crossing, Indianapolis, IN 46240

tes, Inc.

Consulting Engineers
732 North Capitol Avenue
Indianapolis, IN 46204
Phone: (317) 638-8725
Fax: (317) 638-8725

BARTHOLOMEW CONSOLIDATE
SCHOOL CORPORATION
RENOVATIONS TO
230 S Marr Rd. Columbus. IN 47201

SCOPE DRAWINGS:

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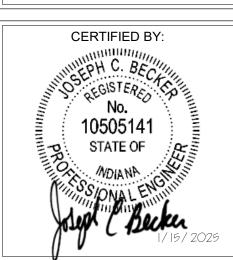
On the basis of the general scope indicated or described, the trade contractors shall furnish all items required for the proper execution and completion of the work.

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Addendum 01 01/29/25

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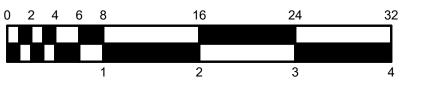
ISSUE DATE DRAWN BY CHECKED BY
01/15/25 GC JCB


GROUND FLOOR
PLAN AND RCP PLUMBING



P200.2

KEY PLAN



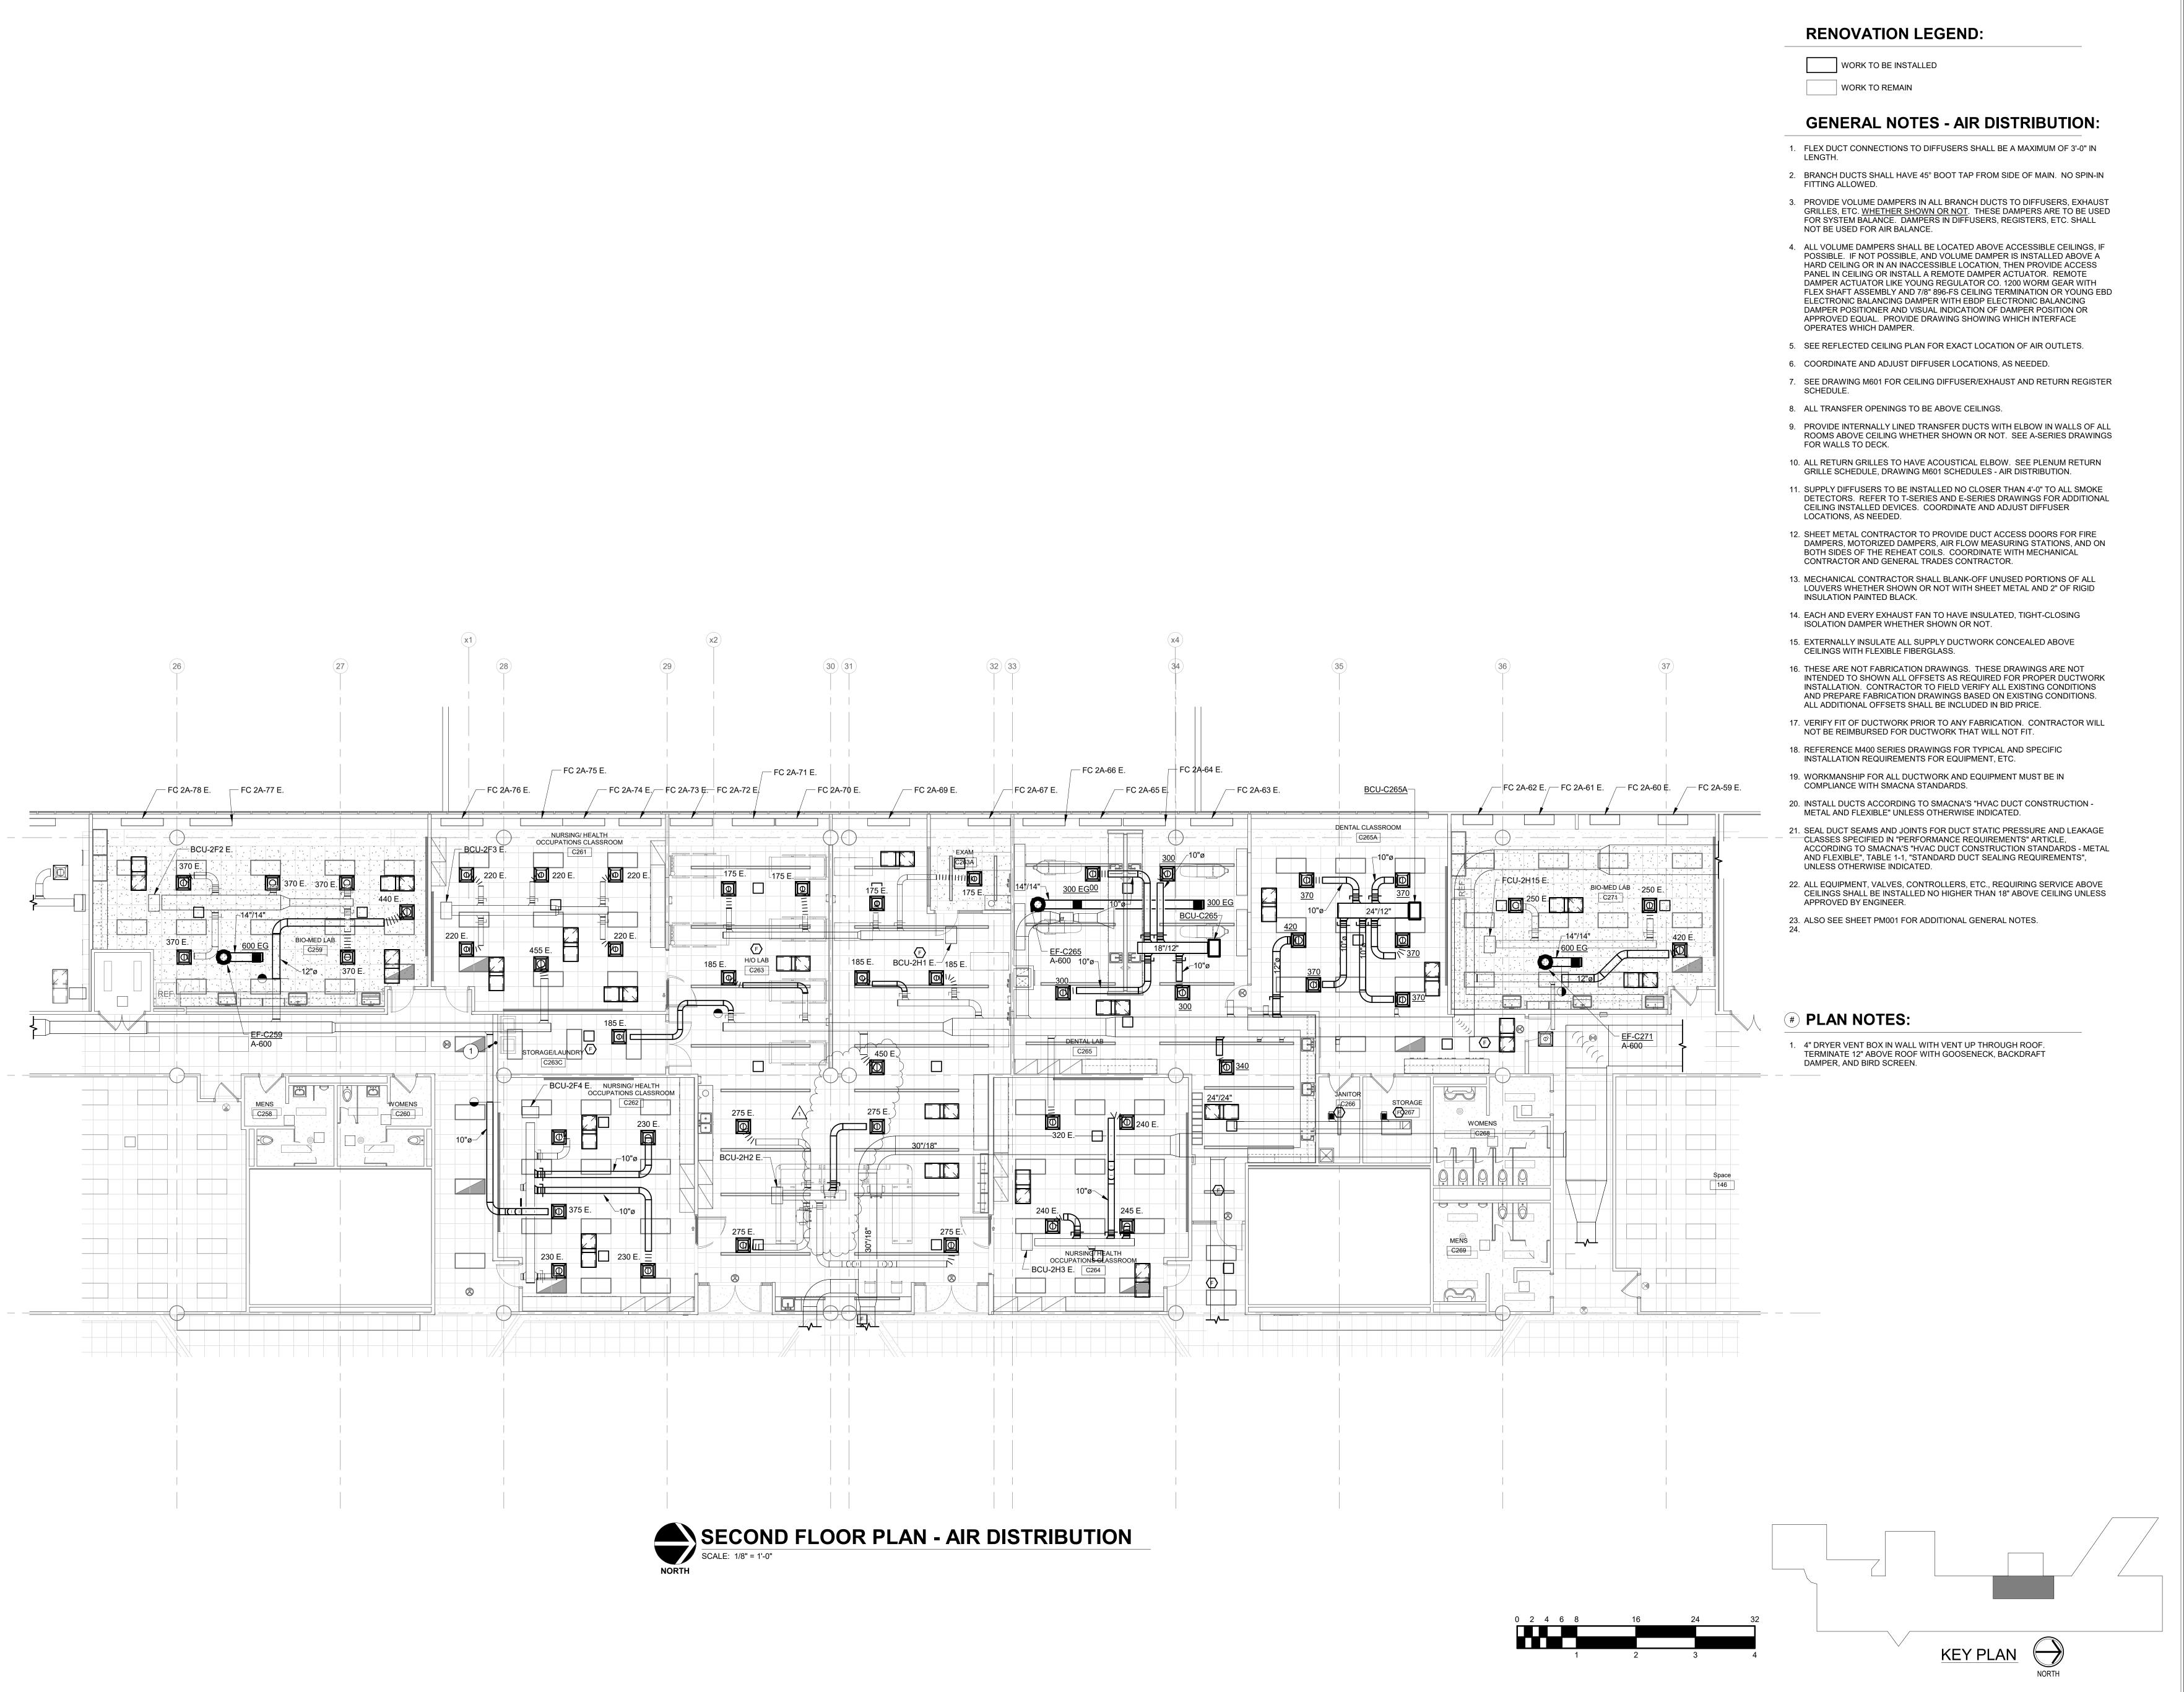



Keystone Crossing, Indianapolis, IN 46240 317.848.7800 | csoinc.net

Δ Θ δ

Consulting Engineers
32 North Capitol Avenue
ndianapolis, IN 46204

SCHOOL CORPORATION
RENOVATIONS TO
230 S Marr Rd, Columbus, IN 47201

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REVISIONS:
Addendum 01 01/29/25

ISSUE DATE | DRAWN BY | CHECKED BY

JCB

01/15/25

SECOND FLOOR
PLAN - AIR
DISTRIBUTION

CERTIFIED BY:

OF THE OF

DRAWING NUMBER
M201



WORK TO BE INSTALLED

WORK TO REMAIN


GENERAL NOTES:

1. SEE E-001 FOR GENERAL NOTES.

PLAN NOTES:

- RELOCATED EXISTING LIGHT FIXTURE(S). CONNECT TO EXISTING CIRCUIT AND EXTEND WIRING AND CONTROLS REMOVED DURING DEMOLITION. REWORK AS REQUIRED AND PROVIDE WIRING.
- 2. USE EXISTING CIRCUIT(S) AND WIRING IN THIS AREA TO POWER LIGHTING. CONNECT EXISTING EMERGENCY POWER TO FEED EMERGENCY FIXTURES AND EXIT SIGNS. PROVIDE WIRING FOR REWORK AND EXTEND EXISTING WIRING AS REQUIRED.



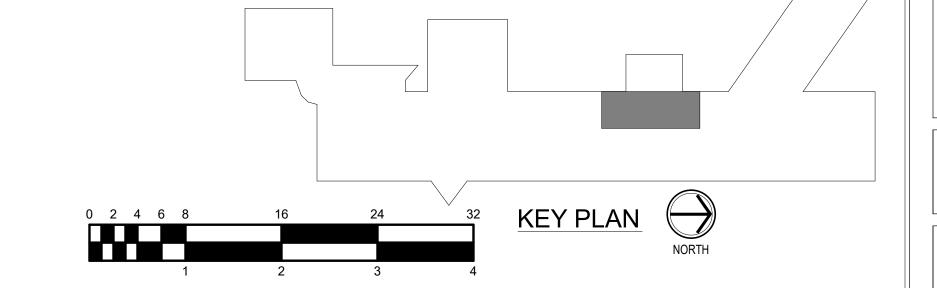



ossing, Indianapolis, IN 46240

8831 Keystone Cro

and Associates, Inc.
Consulting Engineers

BARTHOLOMEW CONSOLIDATED
SCHOOL CORPORATION
RENOVATIONS TO
LUMBUS EAST HIGH SCHOOL

SCOPE DRAWINGS:

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REVISIONS: 1 Addendum 01 01/29/25

ISSUE DATE DRAWN BY CHECKED BY
01/15/25 MGE GSR

DRAWING TITLE:
SECOND FLOOR
PLAN -

PLAN -LIGHTING



E202