

# ADDENDUM

Addendum No: 001

Bid Package No: 1 – Civil and Sitework

Project: Citywalk on the Nickel Plate

Project No: 22024

Date: March 12, 2024

By: Dan Moriarity

This Addendum is issued in accordance with the provisions of “The General Conditions of the Contract for Construction,” Article 1, “Contract Documents” and becomes a part of the Contract Documents as provided therein. This Addendum includes:

Addendum Pages: ADD 001-1 thru ADD 001-2

Specification Sections: 001113 – Advertisement for bids  
003113 - Preliminary Schedules  
011000 - Summary  
0044126 – Bid Form

Drawings: Revised drawings are listed below.

## PART ONE – BIDDING AND CONTRACT DOCUMENTS

### 1.01 List of Drawings Revised

C000 TITLE SHEET.pdf  
C100 DEMOLITION PLAN.pdf  
C101 WATER MAIN DEMOLITION PLAN.pdf  
C200 OVERALL SITE PLAN.pdf  
C201 SITE PLAN.pdf  
C204 WATER MAIN SITE PLAN.pdf  
C400 OVERALL DRAINAGE PLAN.pdf  
C401 DRAINAGE PLAN.pdf  
C402 DRAINAGE PLAN.pdf  
C403 DRAINAGE PLAN.pdf  
C500 OVERALL UTILITY PLAN.pdf  
C501 UTILITY PLAN.pdf  
C502 UTILITY PLAN.pdf  
C505 WATER MAIN EXTENSION PLAN AND PROFILE.pdf  
C802 SITE DETAILS.pdf  
C805 WATER DETAILS.pdf

- 1.02 List of General changes to the drawings: - All changes are marked by clouds on each sheet
- 1.02.1 Since the owner has completed demolition of the houses on site, the demolition plan has been revised to show those items and materials that remain to be removed.
- 1.02.2 The water main routing has been changed to cross Lantern farther north and continue south on the east side of Lantern Road rather than the west.
- 1.02.3 The drainage near the swimming pool has been adjusted to anticipate the future pool design.

## **PART TWO – SPECIFICATIONS**

1. The link to the drawings and specs is [https://distribution.easternengineering.com/View/ViewJobList.aspx?group\\_id=private\\_all](https://distribution.easternengineering.com/View/ViewJobList.aspx?group_id=private_all). This is the “private” side of the Eastern Engineering Plan Room. The password is all lower case “citywalk”.
2. The owners have extended the bid date until the 27<sup>th</sup> of March at 2:00 PM.
3. The current bid set asks for a complete bid for the civil portion of the project. If you wish, you can submit a number for only those categories that for which you have expertise.
4. The owners have also relaxed the date to start construction. Please include in your bid when you can start work if you are selected.

# CITY WALK ON THE NICKEL PLATE TRAIL

## LANTERN ROAD AND CIRCLE DRIVE FISHERS, HAMILTON COUNTY, INDIANA 46038 FEBRUARY 23rd, 2024

### PROJECT TEAM:

**OWNER**  
CITY WALK DEVELOPMENT LLC  
PH: (317) 979-9797  
CONTACT: HOSSAM WANAS  
EMAIL: wanas@citywalkfishers.com

**DEVELOPER**  
WANAS GROUP LLC  
PH: (317) 979-9797  
CONTACT: HOSSAM WANAS  
EMAIL: wanas@citywalkfishers.com

**ARCHITECT**  
STUDIO M ARCHITECTURE  
275 VETERANS WAY  
CARMEL, IN 46033  
PH: (317) 810-1502  
CONTACT: DAN MORIARITY  
EMAIL: dmoriarity@studiomarchitecture.net

**SURVEYOR**  
CIVIL & ENVIRONMENTAL  
CONSULTANTS, INC.  
530 E. OHIO ST., STE. G  
INDIANAPOLIS, IN 46204  
PH: (317) 655-7777  
CONTACT: ANTHONY SYERS  
EMAIL: asyers@cecinc.com

**CONSTRUCTION MANAGER**  
CITIBLD, LLC  
PH: (317) 979-9797  
CONTACT: HOSSAM WANAS  
EMAIL: wanas@citywalkfishers.com

**CIVIL ENGINEER**  
CIVIL & ENVIRONMENTAL  
CONSULTANTS, INC.  
530 E. OHIO ST., STE. G  
INDIANAPOLIS, IN 46204  
PH: (317) 655-7777  
CONTACT: AARON HURT  
EMAIL: ahurt@cecinc.com

### LIST OF CONTACTS:

**SANITARY SEWER SERVICE**  
CITY OF FISHERS  
1 MUNICIPAL DR.  
FISHERS, IN 46038  
PHONE: (317) 595-3111  
JASON TAYLOR

**STREETS AND HIGHWAYS**  
CITY OF FISHERS  
1 MUNICIPAL DR.  
FISHERS, IN 46038  
PHONE: (317) 595-3160

**ELECTRIC SERVICE**  
DUKE ENERGY  
100 SOUTH MILLCREEK ROAD  
NOBLESVILLE, IN 46061  
PHONE: (317) 776-5352  
TIM UMBROUGH

**WATER SERVICE**  
CITIZENS ENERGY GROUP  
2150 DR. MARTIN LUTHER KING JR. DR.  
INDIANAPOLIS, IN 46200  
PHONE: (317) 927-4684  
RICH NEWELL

**FIRE DEPARTMENT**  
CITY OF FISHERS  
2 MUNICIPAL DRIVE  
FISHERS, IN 46038  
PHONE: (317) 595-3200  
STEVE URUSA

**GAS SERVICE**  
CENTERPOINT ENERGY  
BOX 1700  
16000 ALLISONVILLE ROAD  
NOBLESVILLE, IN 46060-1700  
PHONE: (317) 776-5534  
BRIAN HARGER

**BRIGHTHOUSE NETWORKS**  
3030 ROOSEVELT AVE.  
FISHERS, IN 46218  
PHONE: (765) 632-9077

**TELEPHONE SERVICE**  
AT&T  
240 N. MERIDIAN ST., ROOM 1791  
INDIANAPOLIS, IN 46204  
PHONE: (317) 265-3050  
MATT SPINDLER

**CABLE SERVICE**  
COMCAST  
950 E. 10TH ST., SUITE 1600  
NOBLESVILLE, IN 46060  
PHONE: (765) 646-9113  
DALE LAMBERT

### BENCHMARKS:

UNLESS OTHERWISE NOTED, ELEVATIONS SHOWN HEREON ARE BASED UPON AN OPUS SOLUTION AND ARE ON THE 1985 NORTH AMERICAN VERTICAL DATUM (NAVD85). IT IS MY OPINION THAT THE UNCERTAINTY IN THE ELEVATION OF THE PROJECT BENCHMARK DOES NOT EXCEED 0.10 FOOT.

TBM#1: CUT "X" ON THE NORTH BONNET BOLT OF A HYDRANT LOCATED ON THE SOUTH SIDE OF TECHNOLOGY DRIVE APPROXIMATELY 330 FEET EAST OF THE NICKEL PLATE TRAIL.  
ELEV. = 820.56

TBM#2: CUT "X" ON THE NORTH BOLT OF A PEDESTRIAN CROSSING SIGNAL IN THE NORTH QUADRANT OF THE INTERSECTION OF LANTERN ROAD AND THE NICKEL PLATE TRAIL.  
ELEV. = 824.88

TBM#3: CUT SQUARE ON THE CONCRETE RIM OF A BEEHIVE STORM INLET LOCATED ON THE WEST SIDE OF LANTERN ROAD ACROSS FROM THE NORTHWEST CORNER OF 12002 LANTERN ROAD.  
ELEV. = 811.83

### UTILITY NOTE:

THE UNDERGROUND UTILITIES SHOWN HAVE BEEN LOCATED FROM FIELD SURVEY INFORMATION AND EXISTING DRAWINGS. THE SURVEYOR MAKES NO GUARANTEES THAT THE UNDERGROUND UTILITIES COMPRISE ALL SUCH UTILITIES IN THE AREA EITHER IN-SERVICE OR ABANDONED. THE SURVEYOR FURTHER DOES NOT WARRANT THAT THE UNDERGROUND UTILITIES SHOWN ARE IN THE EXACT LOCATION INDICATED ALTHOUGH THE SURVEYOR DOES CERTIFY THAT THEY ARE LOCATED AS ACCURATELY AS POSSIBLE FROM INFORMATION AVAILABLE. THE SURVEYOR HAS NOT PHYSICALLY LOCATED THE UNDERGROUND UTILITIES. INDIANA 811 ONE-CALL PUBLIC UTILITY LOCATE SERVICE TICKET NUMBERS 2206093294, 2206093523, 2206093581, 2206093662, 2206093677, 2206093702, 2206093728, 2206093742, 2206093759, 2206093775, 2206093800, 2206093817, 2206093828, 2206093839, 2206093851, 2206093909, AND 2206093938 WERE ISSUED FOR THIS SITE.



PRIOR TO ANY EXCAVATION FOR UNDERGROUND UTILITIES, THE CONTRACTOR SHALL EXPOSE AND VERIFY LOCATIONS (HORIZONTAL AND VERTICAL) OF ALL EXISTING UTILITIES INCLUDING BUT NOT LIMITED TO GAS, WATER, AND SANITARY SEWER. ANY CONFLICTS SHALL BE REPORTED IMMEDIATELY TO THE ENGINEER AND THE APPROPRIATE AUTHORITIES.

### FLOOD NOTE:





THE PARCEL DESCRIBED AND SHOWN HEREIN LIES WITHIN ZONE "X" (UN-SHADED) AS SAID PARCEL PLOTS ON MAP NUMBER 18057002340 (DATED NOVEMBER 19, 2014) OF THE FLOOD INSURANCE RATE MAPS FOR THE UNINCORPORATED AREAS AND THE TOWN OF FISHERS, HAMILTON COUNTY, INDIANA. THE ACCURACY OF THIS FLOOD HAZARD STATEMENT IS SUBJECT TO MAP SCALE UNCERTAINTY AND TO ANY OTHER UNCERTAINTY IN LOCATION OR ELEVATION ON THE REFERENCED FLOOD INSURANCE RATE MAP.

### REFERENCES:

- BOUNDARY RETRACEMENT AND TOPOGRAPHIC SURVEY PROVIDED BY CIVIL & ENVIRONMENTAL CONSULTANTS, INC. SURVEY DATED 08/19/2022, PROJECT NO. 323-947. 1" CONTOUR INTERVAL.
- AERIAL IMAGERY SHOWN ON PLANS GENERATED FROM GOOGLE EARTH.
- FISHERS STANDARD CONSTRUCTION DETAILS AMENDED JANUARY 2022. [HTTPS://WWW.FISHERS.IN.US/390/DESIGN-STANDARDS-SPEC](https://www.fishers.in.us/390/DESIGN-STANDARDS-SPEC)
- OFFSITE TOPOGRAPHY AND SURFACE INFORMATION REFERENCED FROM HAMILTON COUNTY GIS DATA PORTAL. [HTTPS://GIS1.HAMILTONCOUNTY.IN.GOV/PORTAL/HOME/](https://gis1.hamiltoncounty.in.gov/portal/home/)
- SEE SHEET C001 FOR GENERAL NOTES AND SHEET SPECIFIC NOTES.
- CONTRACTOR SHALL REFER TO OTHER PLANS WITHIN THIS CONSTRUCTION SET FOR OTHER PERTINENT INFORMATION. IT IS NOT THE ENGINEER'S INTENT THAT ANY SINGLE PLAN SHEET IN THE SET OF DOCUMENTS FULLY DEPICT ALL WORK ASSOCIATED WITH THE PROJECT.

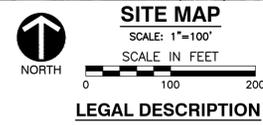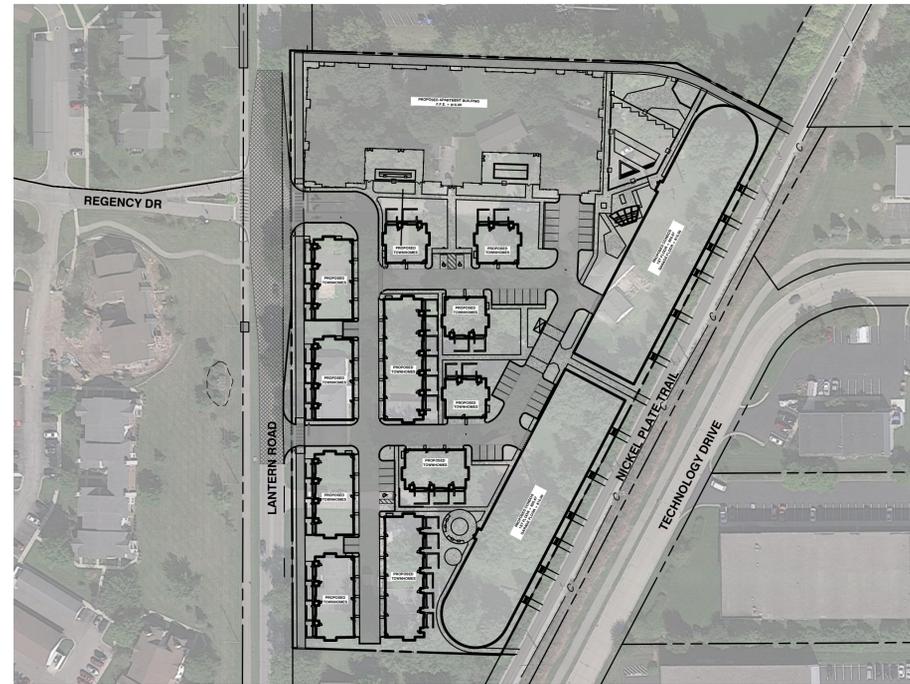

LEGAL DESCRIPTION  
LOTS 1 THROUGH 17 AND THE RIGHT-OF-WAYS OF EAST 121ST STREET AND CIRCLE DRIVE, ALL IN THE PLAT OF CIRCLE HEIGHTS ADDITION, 1ST SECTION AS RECORDED IN PLAT BOOK 2, PAGE 201 IN THE OFFICE OF THE RECORDER OF HAMILTON COUNTY, INDIANA.

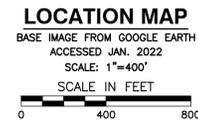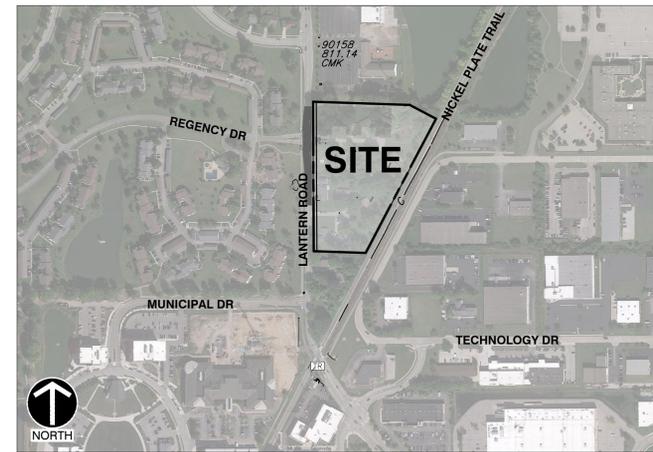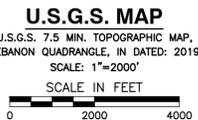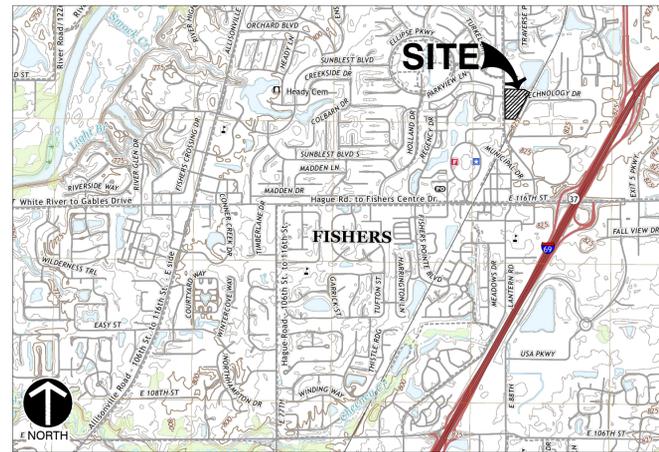

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	TOPOGRAPHIC SURVEY	SV-2
	TOPOGRAPHIC SURVEY	SV-3
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	WATER MAIN DEMOLITION PLAN	C101
	OVERALL SITE PLAN	C200
	SITE PLAN	C201
	SITE PLAN	C202
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67-79	TOWNHOME BUILDINGS - PLANS & ELEVATIONS	TH-A101-THA305
	CITY OF FISHERS STANDARD CONSTRUCTION DETAILS	

### CITY OF FISHERS NOTES:

- THE DESIGN AND CONSTRUCTION SHALL COMPLY WITH THE CURRENT CITY OF FISHERS SPECIFICATIONS AND STANDARD CONSTRUCTION SPECIFICATIONS AND STANDARD CONSTRUCTION DETAILS. THE OMISSION OF ANY CURRENT STANDARD DETAIL DOES NOT RELIEVE THE CONTRACTOR FROM THIS REQUIREMENT.
- DESIGN AND CONSTRUCTION SHALL COMPLY WITH ADA REQUIREMENTS.
- THE CONTRACTOR SHALL SCHEDULE A SITE PRE-CONSTRUCTION MEETING WITH THE CITY OF FISHERS DEPARTMENT OF PUBLIC WORKS PRIOR TO ANY CONSTRUCTION ON THE SITE BEING STARTED.
- THE FINAL SITE INSPECTION WILL NOT BE PERFORMED BY THE CITY OF FISHERS DEPARTMENT OF ENGINEERING INSPECTOR UNTIL ALL SITE AND RIGHT-OF-WAY WORK IS COMPLETED.
- THE DESIGN AND CONSTRUCTION SHALL COMPLY WITH THE CURRENT CITY OF FISHERS SPECIFICATIONS AND STANDARD CONSTRUCTION SPECIFICATIONS AND STANDARD CONSTRUCTION DETAILS. THE OMISSION OF ANY CURRENT STANDARD DETAIL DOES NOT RELIEVE THE CONTRACTOR FROM THIS REQUIREMENT.
- SITE RECORD DRAWINGS ARE REQUIRED TO BE SUBMITTED IN THE FISHERS STANDARD FORMAT PRIOR TO ENGINEERING DET. RELEASE OF THE COMPLETED SITE.
- A CITY OF FISHERS RIGHT-OF-WAY ACTIVITY PERMIT IS REQUIRED FOR UTILITY WORK CROSSING EXISTING PUBLIC RIGHT-OF-WAY.
- UTILITY WORK WITHIN THE EXISTING PUBLIC RIGHT-OF-WAY OR WITHIN 5' OF EXISTING PUBLIC RIGHT-OF-WAY PAVEMENT REQUIRES REMOVABLE FLOWABLE FILL.
- ALL ROADS MUST BE BROUGHT BACK TO ORIGINAL OR BETTER CONDITION, INCLUDING BUT NOT LIMITED TO PAVEMENT MARKINGS, CURBSTONE SHOULDERS, SIGNAGE, ETC. REPAIRS SHALL COINCIDE WITH THE ADJOINING ROAD.
- UTILITY CONFLICTS (INCLUDING UTILITY POLES/PEDESTALS) MUST BE COMPLETELY RESOLVED PRIOR TO THE CONSTRUCTION OF ACCELERATION/DECELERATION, PASSING BUSTER LANES AND/OR LEFT TURN LANES. CONSTRUCTION OF THESE LANES INCLUDES BUT IS NOT LIMITED TO EXCAVATION, EMBANKMENT, PAVING, AND SUBGRADE PREPARATION, ETC.

### DESIGN DATA - PROJECT NOTES:

- LOT SIZE: 6.7866 Acres
- TOTAL IMPERVIOUS AREA = 270,512 SF (6.21± ACRES - 92.0%).
- THE PROJECT SITE DOES NOT LIE WITHIN THE 100 YEAR FLOOD PLAIN. REFER TO FLOOD NOTE & SURVEY.
- DESIGN SPEED: 30 MPH



**DRAFT**

REVISION RECORD	
NO.	DATE
1	03/08/24

530 E. Ohio Street  
Suite G  
Indianapolis, IN 46204  
Ph: 317.655.7777  
www.cecinc.com

STUDIO M ARCHITECTS  
CITYWALK ON THE NICKEL PLATE TRAIL  
LANTERN ROAD AND CIRCLE DRIVE  
FISHERS, INDIANA 46038

TITLE SHEET	
DATE:	FEB 23, 2024
DRAWN BY:	BEB
CHECKED BY:	KPG
PROJECT NO.:	323-947
APPROVED BY:	DRAFT

DRAWING NO.  
**C000**



- REFERENCES:**
- BOUNDARY RETRACEMENT AND TOPOGRAPHIC SURVEY PROVIDED BY CIVIL & ENVIRONMENTAL CONSULTANTS, INC. SURVEY DATED 08/19/2022, PROJECT NO. 323-947. 1" CONTOUR INTERVAL.
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  - SEE SHEET C001 FOR GENERAL NOTES AND SHEET SPECIFIC NOTES.
  - CONTRACTOR SHALL REFER TO OTHER PLANS WITHIN THIS CONSTRUCTION SET FOR OTHER PERTINENT INFORMATION. IT IS NOT THE ENGINEER'S INTENT THAT ANY SINGLE PLAN SHEET IN THE SET OF DOCUMENTS FULLY DEPICT ALL WORK ASSOCIATED WITH THE PROJECT.

- DEMOLITION LEGEND:**
- EXISTING ASPHALT TO BE REMOVED
  - EXISTING CONCRETE TO BE REMOVED
  - EXISTING CONCRETE CURB TO BE REMOVED
  - SAWCUT EXISTING PAVEMENT
  - EXISTING UTILITY TO BE REMOVED
  - EXISTING MISC. ITEM TO BE REMOVED

- DEMOLITION ITEMS:**
- FULL-DEPTH SAW-CUT.
  - EXISTING CONCRETE TO BE REMOVED COMPLETE; DISPOSE OF OFF SITE. INCLUDES BASE MATERIAL.
  - REMOVE EXISTING STORM STRUCTURE; DISPOSE OF OFF SITE. PROTECT FROM SEDIMENT PER IDEM STANDARDS.
  - EXISTING ASPHALT TO BE REMOVED COMPLETE; DISPOSE OF OFF SITE.
  - PREVIOUS LOCATION OF EXISTING POOL. VERIFY THAT NO EXISTING REMNANTS REMAIN; DISPOSE OF REMNANTS OFF SITE IF ENCOUNTERED.
  - EXISTING OVERHEAD UTILITY TO BE REMOVED. COORDINATE WITH AFFECTED UTILITY.
  - EXISTING FENCE TO BE REMOVED COMPLETE; DISPOSE OF OFF SITE. INCLUDES ALL BASES, POSTS, GATES, ETC.
  - EXISTING CULVERT TO BE REMOVED COMPLETE; DISPOSE OF OFF SITE.
  - PREVIOUS LOCATION OF EXISTING SANITARY/SEPTIC FEATURE. VERIFY THAT NO REMNANTS REMAIN; DISPOSE OF REMNANTS OFF SITE IF ENCOUNTERED.
  - EXISTING WATER METER, VALVE, ETC. TO BE REMOVED PER CEG STANDARDS; DISPOSE OF OFF SITE.
  - EXISTING GAS METER, VALVE, ETC. TO BE REMOVED; DISPOSE OF OFF SITE. OWNER MUST CALL 1-800-990-1930 TO REQUEST GAS SERVICE BE RETIRED FOR EACH EXISTING ADDRESS.
  - REMOVE EXISTING STORM PIPE; DISPOSE OF OFF SITE.
  - PREVIOUS LOCATION OF EXISTING WATER WELL TO BE FILLED AND ABANDONED IN PLACE PER IDEM STANDARDS. VERIFY IF REMNANTS REMAIN.
  - REMOVE AND RELOCATE EXISTING TRAFFIC SIGNAGE AS NEEDED TO COMPLETE CONSTRUCTION. DISPOSE OF OFF SITE.
  - REMOVE EXISTING SANITARY CLEANOUT AND LATERAL CONNECTION TO MANHOLE. DISPOSE OF OFF SITE.
  - REMOVE EXISTING STORM DRAIN AND PIPING. DISPOSE OF OFF SITE.

NO.	DATE	DESCRIPTION
1	03/08/24	ADDendum #1

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Civil & Environmental  
Consultants, Inc.

**STUDIO M ARCHITECTS**  
CITYWALK ON THE NICKEL PLATE TRAIL  
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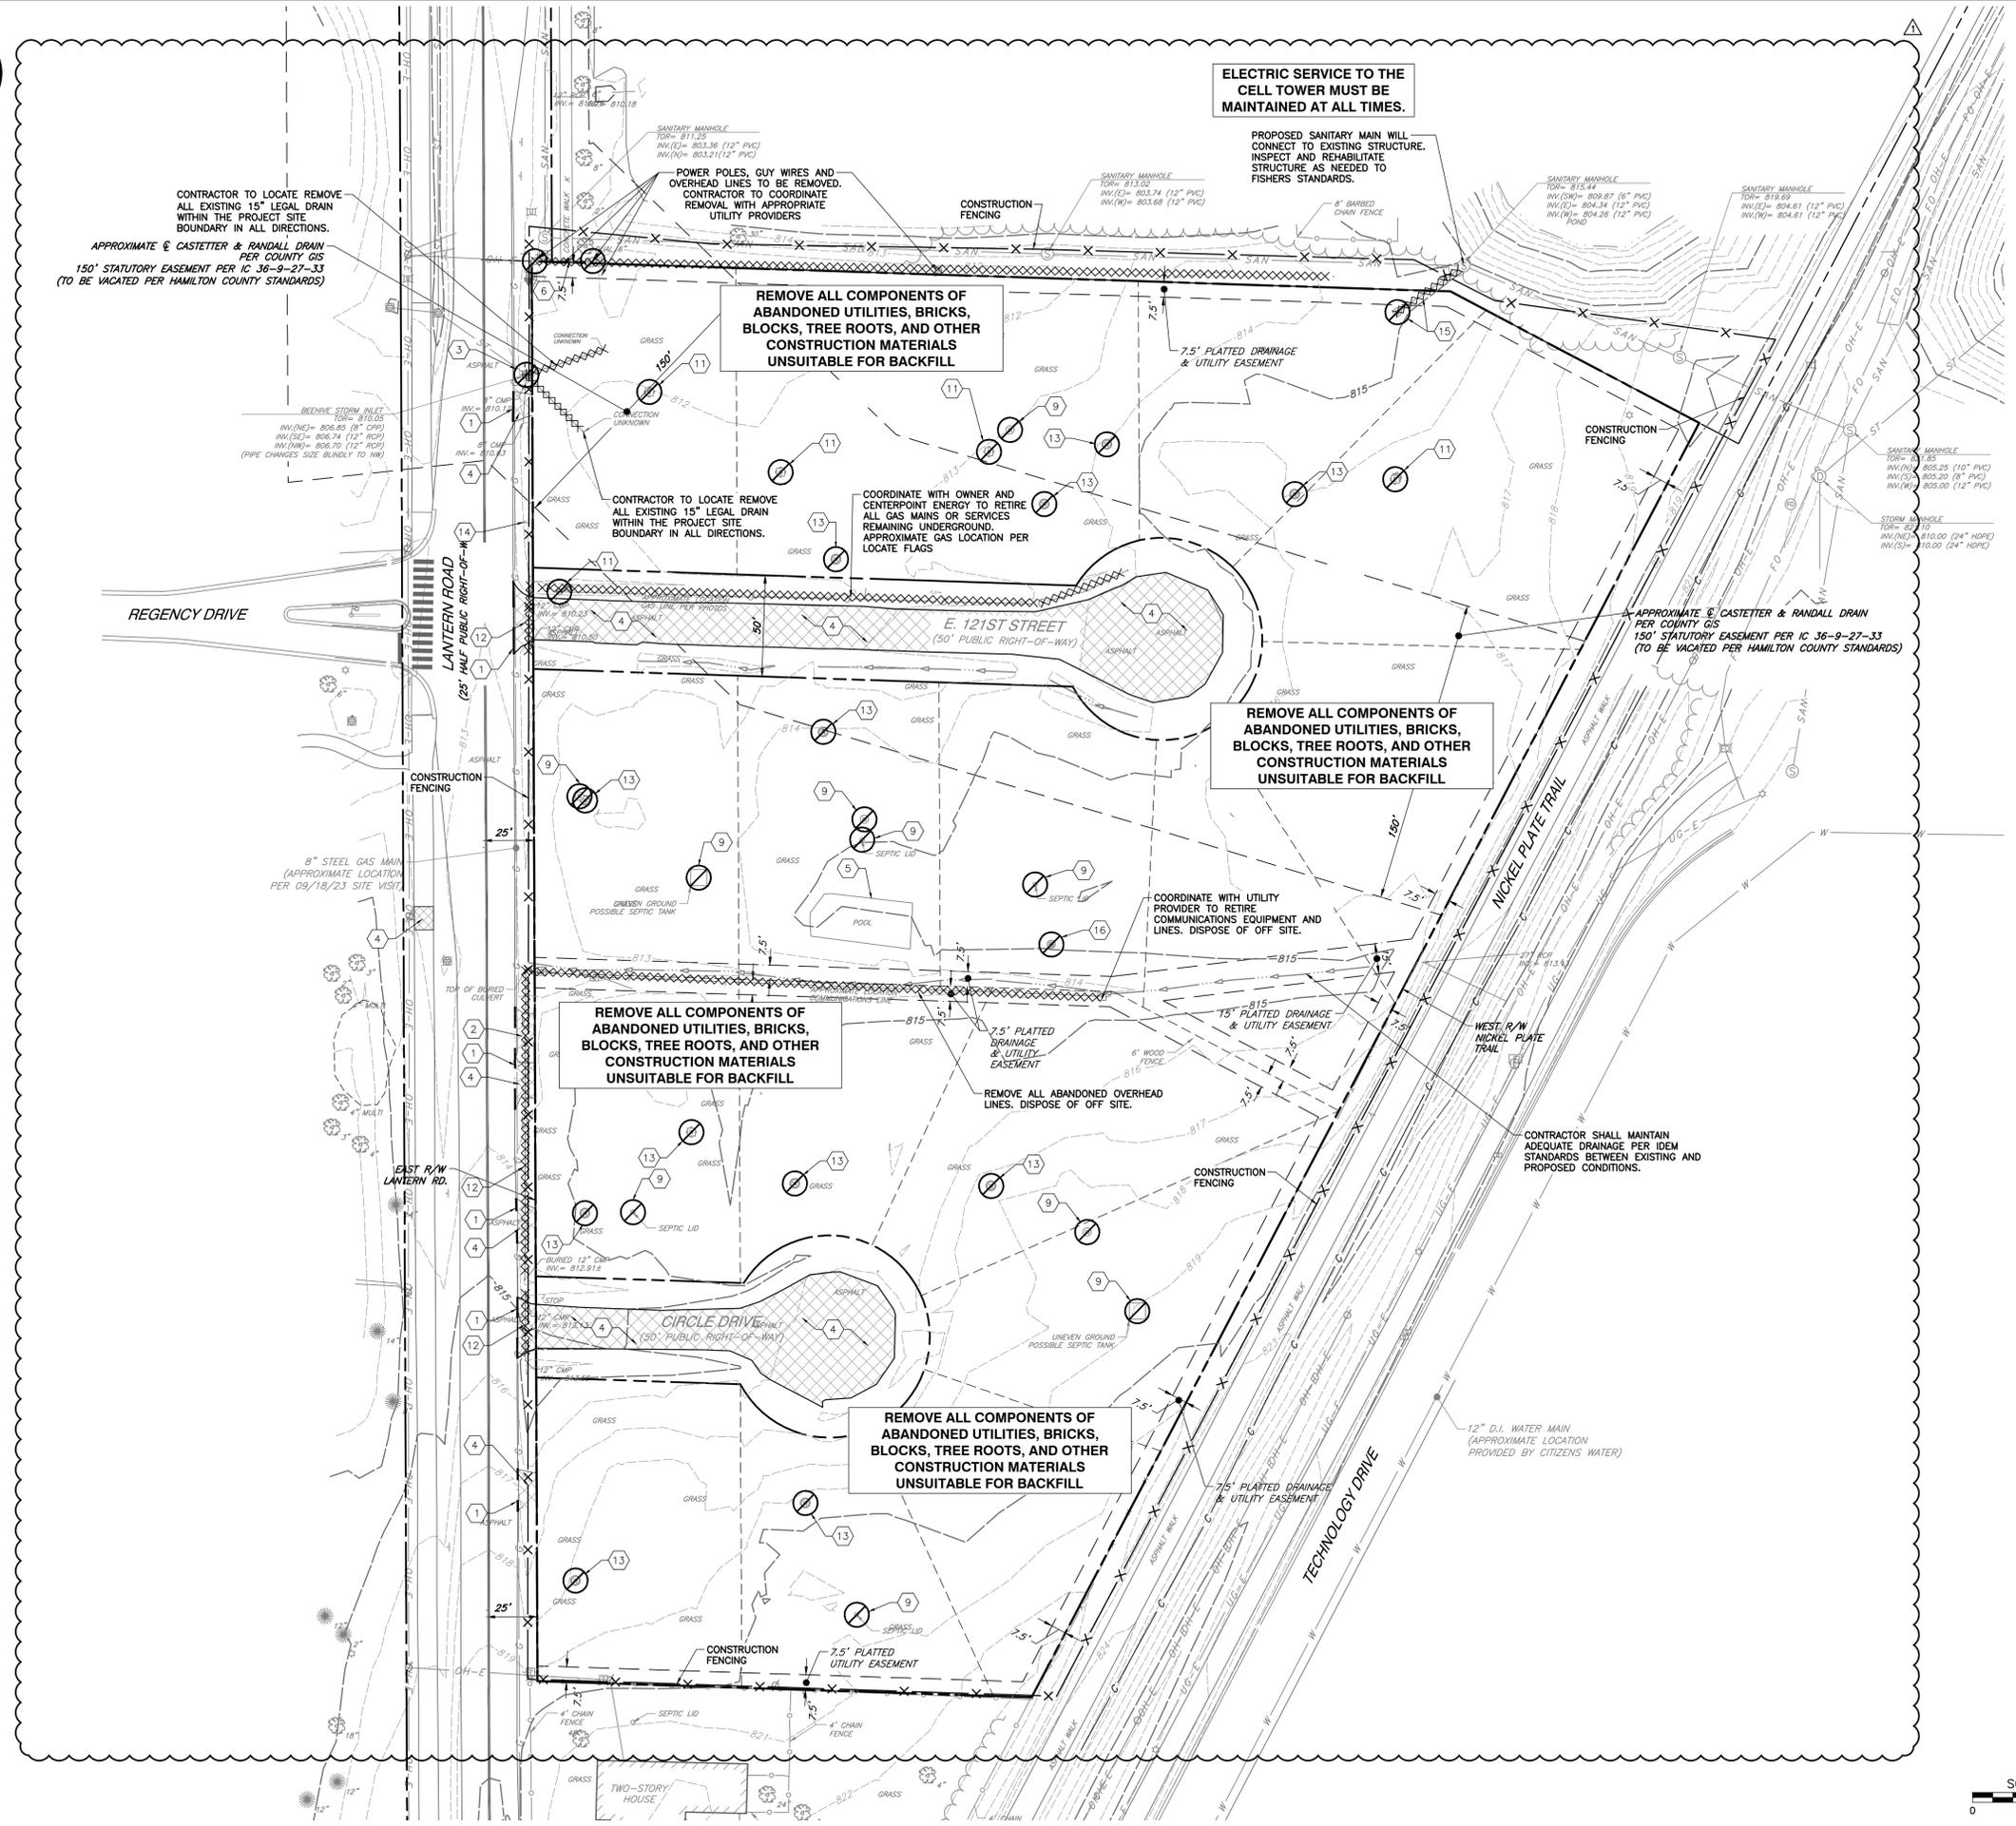
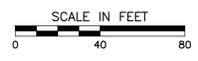
**DEMOLITION PLAN**

DATE: FEB 25, 2024 | DRAWN BY: JCB  
DWG SCALE: 1" = 40' | CHECKED BY: KPG  
PROJECT NO: 323-947  
APPROVED BY: DRAFT

DRAWING NO. **C100**



**DRAFT**




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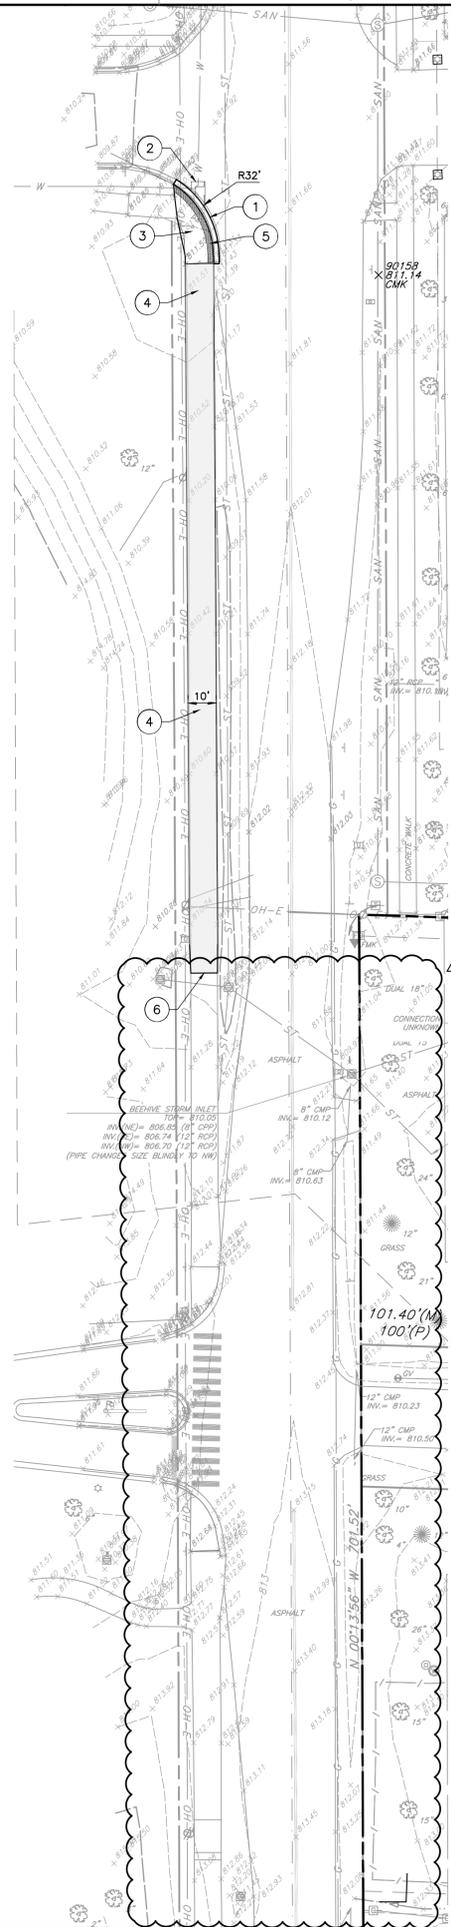






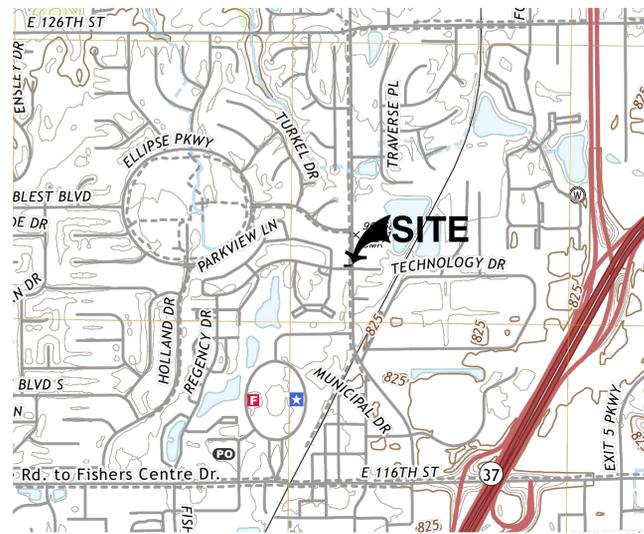

**SITE LOCATION MAP**  
SCALE: 1"=1000'



**SITE LEGEND:**

- PROPOSED ASPHALT PATH
- PROPOSED CONCRETE PAVEMENT
- PROPOSED RIGHT-OF-WAY PAVEMENT
- PROPOSED ADA PARKING SYMBOL, PARKING BUMPER, SIGN, DETECTABLE WARNING STRIP

**DEMOLITION ITEMS:**

- 1 FLUSH CONCRETE CURB
- 2 RIGHT-OF-WAY ASPHALT PAVEMENT. SEE DETAIL ON SHEET C800
- 3 CONCRETE SIDEWALK. SEE CITY OF FISHERS STANDARD CONSTRUCTION DETAILS SHEET 6.
- 4 CITY OF FISHERS PERIMETER PATH. SEE CITY OF FISHERS STANDARD CONSTRUCTION DETAILS SHEET 6.
- 5 DETECTABLE WARNING SURFACE. SEE CITY OF FISHERS STANDARD CONSTRUCTION DETAILS SHEET 6.
- 6 PROVIDE 10' LONG TAPER TO MATCH EXISTING TRAIL WIDTH.

**DEMOLITION NOTES:**

1. THE CONTRACTOR SHALL BE RESPONSIBLE FOR REMOVAL AND DISPOSAL OFF-SITE OF ALL ITEMS SHOWN ON THE DEMOLITION PLAN INCLUDING ITEMS ENCOUNTERED DURING EXCAVATION OF BUILDING FOUNDATIONS AND UTILITY PLACEMENT.
2. PRIOR TO STARTING DEMOLITION, IT IS THE RESPONSIBILITY OF THE CONTRACTOR TO OBTAIN ALL PERMITS REQUIRED BY LOCAL GOVERNMENTAL AGENCIES.
3. THE CONTRACTOR SHALL COORDINATE WITH THE LOCAL UTILITY COMPANIES FOR THE DISCONNECTION AND REMOVAL OF SERVICES TO EXISTING STRUCTURES.
4. ITEMS SHOWN ON THE DEMOLITION PLAN TO BE SALVAGED SHALL BE TRANSPORTED TO LOCATION SPECIFIED BY THE OWNER OR HIS/HER REPRESENTATIVE.
5. ITEMS OF SALVAGEABLE VALUE TO THE CONTRACTOR MAY BE REMOVED WITH THE OWNER OR HIS/HER REPRESENTATIVE'S PERMISSION. THE CONTRACTOR SHALL NOT STORE THESE ITEMS ON SITE.
6. THE CONTRACTOR MAY NOT USE EXPLOSIVES OR BURN DEBRIS.
7. CONDUCT DEMOLITION OPERATIONS TO ENSURE MINIMAL INTERFERENCE WITH ROADS, SIDEWALKS AND ANY OTHER ADJACENT OCCUPIED FACILITIES.
8. DO NOT CLOSE OR OBSTRUCT ROADS, SIDEWALKS OR ANY OTHER OCCUPIED FACILITIES WITHOUT PERMISSION FROM THE LOCAL AUTHORITY HAVING JURISDICTION AND/OR PROPERTY OWNERS.
9. THE CONTRACTOR SHALL ENSURE SAFE PASSAGE OF PERSON TRAVERSING THROUGH OR AROUND THE CONSTRUCTION SITE.
10. THE CONTRACTOR SHALL PROTECT FROM DAMAGE, SURROUNDING STRUCTURES, UTILITIES AND OTHER FACILITIES DURING DEMOLITION AND REMOVAL OPERATIONS.
11. BUILDING STRUCTURES INCLUDING FOUNDATIONS OR BASEMENTS SHALL BE REMOVED AND BACKFILLED WITH APPROVED BACKFILL MATERIAL. BACKFILL MATERIAL SHALL BE PLACED IN MAXIMUM EIGHT INCH LIFTS AND COMPACTED IN ACCORDANCE WITH THE GEOTECHNICAL REPORT OR A MINIMUM OF 95% OF A STANDARD PROCTOR.
12. UTILITIES SHALL BE REMOVED AND BACKFILLED WITH APPROVED BACKFILL MATERIAL. BACKFILL MATERIAL SHALL BE PLACED IN MAXIMUM EIGHT INCH LIFTS AND COMPACTED IN ACCORDANCE WITH THE GEOTECHNICAL REPORT OR A MINIMUM OF 95% OF A STANDARD PROCTOR.
13. THE CONTRACTOR SHALL BE RESPONSIBLE FOR ENSURING THE CONSTRUCTION SITE AND SURROUNDING AREAS ARE FREE OF ACCUMULATED DEBRIS.

**REVISION RECORD**

NO.	DATE	DESCRIPTION
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**STUDIO M ARCHITECTS**  
CITYWALK ON THE NICKEL PLATE TRAIL  
LANERN ROAD AND CIRCLE DRIVE  
FISHERS, INDIANA 46038

**WATER MAIN SITE PLAN**

DATE: FEB 23, 2024 | DRAWN BY: JCB  
DWG SCALE: 1" = 30' | CHECKED BY: KPG  
PROJECT NO: 323-947  
APPROVED BY: DRAFT

**DRAFT**



DRAWING NO:  
**C204**



A:\100-2001\1021-9471-0000\Drawings\1021-9471-0001-Chrome Meter Main.dwg (2/23/24 3:59 PM)







- REFERENCES:**
- BOUNDARY RETRACEMENT AND TOPOGRAPHIC SURVEY PROVIDED BY CIVIL & ENVIRONMENTAL CONSULTANTS, INC. SURVEY DATED 08/19/2022, PROJECT NO. 323-947. 1" CONTOUR INTERVAL.
  - AERIAL IMAGERY SHOWN ON PLANS GENERATED FROM GOOGLE EARTH.
  - FISHERS STANDARD CONSTRUCTION DETAILS AMENDED JANUARY 2022. [HTTPS://WWW.FISHERS.IN.US/390/DESIGN-STANDARDS-SPECS](https://www.fishers.in.us/390/DESIGN-STANDARDS-SPECS)
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  - SEE SHEET C001 FOR GENERAL NOTES AND SHEET SPECIFIC NOTES.
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STRUCTURE TABLE				
STRUCTURE NAME	RIM E.	INVERT IN	INVERT OUT	DESCRIPTION
102	810.05	103 = 806.80		INLET TYPE "E"
103	812.32	109 = 807.53	103 = 807.43	4" MANHOLE NEENAH R-3405
104	814.79	105 = 807.94	104 = 808.04	4" MANHOLE NEENAH R-1772
105	814.46	106B = 808.01 108 = 808.21	106A = 808.21 105 = 808.01	9" DIVERSION STRUCTURE
106	814.78	106A = 808.11	106B = 808.11	BMP XC-10
109	813.00	110 = 808.07	109 = 807.97	INLET TYPE "M"
110	814.17	111 = 808.83	110 = 808.73	INLET TYPE "I"
111	813.84		111 = 809.23	INLET TYPE "I"
186	816.74	188 = 807.28	190 = 807.18	5" MANHOLE NEENAH R-1772
189	810.30	190 = 807.00		Concrete Flared End Section
191	814.82	104 = 807.68	188 = 807.58	6" MANHOLE NEENAH R-1772

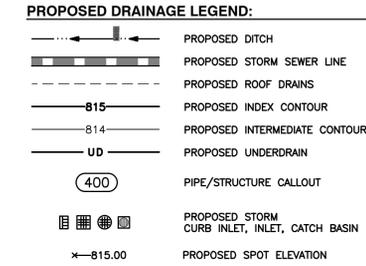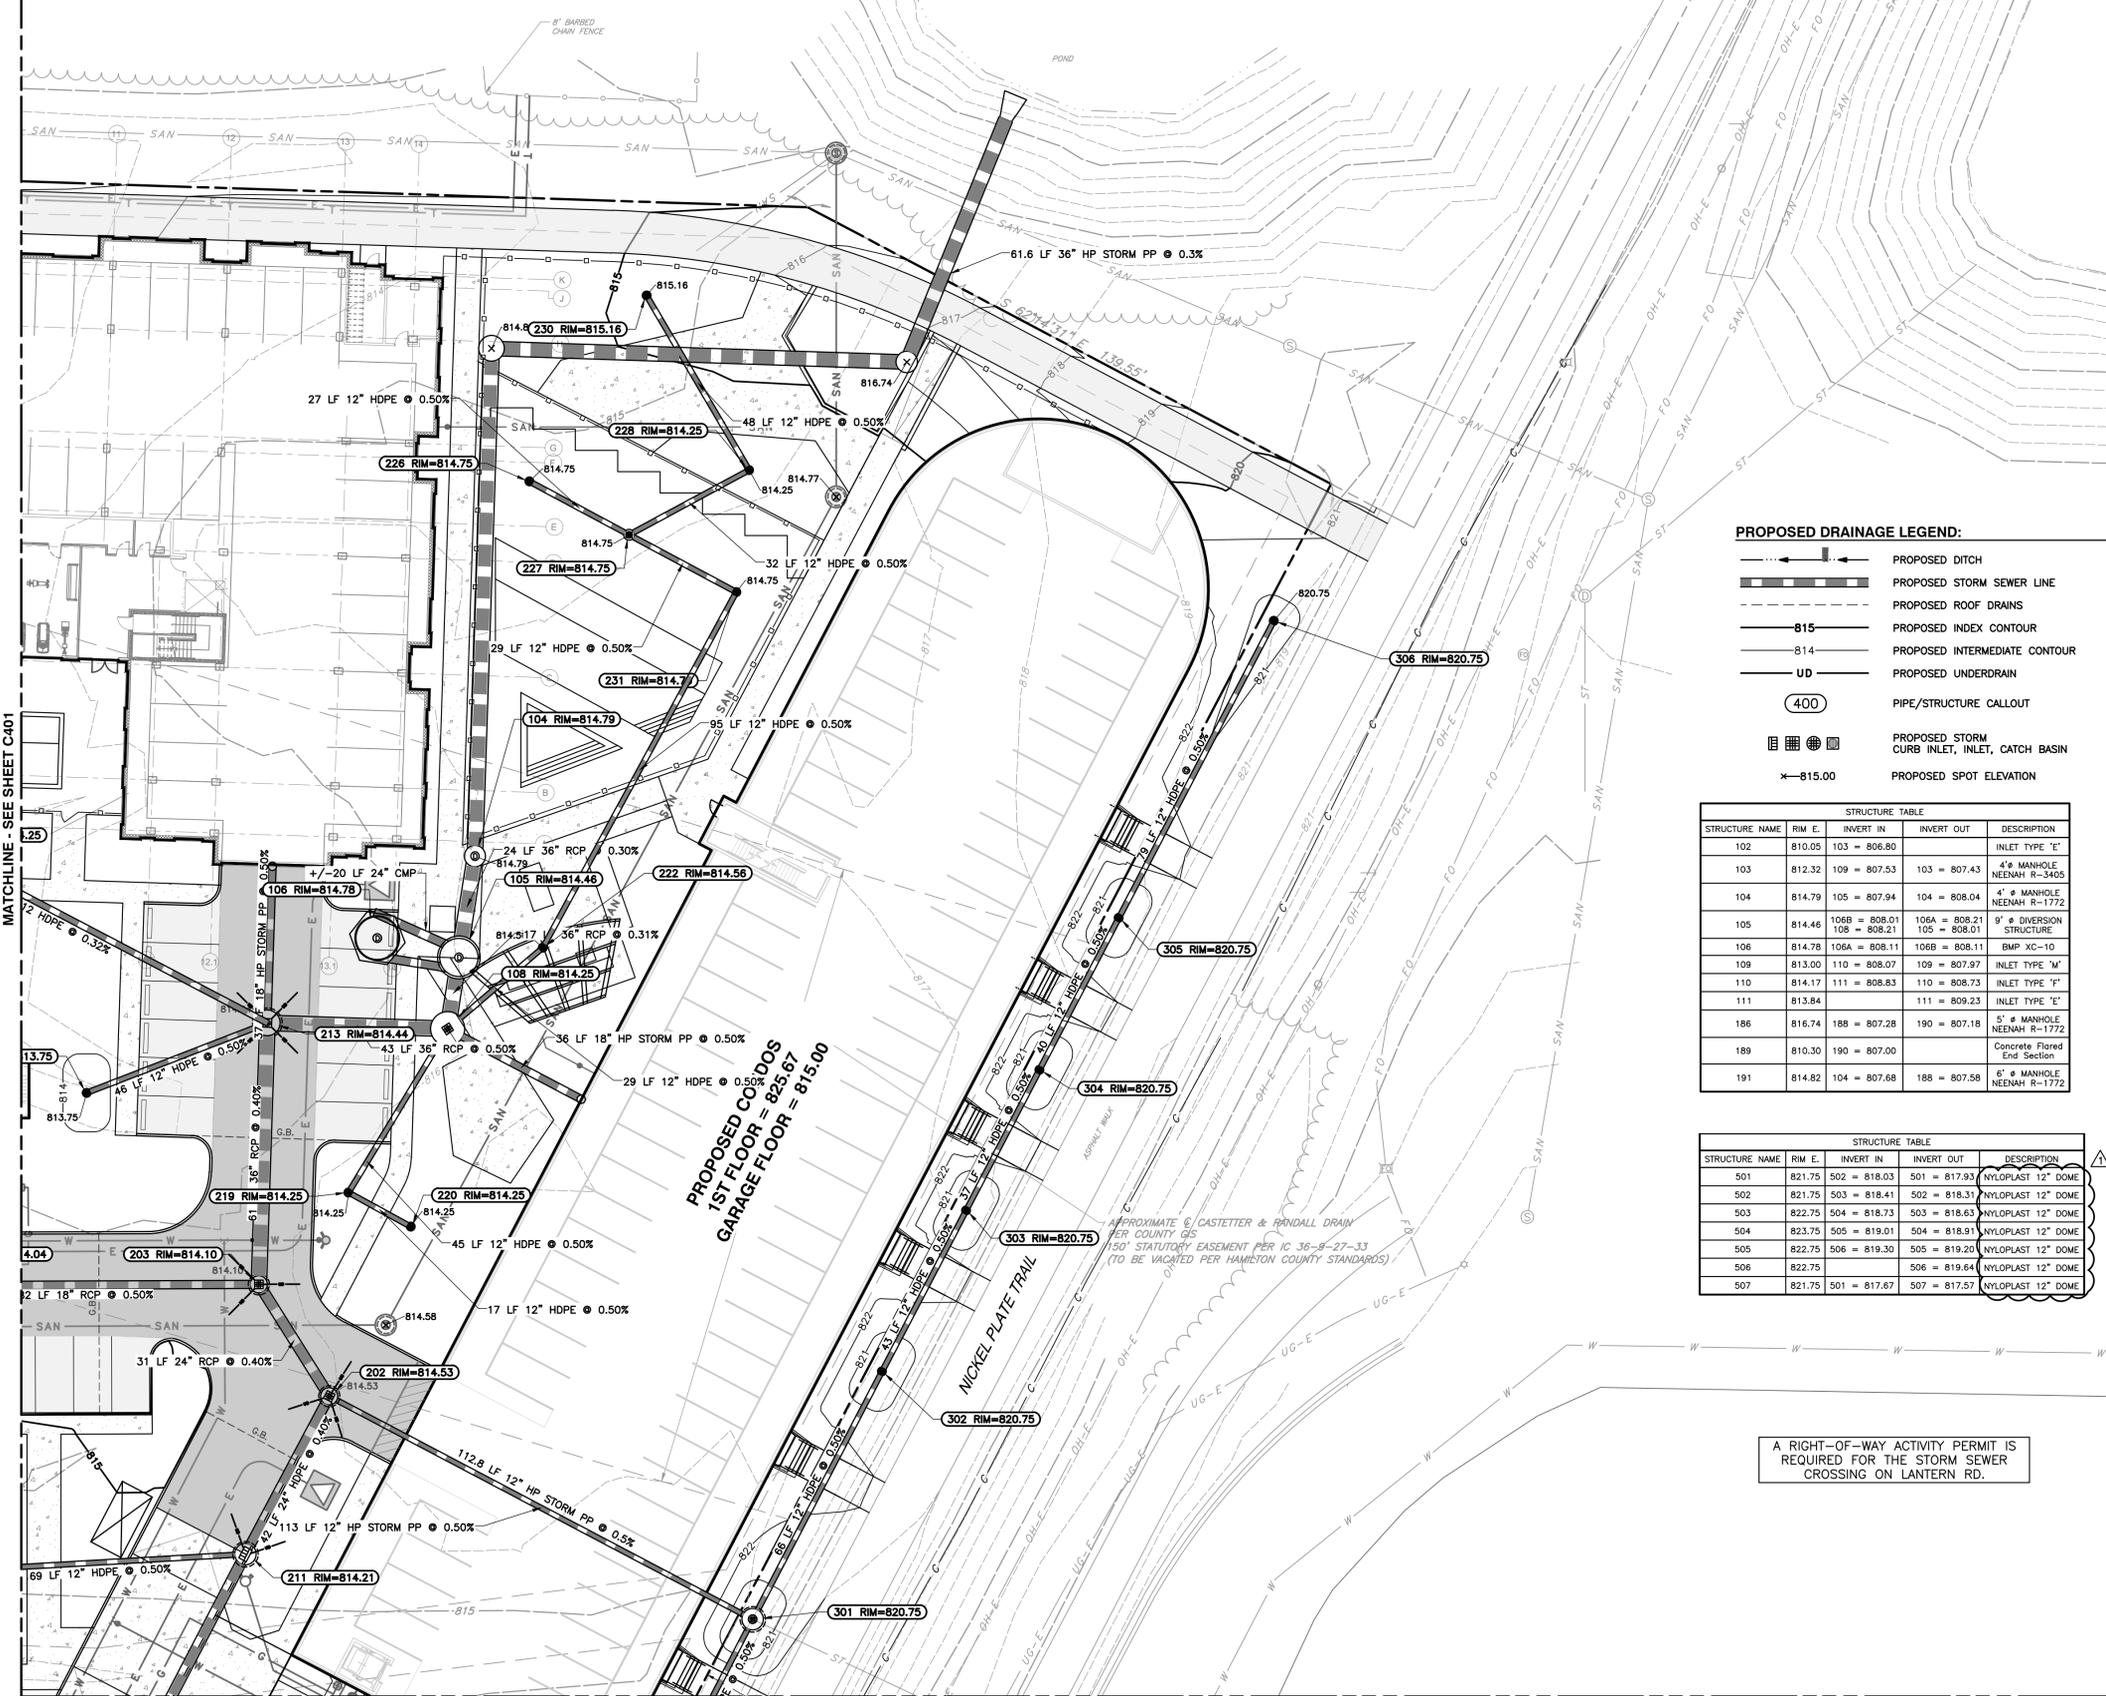STRUCTURE TABLE				
STRUCTURE NAME	RIM E.	INVERT IN	INVERT OUT	DESCRIPTION
501	821.75	502 = 818.03	501 = 817.93	NYLOPLAST 12" DOME
502	821.75	503 = 818.41	502 = 818.31	NYLOPLAST 12" DOME
503	822.75	504 = 818.73	503 = 818.63	NYLOPLAST 12" DOME
504	823.75	505 = 819.01	504 = 818.91	NYLOPLAST 12" DOME
505	822.75	506 = 819.30	505 = 819.20	NYLOPLAST 12" DOME
506	822.75		506 = 819.64	NYLOPLAST 12" DOME
507	821.75	501 = 817.67	507 = 817.57	NYLOPLAST 12" DOME

STRUCTURE TABLE				
STRUCTURE NAME	RIM E.	INVERT IN	INVERT OUT	DESCRIPTION
108A	810.26		108A = 808.54	ROOF DRAIN
108	814.25	213 = 808.38 108A = 808.38 219 = 810.85 222 = 810.69	108 = 808.26	8" MANHOLE NEENAH R-3405
202	814.53	301 = 810.44 211 = 809.28	202 = 809.16	4" MANHOLE NEENAH R-3405
203	814.10	204 = 809.04 202 = 809.04	203 = 808.94	4" MANHOLE NEENAH R-3405
204	814.04	205 = 809.55	204 = 809.45	4" MANHOLE NEENAH R-3405
205	813.98	215 = 809.92	205 = 809.82	4" MANHOLE NEENAH R-3405
207	813.75	208 = 809.44	207 = 809.34	NYLOPLAST 15" DOME
208	813.75	209 = 809.64	208 = 809.54	NYLOPLAST 15" DOME
209	814.75	218 = 811.17 210 = 809.94	209 = 809.84	NYLOPLAST 15" DOME
210	812.84		210 = 810.23	INLET TYPE "M"
211	814.21	212 = 808.67 418 = 809.53	211 = 809.43	5" MANHOLE NEENAH R-3287-10V
212	813.75		212 = 810.01	NYLOPLAST 12" DOME
213A	810.60		213A = 808.67	ROOF DRAIN
213	814.44	203 = 808.69 214 = 808.69 213A = 808.69	213 = 808.59	6" MANHOLE NEENAH R-3405
214	813.75		214 = 808.92	NYLOPLAST 15" DOME
215	813.98		215 = 810.19	4" MANHOLE NEENAH R-3405
216	814.25	207 = 809.18 217 = 810.86	216 = 809.08	NYLOPLAST 15" DOME
217	814.73		217 = 811.01	NYLOPLAST 12" PEDESTRIAN
218	814.68		218 = 811.30	NYLOPLAST 12" PEDESTRIAN
219	814.25	220 = 811.17	219 = 811.07	NYLOPLAST 15" DOME
220	814.25		220 = 811.25	NYLOPLAST 15" DOME
222	814.56	231 = 810.94	222 = 810.84	NYLOPLAST 18" PEDESTRIAN
226	814.75		226 = 811.79	NYLOPLAST 18" PEDESTRIAN
227	814.75	228 = 811.66 228 = 811.66	227 = 811.56	30" NYLOPLAST 18" PEDESTRIAN
228	814.25	230 = 811.92	228 = 811.82	NYLOPLAST 18" PEDESTRIAN
230	815.16		230 = 812.16	NYLOPLAST 18" DOME
231	814.75	227 = 811.42	231 = 811.42	NYLOPLAST 18" PEDESTRIAN
301	820.75	302 = 816.03 307 = 817.00 192 = 813.13	301 = 811.00	5" MANHOLE NEENAH R-4342
302	820.75	303 = 816.45	302 = 816.35	NYLOPLAST 12" DOME
303	820.75	304 = 816.77	303 = 816.67	NYLOPLAST 12" DOME
304	820.75	305 = 817.05	304 = 816.95	NYLOPLAST 12" DOME
305	820.75	306 = 817.36	305 = 817.26	NYLOPLAST 12" DOME
306	820.75		306 = 817.75	NYLOPLAST 12" DOME
307	821.75	507 = 817.32	307 = 817.22	NYLOPLAST 12" DOME
401	812.60		401 = 810.32	ROOF DRAIN
402	814.64	403 = 810.22 401 = 810.22 408 = 810.22	402 = 810.12	5" MANHOLE NEENAH R-3405
403	815.33	404 = 810.67	403 = 810.57	4" MANHOLE NEENAH R-10V
404	815.25	421 = 811.12 405 = 811.12 423 = 811.12	404 = 811.02	5" MANHOLE NEENAH R-3405
405	815.76	406 = 811.40	405 = 811.30	4" MANHOLE NEENAH R-3405
406	817.26	407 = 812.04	406 = 811.94	4" MANHOLE NEENAH R-3405
407	818.38		407 = 812.33	4" MANHOLE NEENAH R-3405
408	814.40	409 = 810.55	408 = 810.45	INLET TYPE "M"
409	814.25	410 = 810.75	409 = 810.65	NYLOPLAST 15" DOME
410	814.25	414 = 811.04 411 = 811.02	410 = 810.92	30" NYLOPLAST 15" DOME
411	814.77	412 = 811.31	411 = 811.21	NYLOPLAST 18" PEDESTRIAN
412	815.61	413 = 811.54	412 = 811.44	NYLOPLAST 18" PEDESTRIAN
413	817.48		413 = 811.70	NYLOPLAST 18" PEDESTRIAN
414	816.21	415 = 811.24	414 = 811.14	NYLOPLAST 12" PEDESTRIAN
415	816.36	416 = 811.45	415 = 811.35	NYLOPLAST 12" PEDESTRIAN
416	816.46	417 = 811.68	416 = 811.58	NYLOPLAST 12" PEDESTRIAN
417	817.07		417 = 811.76	NYLOPLAST 12" PEDESTRIAN
418	814.22	402 = 809.85 418 = 809.85	418 = 809.75	5" MANHOLE NEENAH R-3287-10V
419	815.84	420 = 810.25	419 = 810.15	NYLOPLAST 15" DOME
420	814.98		420 = 810.53	NYLOPLAST 12" PEDESTRIAN
421	814.76	422 = 811.49	421 = 811.39	INLET TYPE "A"
422	814.64		422 = 811.91	INLET TYPE "A"
423	814.72		423 = 811.35	INLET TYPE "M"

A RIGHT-OF-WAY ACTIVITY PERMIT IS REQUIRED FOR THE STORM SEWER CROSSING ON LANTERN RD.



**DRAFT**

**REVISION RECORD**

NO.	DATE	DESCRIPTION
1	03/08/24	ADDENDUM #1

530 E. Ohio Street  
Suite G  
Indianapolis, IN 46204  
Ph: 317.655.7777  
www.cecinco.com

**Civil & Environmental Consultants, Inc.**

**STUDIO M ARCHITECTS**  
CITYWALK ON THE NICKEL PLATE TRAIL  
LANTERN ROAD AND CIRCLE DRIVE  
FISHERS, INDIANA 46038

**DRAINAGE PLAN**

DATE:	DRAWN BY:	BEB
FEB 25, 2024	KPG	
DWG SCALE:	1" = 20'	CHECKED BY:
		323-947
PROJECT NO:	APPROVED BY:	DRAFT

DRAWING NO:  
**C402**

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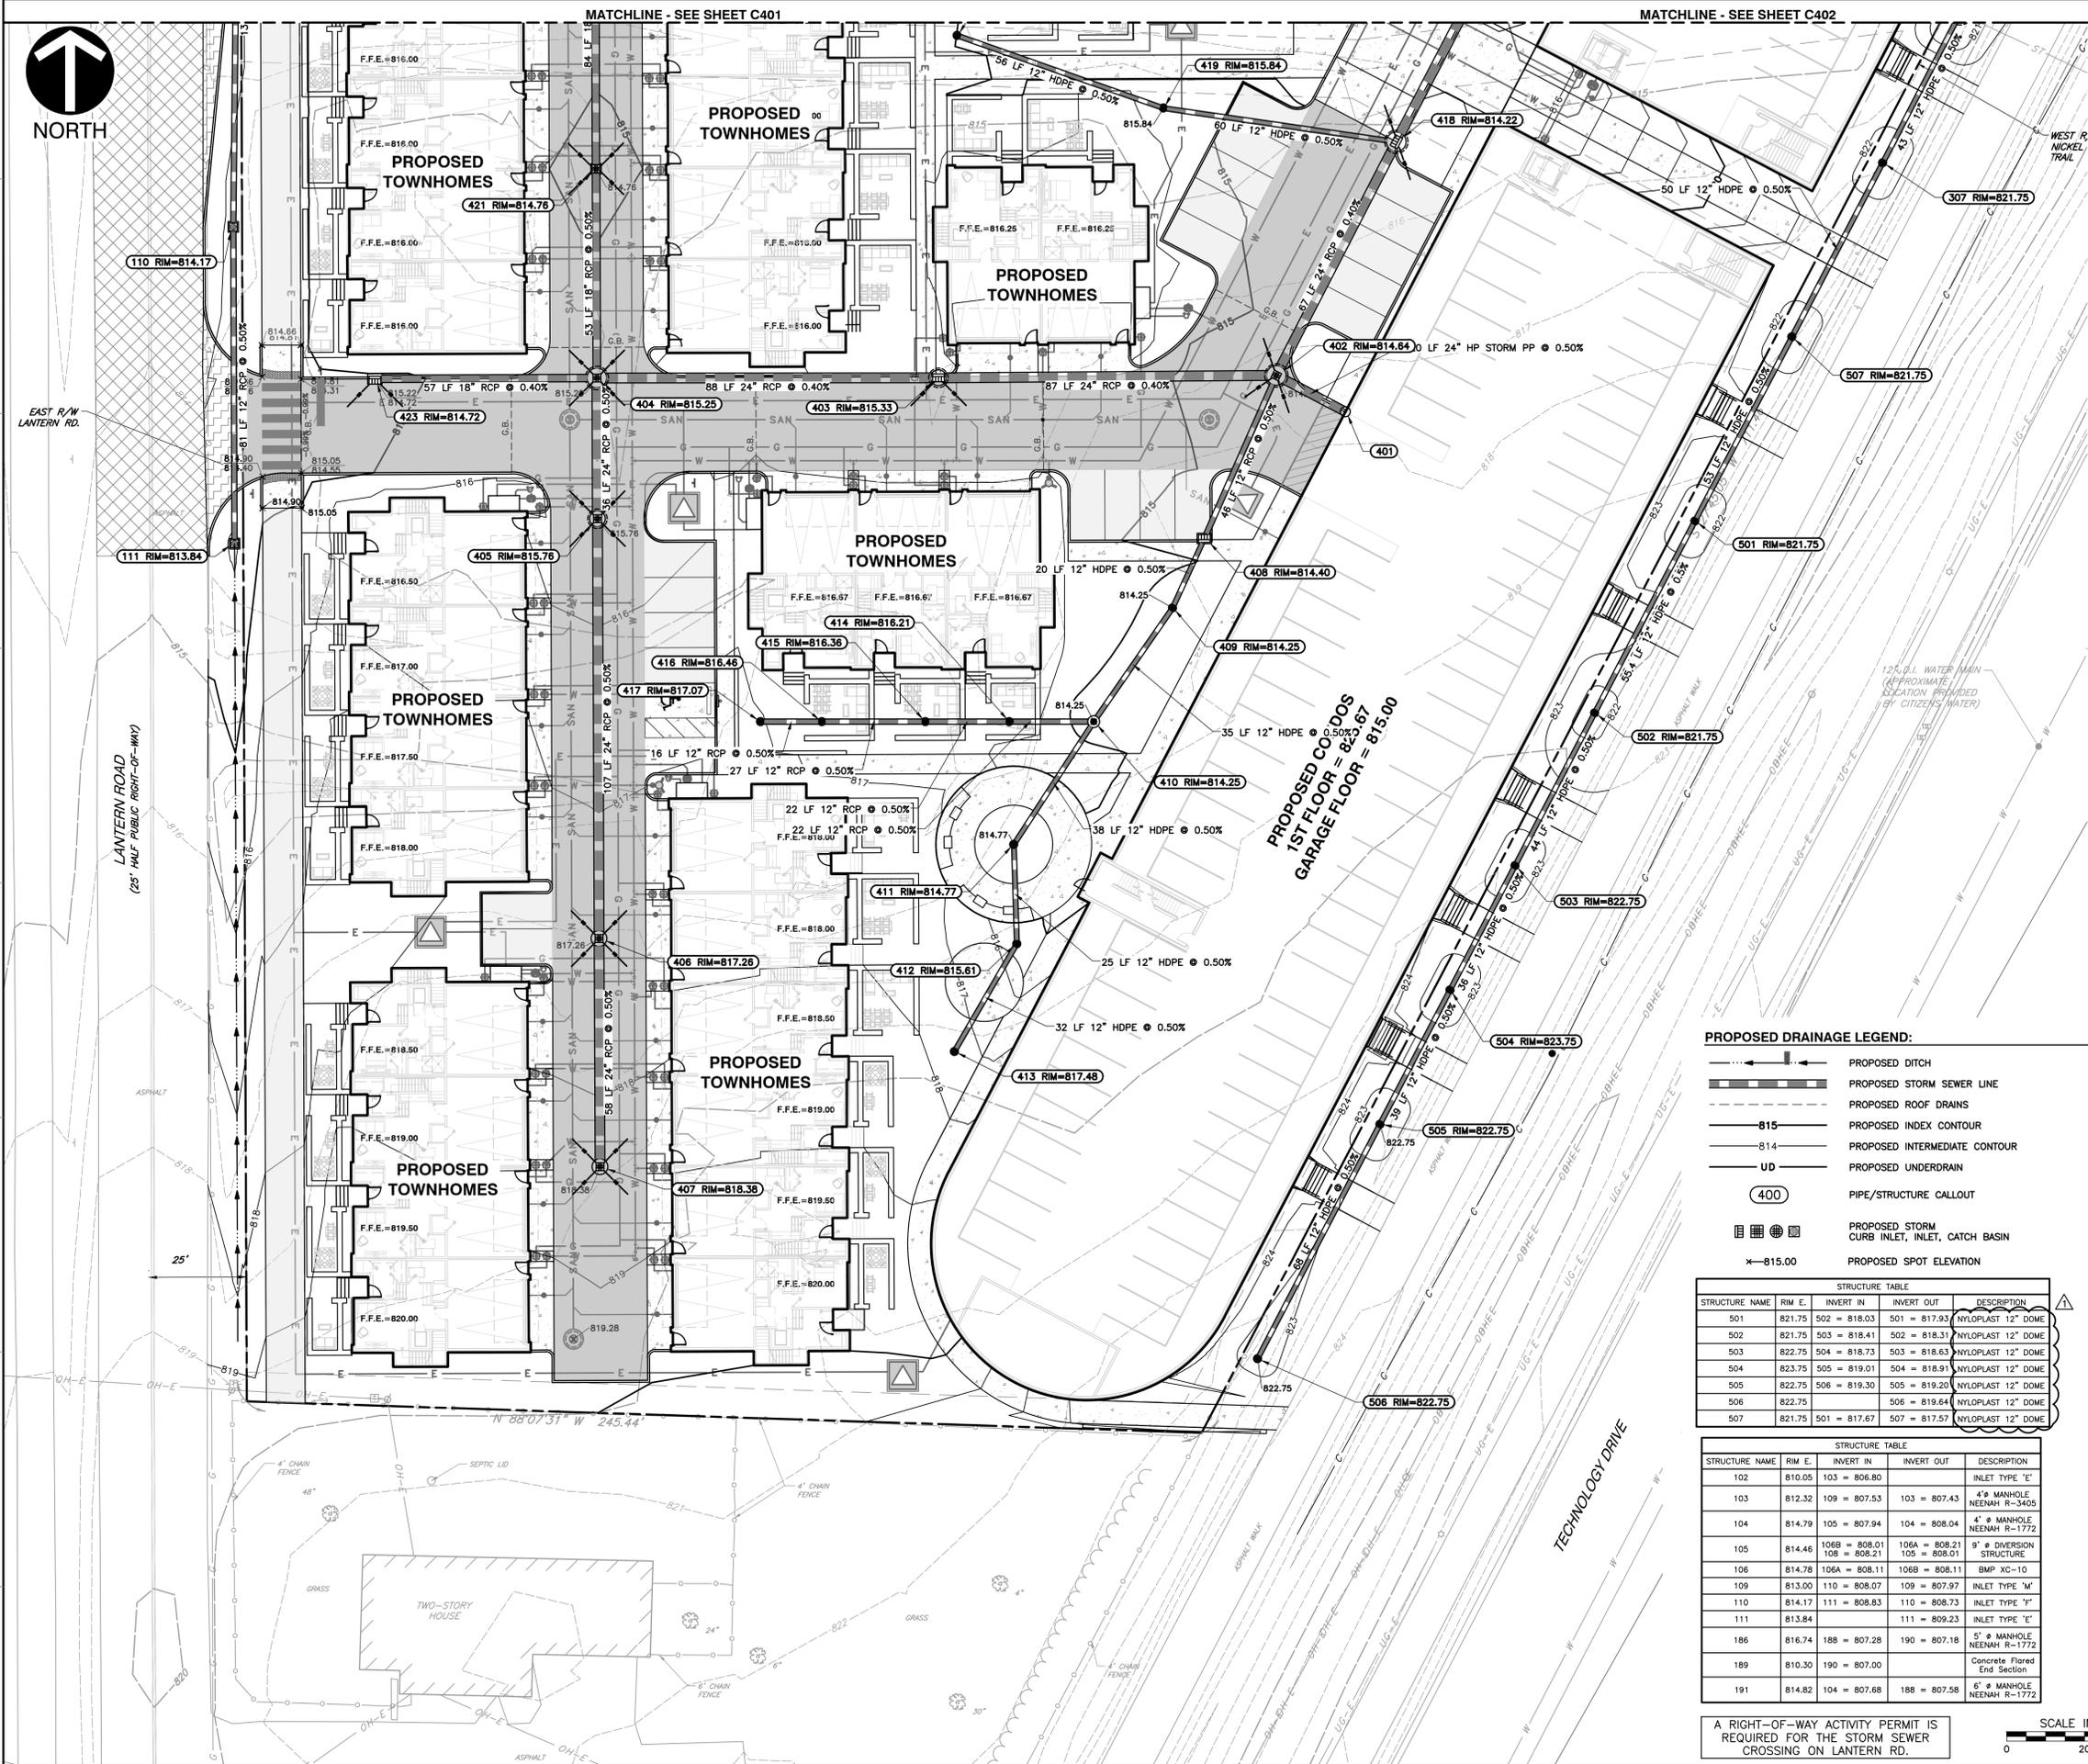


NORTH

MATCHLINE - SEE SHEET C401

MATCHLINE - SEE SHEET C402

A:\130-2021\1302-947-C402\Drawings\1302947-C402-C406.mxd(1) LSC1/7/2024 - mvy - LP - 3/28/2024 4:01 PM



- REFERENCES:**
- BOUNDARY RETRACEMENT AND TOPOGRAPHIC SURVEY PROVIDED BY CIVIL & ENVIRONMENTAL CONSULTANTS, INC. SURVEY DATED 08/19/2022, PROJECT NO. 323-947. 1" CONTOUR INTERVAL.
  - AERIAL IMAGERY SHOWN ON PLANS GENERATED FROM GOOGLE EARTH.
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  - OFFSITE TOPOGRAPHY AND SURFACE INFORMATION REFERENCED FROM HAMILTON COUNTY GIS DATA PORTAL. <https://gis1.hamiltoncounty.in.gov/portal/home/>
  - SEE SHEET C001 FOR GENERAL NOTES AND SHEET SPECIFIC NOTES.
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STRUCTURE TABLE		STRUCTURE NAME	RIM E.	INVERT IN	INVERT OUT	DESCRIPTION
108A	810.26			108A = 808.54		ROOF DRAIN
108	814.25	213 = 808.38 108A = 808.38 219 = 810.85 222 = 810.69		108 = 808.26		8" MANHOLE NEENAH R-3405
202	814.53	301 = 810.44 211 = 809.25		202 = 809.16		4" MANHOLE NEENAH R-3405
203	814.10	204 = 809.04 202 = 809.04		203 = 808.94		4" MANHOLE NEENAH R-3405
204	814.04	205 = 809.55		204 = 809.45		4" MANHOLE NEENAH R-3405
205	813.98	215 = 809.92		205 = 809.82		4" MANHOLE NEENAH R-3405
207	813.75	208 = 808.44		207 = 809.34		NYLOPLAST 15" DOME
208	813.75	209 = 809.64		208 = 809.54		NYLOPLAST 15" DOME
209	814.75	218 = 811.17 210 = 809.94		209 = 809.84		NYLOPLAST 15" DOME
210	812.84			210 = 810.23		INLET TYPE 'M'
211	814.21	212 = 809.67 418 = 809.53		211 = 809.43		5" MANHOLE NEENAH R-3287-10V
212	813.75			212 = 810.01		NYLOPLAST 12" DOME
213A	810.60			213A = 808.87		ROOF DRAIN
213	814.44	203 = 808.69 214 = 808.69 213A = 808.69		213 = 808.59		6" MANHOLE NEENAH R-3405
214	813.75			214 = 808.92		NYLOPLAST 15" DOME
215	813.98			215 = 810.19		4" MANHOLE NEENAH R-3405
216	814.25	207 = 809.18 217 = 810.86		216 = 809.08		NYLOPLAST 15" DOME
217	814.73			217 = 811.01		NYLOPLAST 12" PEDESTRIAN
218	814.68			218 = 811.30		NYLOPLAST 12" PEDESTRIAN
219	814.25	220 = 811.17		219 = 811.07		NYLOPLAST 15" DOME
220	814.25			220 = 811.25		NYLOPLAST 15" DOME
222	814.56	231 = 810.94		222 = 810.84		NYLOPLAST 18" PEDESTRIAN
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227	814.75	228 = 811.66 226 = 811.66		227 = 811.56		30" NYLOPLAST 18" PEDESTRIAN
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303	820.75	304 = 816.77		303 = 816.67		NYLOPLAST 12" DOME
304	820.75	305 = 817.05		304 = 816.95		NYLOPLAST 12" DOME
305	820.75	306 = 817.36		305 = 817.26		NYLOPLAST 12" DOME
306	820.75	306 = 817.75		306 = 817.65		NYLOPLAST 12" DOME
307	821.75	507 = 817.32		307 = 817.22		NYLOPLAST 12" DOME
401	812.60			401 = 810.32		ROOF DRAIN
402	814.64	403 = 810.22 401 = 810.22 408 = 810.22		402 = 810.12		5" MANHOLE NEENAH R-3405
403	815.33	404 = 810.67		403 = 810.57		4" MANHOLE NEENAH R-3287-10V
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409	814.25	410 = 810.75		409 = 810.65		NYLOPLAST 15" DOME
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413	817.48			413 = 811.70		NYLOPLAST 18" PEDESTRIAN
414	816.21	415 = 811.24		414 = 811.14		NYLOPLAST 12" PEDESTRIAN
415	816.36	416 = 811.45		415 = 811.35		NYLOPLAST 12" PEDESTRIAN
416	816.46	417 = 811.88		416 = 811.58		NYLOPLAST 12" PEDESTRIAN
417	817.07			417 = 811.76		NYLOPLAST 12" PEDESTRIAN
418	814.22	402 = 809.85 419 = 809.85		418 = 809.75		5" MANHOLE NEENAH R-3287-10V
419	815.84	420 = 810.25		419 = 810.15		NYLOPLAST 15" DOME
420	814.98			420 = 810.53		NYLOPLAST 12" PEDESTRIAN
421	814.76	422 = 811.49		421 = 811.39		INLET TYPE 'A'
422	814.64			422 = 811.91		INLET TYPE 'A'
423	814.72	423 = 811.35		423 = 811.35		INLET TYPE 'M'

**PROPOSED DRAINAGE LEGEND:**

- PROPOSED DITCH
- PROPOSED STORM SEWER LINE
- PROPOSED ROOF DRAINS
- PROPOSED INDEX CONTOUR
- PROPOSED INTERMEDIATE CONTOUR
- PROPOSED UNDERSDRAIN
- PIPE/STRUCTURE CALLOUT
- PROPOSED STORM CURB INLET, INLET, CATCH BASIN
- PROPOSED SPOT ELEVATION

STRUCTURE TABLE		STRUCTURE NAME	RIM E.	INVERT IN	INVERT OUT	DESCRIPTION
501	821.75	502 = 818.03		501 = 817.93		NYLOPLAST 12" DOME
502	821.75	503 = 818.41		502 = 818.31		NYLOPLAST 12" DOME
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STRUCTURE TABLE		STRUCTURE NAME	RIM E.	INVERT IN	INVERT OUT	DESCRIPTION
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106	814.78	106A = 808.11		106B = 808.11		BMP XC-10
109	813.00	110 = 808.07		109 = 807.97		INLET TYPE 'M'
110	814.17	111 = 808.83		110 = 808.73		INLET TYPE 'M'
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189	810.30	190 = 807.00				Concrete Flared End Section
191	814.82	104 = 807.68		188 = 807.58		6" MANHOLE NEENAH R-1772

A RIGHT-OF-WAY ACTIVITY PERMIT IS REQUIRED FOR THE STORM SEWER CROSSING ON LANTERN RD.



**DRAFT**

DRAWING NO. **C403**

**STUDIO M ARCHITECTS**  
CITYWALK ON THE NICKEL PLATE TRAIL  
LANTERN ROAD AND CIRCLE DRIVE  
FISHERS, INDIANA 46038

**530 E. Ohio Street**  
Suite G  
Indianapolis, IN 46204  
Ph: 317.655.7777  
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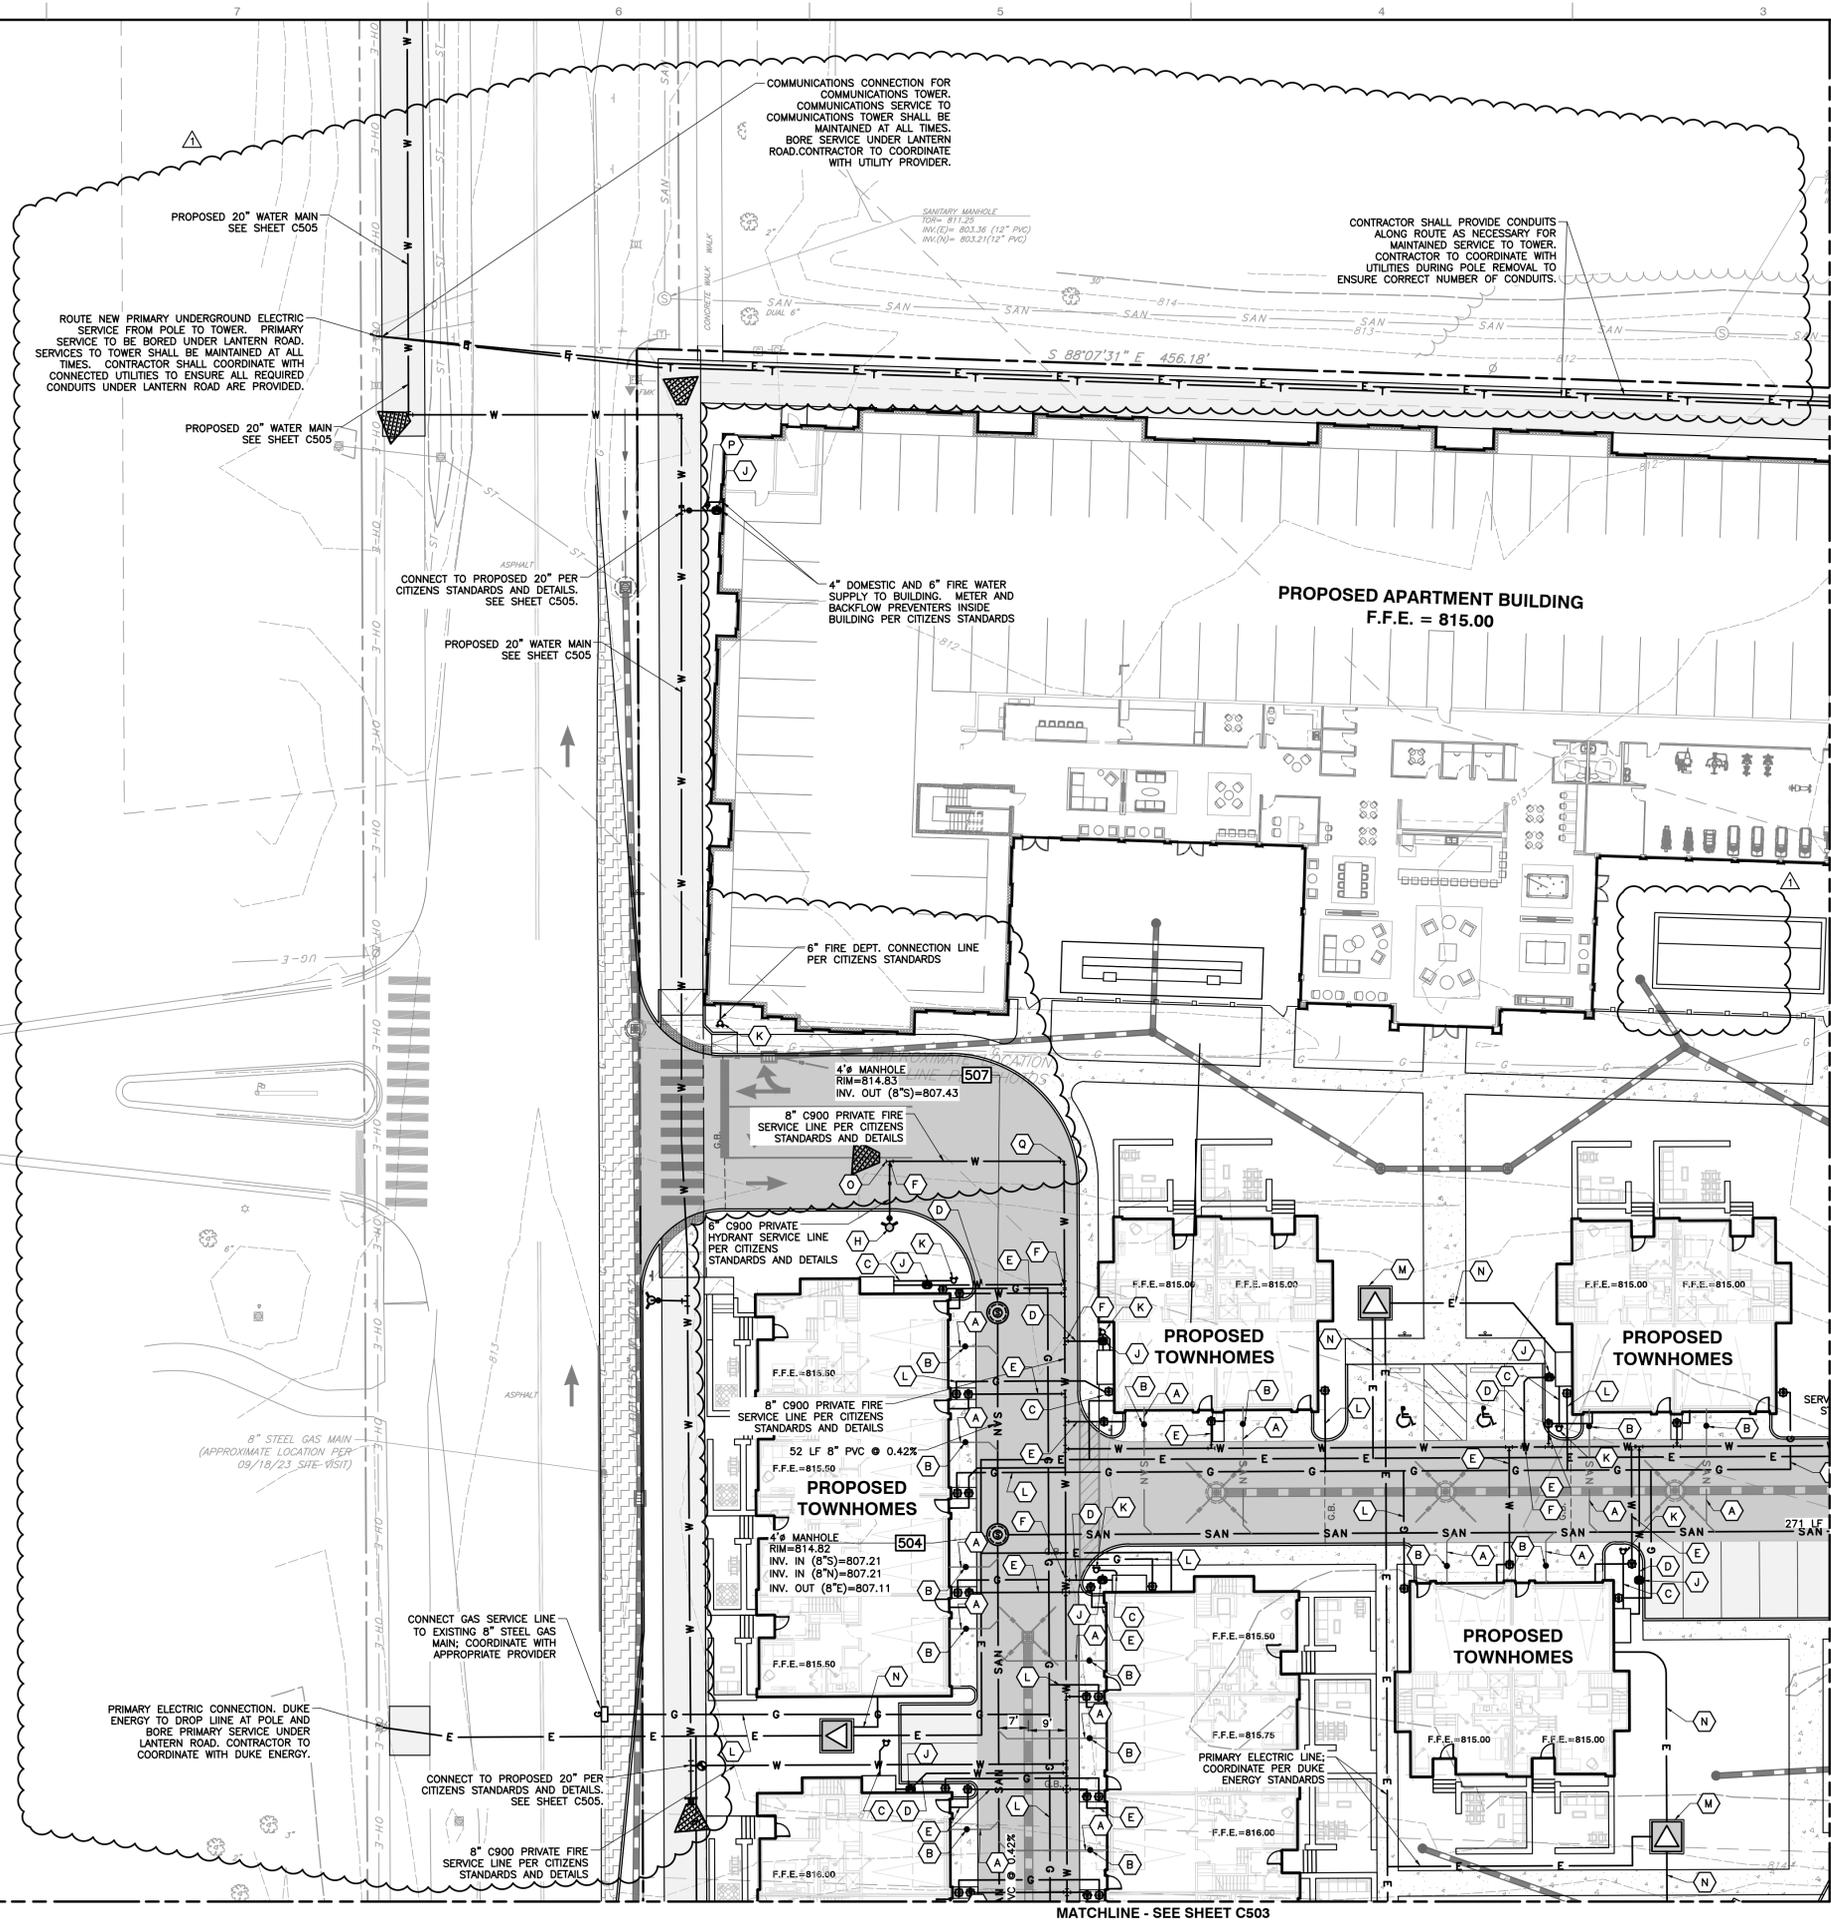


**REVISION RECORD**

NO.	DATE	DESCRIPTION
1	03/28/24	ISSUED FOR PERMIT

DATE:	DWG. SCALE:	DATE:	DRAWN BY:	BEB
FEB. 25, 2024	1" = 20'	CHECKED BY:	KPG	
		APPROVED BY:	323-947	DRAFT





- REFERENCES AND NOTES:**
- BOUNDARY RETRACEMENT AND TOPOGRAPHIC SURVEY PROVIDED BY CIVIL & ENVIRONMENTAL CONSULTANTS, INC. SURVEY DATED 08/19/2022, PROJECT NO. 323-947. 1' CONTOUR INTERVAL.
  - AERIAL IMAGERY SHOWN ON PLANS GENERATED FROM GOOGLE EARTH.
  - FISHERS STANDARD CONSTRUCTION DETAILS AMENDED JANUARY 2022. <https://www.fishers.in.us/390/DESIGN-STANDARDS-SPECS>
  - OFFSITE TOPOGRAPHY AND SURFACE INFORMATION REFERENCED FROM HAMILTON COUNTY GIS DATA PORTAL. <https://gis1.hamiltoncounty.in.gov/portal/home/>
  - SEE SHEET C001 FOR GENERAL NOTES AND SHEET SPECIFIC NOTES.
  - CONTRACTOR SHALL REFER TO OTHER PLANS WITHIN THIS CONSTRUCTION SET FOR OTHER PERTINENT INFORMATION. IT IS NOT THE ENGINEER'S INTENT THAT ANY SINGLE PLAN SHEET IN THE SET OF DOCUMENTS FULLY DEPICT ALL WORK ASSOCIATED WITH THE PROJECT.
  - ALL WATER MAIN EXTENSION, VALVES, TEES, SERVICE LINES, AND WATER METERS TO BE INSTALLED PER CITIZENS ENERGY GROUP STANDARDS.
  - CONSTRUCTION OF SANITARY SEWER TO BE PER CITY OF FISHERS MOST UP-TO-DATE DETAIL AND SPECIFICATIONS.
  - REFER TO SEWER PROFILE SHEETS FOR ALL UTILITY CROSSING LOCATIONS.
  - REFER TO SHEETS C501, C502, AND C503 FOR ADDITIONAL UTILITY PLAN NOTES.

- UTILITY LEGEND:**
- PROPOSED STORM SEWER LINE
  - PROPOSED SANITARY LINE
  - PROPOSED ELECTRIC LINE
  - PROPOSED TELEPHONE LINE
  - PROPOSED FIBER OPTIC LINE
  - PROPOSED GAS LINE
  - PROPOSED WATER LINE
  - PROPOSED OVERHEAD UTILITY LINE
  - PROPOSED CONDUIT
  - PROPOSED LIGHT POLE
  - PROPOSED WALL MOUNTED FDC, HYDRANT, WALL PIV, WATER VALVE, FREE STANDING FDC
  - PROPOSED SANITARY MANHOLE, CLEAN OUT
  - PROPOSED ELECTRIC TRANSFORMER
  - PROPOSED 1" DOMESTIC WATER METER PER CITIZENS STANDARDS AND DETAILS
  - PROPOSED GAS METER PER CENTERPOINT ENERGY STANDARDS AND DETAILS

- UTILITY KEY NOTES:**
- \*FSCD\* = FISHERS STANDARD CONSTRUCTION DETAILS
- 6" SDR-35 SANITARY LATERAL @ 1.04% MIN SLOPE. TRACER WIRE REQUIRED ON ALL SANITARY LATERALS PER FSCD SHEET 21. SEE PLAN FOR LENGTH.
  - BUILDING CLEANOUT-TYPE 2 PER FSCD SHEET 21
  - 6" FIRE DEPARTMENT CONNECTION LINE PER CITIZENS STANDARDS AND DETAILS
  - 6" PRIVATE FIRE SERVICE LINE PER CITIZENS STANDARDS
  - 1" DR9 POLY WATER SERVICE PER CITIZENS STANDARDS. PROVIDE TRACER WIRE PER CEG STANDARDS. 8.19' PROVIDE 8"x8"x1" TEE AND VALVE AT INTERNAL WATER MAIN CONNECTION
  - 8"x8"x6" TEE AND GATE VALVE
  - 8"x8"x8" TEE
  - PROPOSED PRIVATE FIRE HYDRANT WITH GATE VALVE PER CITIZENS STANDARDS AND DETAILS
  - 8"x8"x8"x8" FITTING
  - POST INDICATOR VALVE (P.I.V.) PER CITIZENS STANDARDS AND DETAILS
  - FIRE DEPARTMENT CONNECTION (F.D.C.) PER CITIZENS STANDARDS AND DETAILS
  - GAS SERVICE LINE; COORDINATE WITH CENTERPOINT ENERGY
  - ELECTRIC TRANSFORMER PER DUKE ENERGY. CONTRACTOR TO PROVIDE PAD PER DUKE STANDARD DETAILS.
  - SECONDARY ELECTRIC SERVICE TO METER; COORDINATE WITH DUKE ENERGY
  - STUB AND BLOW-OFF END OF PRIVATE C900 FIRE LINE PER CITIZENS STANDARDS AND DETAILS
  - 6"x6"x4" TEE AND GATE VALVE
  - 8" LONG BEND

REVISION RECORD	
NO.	DATE
1	03/08/24

530 E. Ohio Street  
Suite G  
Indianapolis, IN 46204  
Ph: 317.655.7777  
www.cecinc.com

**Civil & Environmental Consultants, Inc.**


**STUDIO M ARCHITECTS**  
CITYWALK ON THE NICKEL PLATE TRAIL  
LANTERN ROAD AND CIRCLE DRIVE  
FISHERS, INDIANA 46038

UTILITY PLAN	
DATE:	FEB 25, 2024
DWG SCALE:	1" = 20'
PROJECT NO.:	323-947
APPROVED BY:	
BEB	KPG
DRAFT	DRAFT



**DRAFT**


**C501**

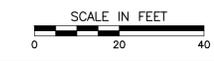

A:\130-2001\1301-9471-C000\1301-9471-C000\1301-9471-C000.dwg (1/27/2024 4:01 PM) - L:\130-2001\1301-9471-C000\1301-9471-C000.dwg (1/27/2024 4:01 PM)



CONTRACTOR SHALL PROVIDE CONDUITS ALONG ROUTE AS NECESSARY FOR MAINTAINED SERVICE TO TOWER. CONTRACTOR TO COORDINATE WITH UTILITIES. DURING POLE REMOVE TO ENSURE CORRECT NUMBER OF CONDUITS.

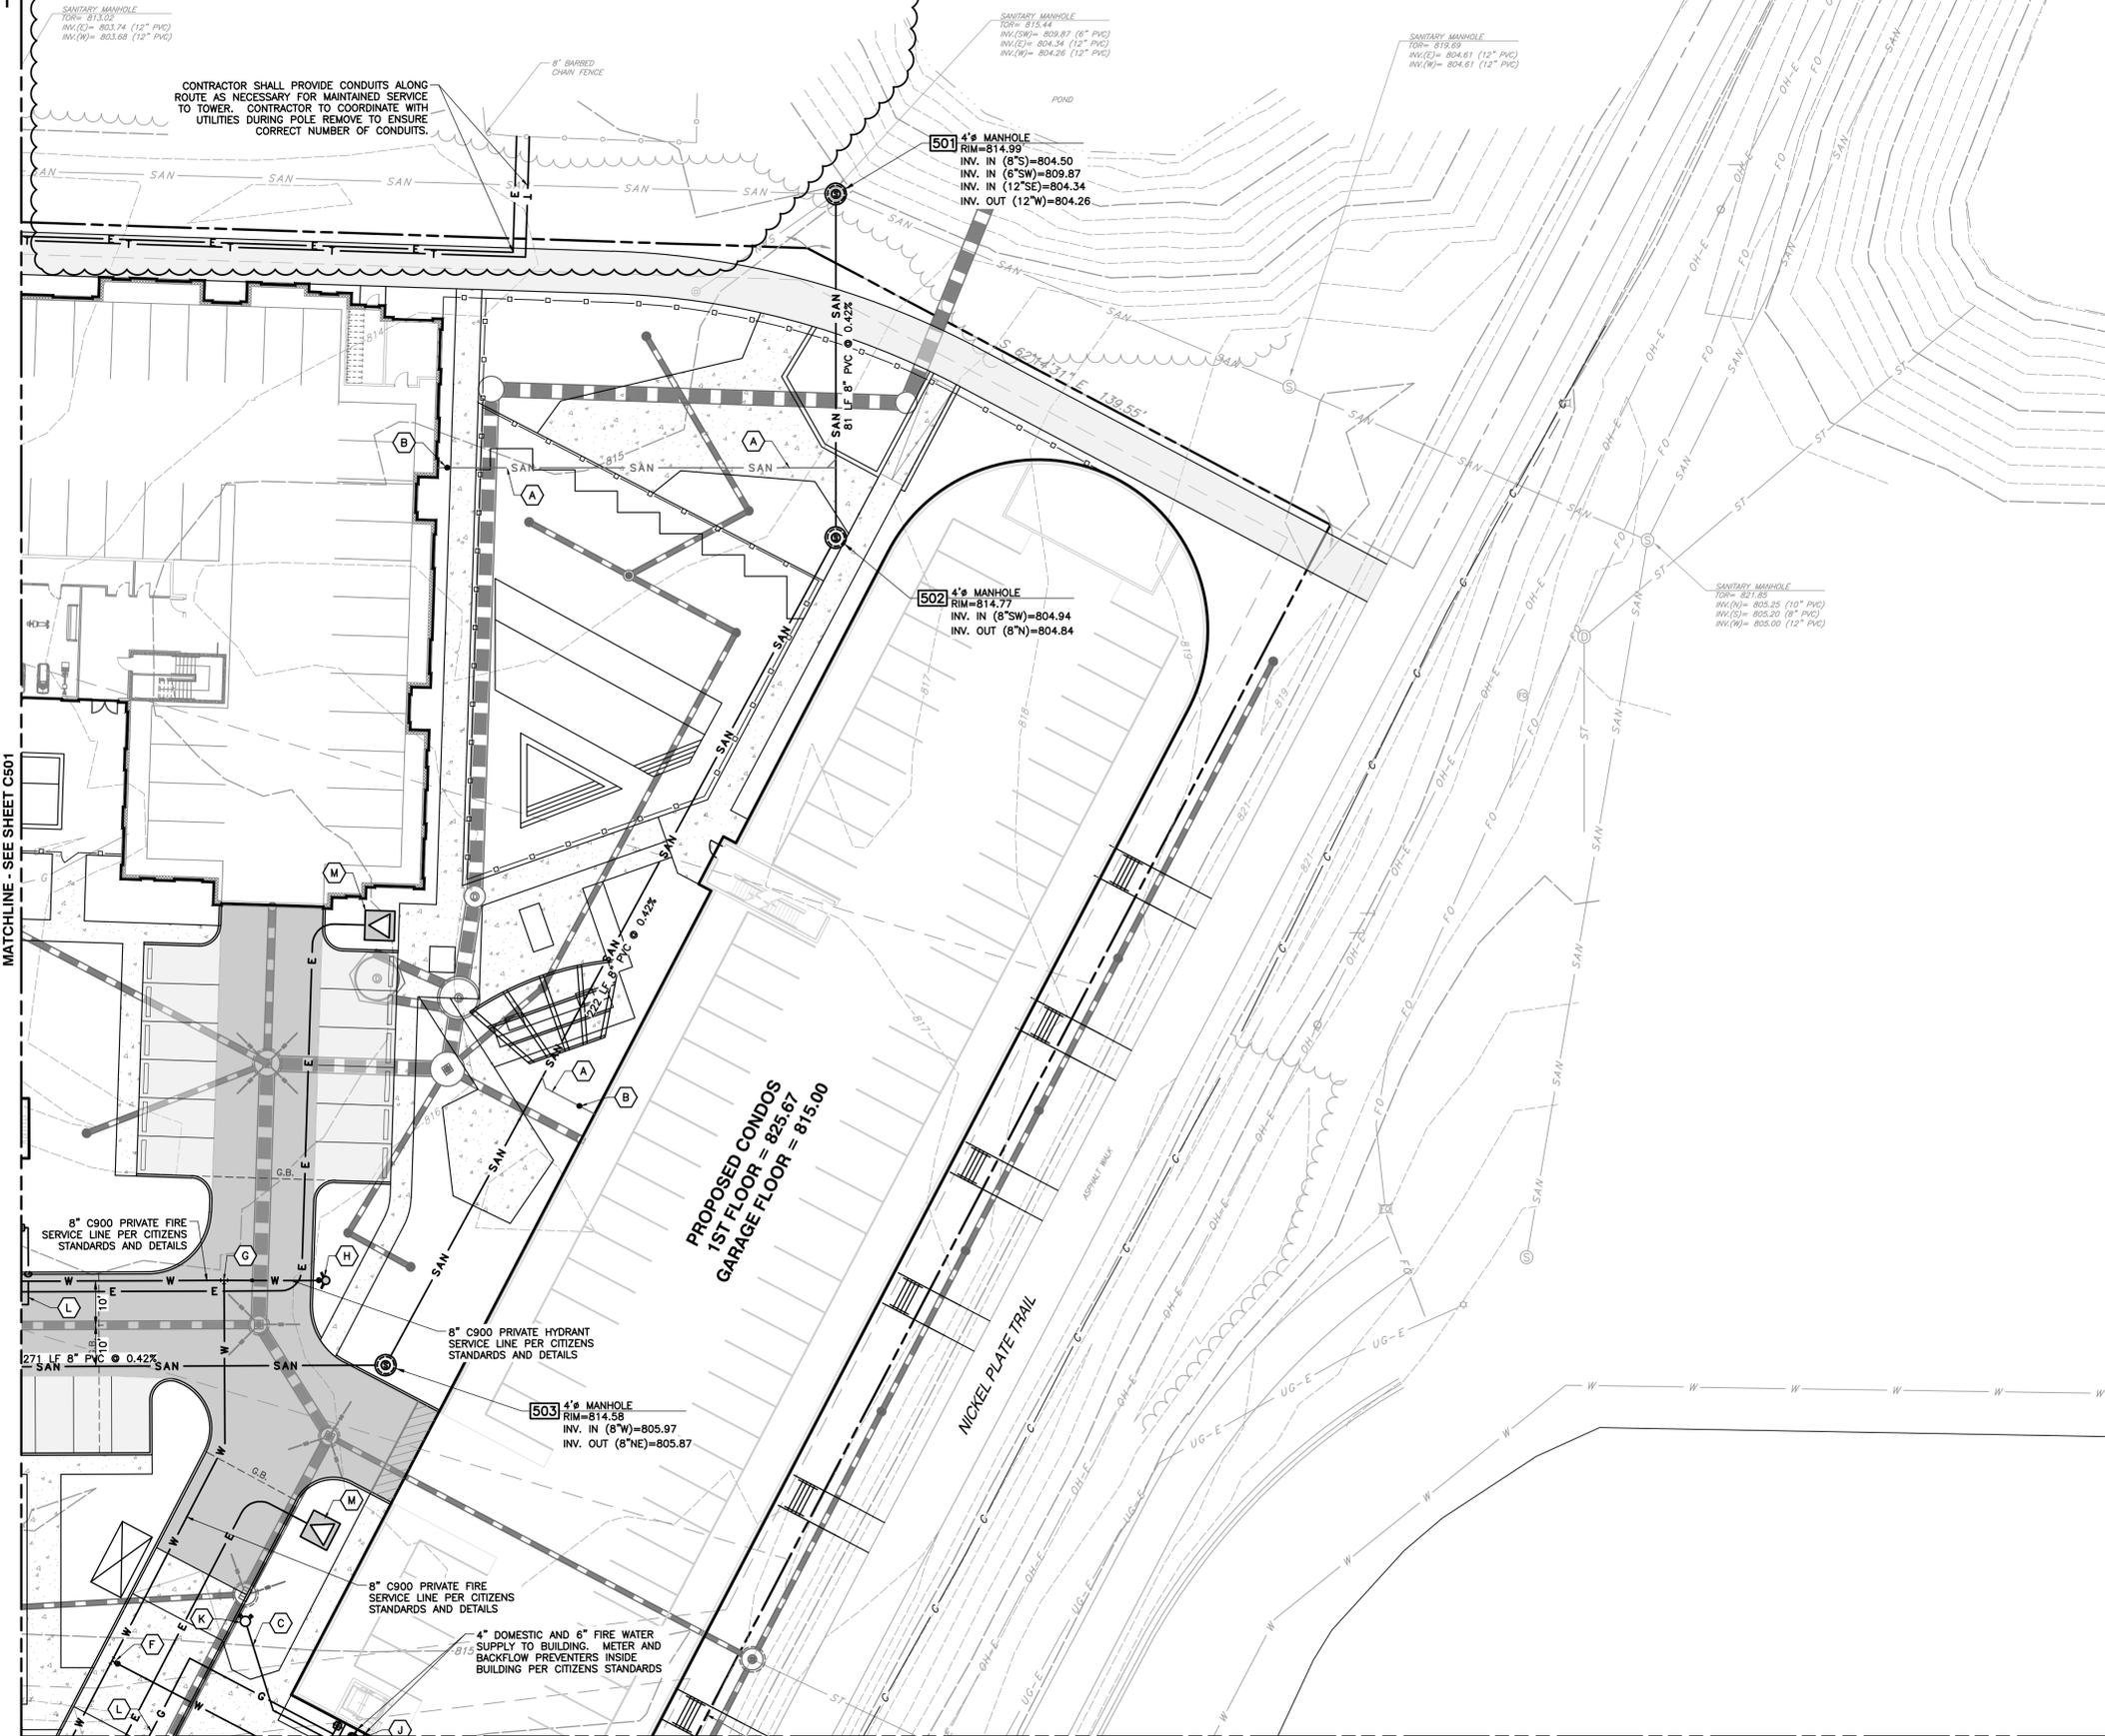

- REFERENCES AND NOTES:**
- BOUNDARY RETRACEMENT AND TOPOGRAPHIC SURVEY PROVIDED BY CIVIL & ENVIRONMENTAL CONSULTANTS, INC. SURVEY DATED 08/19/2022, PROJECT NO. 323-947. 1" CONTOUR INTERVAL.
  - AERIAL IMAGERY SHOWN ON PLANS GENERATED FROM GOOGLE EARTH.
  - FISHERS STANDARD CONSTRUCTION DETAILS AMENDED JANUARY 2022. [HTTPS://WWW.FISHERS.IN.US/390/DESIGN-STANDARDS-SPECS](https://www.fishers.in.us/390/DESIGN-STANDARDS-SPECS)
  - OFFSITE TOPOGRAPHY AND SURFACE INFORMATION REFERENCED FROM HAMILTON COUNTY GIS DATA PORTAL. [HTTPS://GIS1.HAMILTONCOUNTY.IN.GOV/PORTAL/HOME/](https://gis1.hamiltoncounty.in.gov/PORTAL/HOME/)
  - SEE SHEET C001 FOR GENERAL NOTES AND SHEET SPECIFIC NOTES.
  - CONTRACTOR SHALL REFER TO OTHER PLANS WITHIN THIS CONSTRUCTION SET FOR OTHER PERTINENT INFORMATION. IT IS NOT THE ENGINEER'S INTENT THAT ANY SINGLE PLAN SHEET IN THE SET OF DOCUMENTS FULLY DEPICT ALL WORK ASSOCIATED WITH THE PROJECT.
  - ALL WATER MAIN EXTENSION, VALVES, TEES, SERVICE LINES, AND WATER METERS TO BE INSTALLED PER CITIZENS ENERGY GROUP STANDARDS.
  - CONSTRUCTION OF SANITARY SEWER TO BE PER CITY OF FISHERS MOST UP-TO-DATE DETAIL AND SPECIFICATIONS.
  - REFER TO SEWER PROFILE SHEETS FOR ALL UTILITY CROSSING LOCATIONS.
  - REFER TO SHEETS C501, C502, AND C503 FOR ADDITIONAL UTILITY PLAN NOTES.

- UTILITY LEGEND:**
- PROPOSED STORM SEWER LINE
  - PROPOSED SANITARY LINE
  - PROPOSED TELEPHONE LINE
  - PROPOSED FIBER OPTIC LINE
  - PROPOSED GAS LINE
  - PROPOSED WATER LINE
  - PROPOSED OVERHEAD UTILITY LINE
  - PROPOSED CONDUIT
  - PROPOSED LIGHT POLE
  - PROPOSED WALL MOUNTED FDC, HYDRANT, WALL PIV, WATER VALVE, FREE STANDING FDC
  - PROPOSED SANITARY MANHOLE, CLEAN OUT
  - PROPOSED ELECTRIC TRANSFORMER
  - PROPOSED 1" DOMESTIC WATER METER PER CITIZENS STANDARDS AND DETAILS
  - PROPOSED GAS METER PER CENTERPOINT ENERGY STANDARDS AND DETAILS

- UTILITY KEY NOTES:**
- \*FSCD\* = FISHERS STANDARD CONSTRUCTION DETAILS
- 6" SDR-35 SANITARY LATERAL @ 1.04% MIN SLOPE. TRACER WIRE REQUIRED ON ALL SANITARY LATERALS PER FSCD SHEET 21. SEE PLAN FOR LENGTH.
  - BUILDING CLEANOUT-TYPE 2 PER FSCD SHEET 21
  - 6" FIRE DEPARTMENT CONNECTION LINE PER CITIZENS STANDARDS AND DETAILS
  - 6" PRIVATE FIRE SERVICE LINE PER CITIZENS STANDARDS
  - 1" DR9 POLY WATER SERVICE PER CITIZENS STANDARDS. PROVIDE TRACER WIRE PER CEG STANDARDS. 8"X8" TEE AND VALVE AT INTERNAL WATER MAIN CONNECTION
  - 8"X8" TEE AND GATE VALVE
  - 8"X8" TEE
  - PROPOSED PRIVATE FIRE HYDRANT WITH GATE VALVE PER CITIZENS STANDARDS AND DETAILS
  - 8"X8"X8" FITTING
  - POST INDICATOR VALVE (P.I.V.) PER CITIZENS STANDARDS AND DETAILS
  - FIRE DEPARTMENT CONNECTION (F.D.C.) PER CITIZENS STANDARDS AND DETAILS
  - GAS SERVICE LINE; COORDINATE WITH CENTERPOINT ENERGY
  - ELECTRIC TRANSFORMER PER DUKE ENERGY. CONTRACTOR TO PROVIDE PAD PER DUKE STANDARD DETAILS.
  - SECONDARY ELECTRIC SERVICE TO METER; COORDINATE WITH DUKE ENERGY
  - STUB AND BLOW-OFF END OF PRIVATE C900 FIRE LINE PER CITIZENS STANDARDS AND DETAILS
  - 6"X6"X4" TEE AND GATE VALVE
  - 8" LONG BEND

NO.	DATE	DESCRIPTION
1	03/08/24	ADDendum #1

530 E. Ohio Street  
Suite G  
Indianapolis, IN 46204  
Ph: 317.655.7777  
www.cecinc.com

**Civil & Environmental Consultants, Inc.**

**STUDIO M ARCHITECTS**  
CITYWALK ON THE NICKEL PLATE TRAIL  
LANERN ROAD AND CIRCLE DRIVE  
FISHERS, INDIANA 46038

DATE:	DRAWN BY:	BEB
FEB 25, 2024	[Signature]	KPG
DWG SCALE:	CHECKED BY:	323-947
1" = 20'	[Signature]	DRAFT



**DRAFT**

UTILITY PLAN  
SCALE IN FEET  
0 20 40


A:\130-001\1301-947-0001\001\002 Construction Plans\1301947-002-C500.mxd\0501 LS1\1/8/2024 4:02 PM






A	B	C	D
10"	8"	8.00	9.00
12"	8"	12.00	9.00
12"	10"	8.50	10.00
15"	8"	13.50	9.00
15"	10"	12.50	10.00
18"	8"	22.50	9.00
18"	10"	19.40	10.00
18"	12"	13.50	11.50
18"	15"	7.00	
24"	8"	30.50	9.00
24"	10"	30.50	10.00
24"	12"	24.50	11.00
24"	15"	18.00	12.00
30"	8"	45.50	9.00
30"	10"	40.50	10.00
30"	12"	34.50	11.50
30"	15"	28.00	12.00
30"	18"	21.00	14.50
30"	24"	13.50	

**CONE STYLE REDUCER**

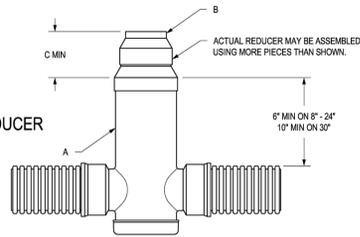


**CAP STYLE REDUCER**

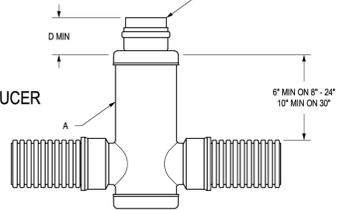

NOTE: DIMENSIONS ARE FOR REFERENCE ONLY  
ACTUAL DIMENSIONS MAY VARY


<p>THIS PRINT DISCLOSES SUBJECT MATTER IN WHICH NYLOPLAST HAS PROPRIETARY RIGHTS. THE RECEIPT OR POSSESSION OF THIS PRINT DOES NOT CONFER, TRANSFER, OR LICENSE THE USE OF THE DESIGN OR TECHNICAL INFORMATION SHOWN HEREIN. REPRODUCTION OF THIS PRINT OR ANY INFORMATION CONTAINED HEREIN, OR MANUFACTURE OF ANY ARTICLE HEREFROM, FOR THE DISCLOSURE TO OTHERS IS FORBIDDEN, EXCEPT BY SPECIFIC WRITTEN PERMISSION FROM NYLOPLAST.</p>	<p>DRAWN BY: CJA DATE: 2-6-03 REVISOR: JJC DATE: 7-16-13 DWG SIZE: A SCALE: 1:25 SHEET: 1 OF 1</p>	<p>MATERIAL: DUCTILE IRON</p>	<p>3130 VERONA AVE BURLINGTON, GA 30618 PHN (770) 932-2443 FAX (770) 932-2490 www.nyloplast-us.com</p>	<p>118 IN PEDESTRIAN GRATE ASSEMBLY - TYPE C DWG NO. 7001-118-212 REV. D</p>
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**NYLOPLAST DRAIN BASIN WITH PEDESTRIAN GRATE**

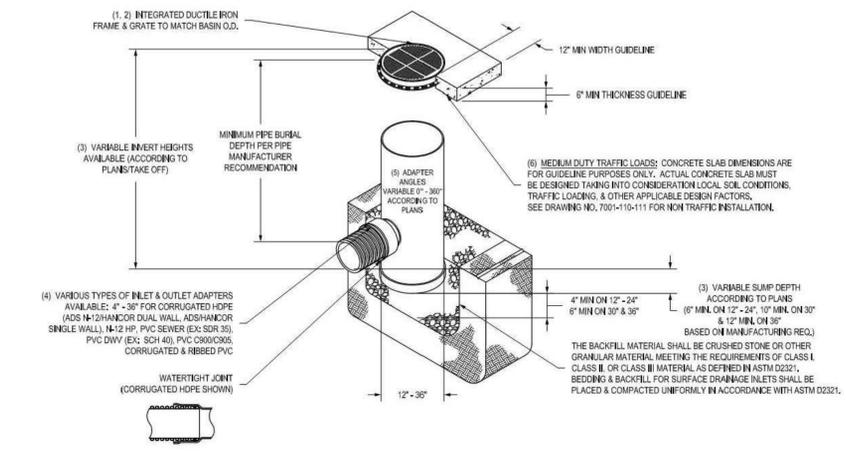

<p>THIS PRINT DISCLOSES SUBJECT MATTER IN WHICH NYLOPLAST HAS PROPRIETARY RIGHTS. THE RECEIPT OR POSSESSION OF THIS PRINT DOES NOT CONFER, TRANSFER, OR LICENSE THE USE OF THE DESIGN OR TECHNICAL INFORMATION SHOWN HEREIN. REPRODUCTION OF THIS PRINT OR ANY INFORMATION CONTAINED HEREIN, OR MANUFACTURE OF ANY ARTICLE HEREFROM, FOR THE DISCLOSURE TO OTHERS IS FORBIDDEN, EXCEPT BY SPECIFIC WRITTEN PERMISSION FROM NYLOPLAST.</p>	<p>DRAWN BY: EBC DATE: 04-24-07 REVISOR: NMM DATE: 06-12-13 DWG SIZE: A SCALE: 1:40 SHEET: 1 OF 1</p>	<p>MATERIAL: PVC</p>	<p>3130 VERONA AVE BURLINGTON, GA 30618 PHN (770) 932-2443 FAX (770) 932-2490 www.nyloplast-us.com</p>	<p>DRAIN BASIN WITH PEDESTRIAN GRATE CHECK SPEC INSTALLATION DETAIL DWG NO. 7001-118-203 REV. E</p>
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**NYLOPLAST INLINE DRAIN WITH SOLID COVER**




<p>THIS PRINT DISCLOSES SUBJECT MATTER IN WHICH NYLOPLAST HAS PROPRIETARY RIGHTS. THE RECEIPT OR POSSESSION OF THIS PRINT DOES NOT CONFER, TRANSFER, OR LICENSE THE USE OF THE DESIGN OR TECHNICAL INFORMATION SHOWN HEREIN. REPRODUCTION OF THIS PRINT OR ANY INFORMATION CONTAINED HEREIN, OR MANUFACTURE OF ANY ARTICLE HEREFROM, FOR THE DISCLOSURE TO OTHERS IS FORBIDDEN, EXCEPT BY SPECIFIC WRITTEN PERMISSION FROM NYLOPLAST.</p>	<p>DRAWN BY: EBC DATE: 03-23-03 REVISOR: NMM DATE: 03-15-16 DWG SIZE: A SCALE: 1:40 SHEET: 1 OF 1</p>	<p>MATERIAL: DUCTILE IRON</p>	<p>3130 VERONA AVE BURLINGTON, GA 30618 PHN (770) 932-2443 FAX (770) 932-2490 www.nyloplast-us.com</p>	<p>INLINE DRAIN WITH SOLID COVER CHECK SPEC INSTALLATION DETAIL DWG NO. 7003-118-055 REV. C</p>
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**DETAIL 404: TYPICAL ADS NYLOPLAST DRAIN DETAILS**

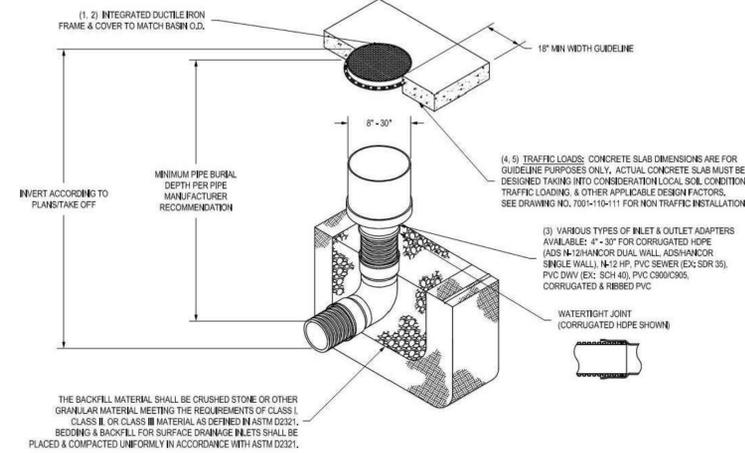NOT TO SCALE

**1899CGP**


APPROX. DRAIN AREA = 87.29 SQ IN  
APPROX. WEIGHT WITH FRAME = 60.75 LBS

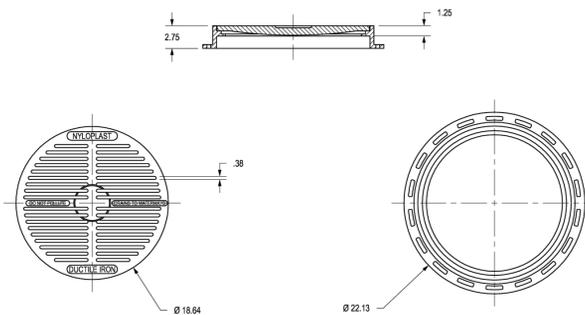

<p>THIS PRINT DISCLOSES SUBJECT MATTER IN WHICH NYLOPLAST HAS PROPRIETARY RIGHTS. THE RECEIPT OR POSSESSION OF THIS PRINT DOES NOT CONFER, TRANSFER, OR LICENSE THE USE OF THE DESIGN OR TECHNICAL INFORMATION SHOWN HEREIN. REPRODUCTION OF THIS PRINT OR ANY INFORMATION CONTAINED HEREIN, OR MANUFACTURE OF ANY ARTICLE HEREFROM, FOR THE DISCLOSURE TO OTHERS IS FORBIDDEN, EXCEPT BY SPECIFIC WRITTEN PERMISSION FROM NYLOPLAST.</p>	<p>DRAWN BY: EBC DATE: 03-07-06 REVISOR: CCA DATE: 08-30-13 DWG SIZE: A SCALE: 1:16 SHEET: 1 OF 1</p>	<p>MATERIAL: DUCTILE IRON</p>	<p>3130 VERONA AVE BURLINGTON, GA 30618 PHN (770) 932-2443 FAX (770) 932-2490 www.nyloplast-us.com</p>	<p>18 IN PEDESTRIAN GRATE ASSEMBLY - TYPE C DWG NO. 7001-118-212 REV. D</p>
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**1299CGP**


APPROX. DRAIN AREA = 50.69 SQ IN  
APPROX. WEIGHT WITH FRAME = 35.04 LBS

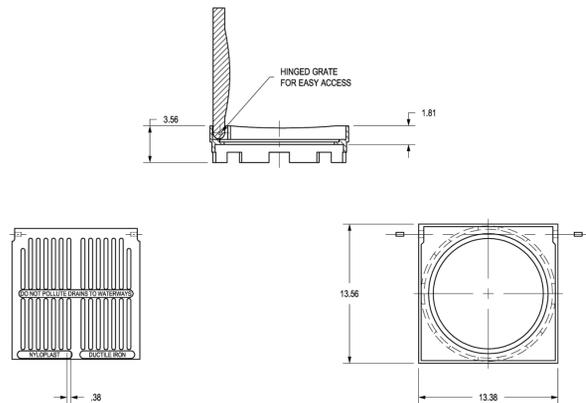

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**1599CGD**

APPROX. DRAIN AREA = 122.07 SQ IN  
APPROX. WEIGHT = 26.50 LBS

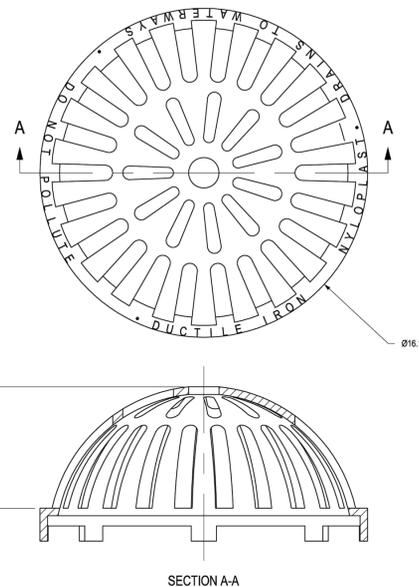

DIMENSIONS ARE FOR REFERENCE ONLY  
ACTUAL DIMENSIONS MAY VARY  
DIMENSIONS ARE IN INCHES  
QUALITY: MATERIALS SHALL CONFORM TO ASTM A536 GRADE 70-50-05  
PAINT: CASTINGS ARE FURNISHED WITH A BLACK PAINT  
LOCKING DEVICE AVAILABLE UPON REQUEST

<p>THIS PRINT DISCLOSES SUBJECT MATTER IN WHICH NYLOPLAST HAS PROPRIETARY RIGHTS. THE RECEIPT OR POSSESSION OF THIS PRINT DOES NOT CONFER, TRANSFER, OR LICENSE THE USE OF THE DESIGN OR TECHNICAL INFORMATION SHOWN HEREIN. REPRODUCTION OF THIS PRINT OR ANY INFORMATION CONTAINED HEREIN, OR MANUFACTURE OF ANY ARTICLE HEREFROM, FOR THE DISCLOSURE TO OTHERS IS FORBIDDEN, EXCEPT BY SPECIFIC WRITTEN PERMISSION FROM NYLOPLAST.</p>	<p>DRAWN BY: EBC DATE: 03-07-06 REVISOR: CCA DATE: 08-30-13 DWG SIZE: A SCALE: 1:4 SHEET: 1 OF 1</p>	<p>MATERIAL: DUCTILE IRON</p>	<p>3130 VERONA AVE BURLINGTON, GA 30618 PHN (770) 932-2443 FAX (770) 932-2490 www.nyloplast-us.com</p>	<p>15 IN DOME GRATE DWG NO. 7001-118-211 REV. E</p>
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**DETAIL 405: TYPICAL ADS NYLOPLAST GRATE DETAILS**

NOT TO SCALE

REVISION RECORD	
NO.	DATE
1	03/28/04

530 E. Ohio Street  
Suite G  
Indianapolis, IN 46204  
Ph: 317.655.7777  
www.cecinco.com















**STUDIO M ARCHITECTS**  
CITYWALK ON THE NICKEL PLATE TRAIL  
LANTERN ROAD AND CIRCLE DRIVE  
FISHERS, INDIANA 46038

<p>DATE: FEB 25, 2024 DWG SCALE: AS NOTED PROJECT NO: 323-947</p>	<p>DRAWN BY: KPB CHECKED BY: KPB APPROVED BY: DRAFT</p>
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**DRAFT**

DRAWING NO. **C802**

A:\200-2001\2024-9471-C800\DWG\DWG\C800-Citizen Water Meter Details.dwg (2/25/2024 - 4:02 PM) - dwg - 1/8/2024 4:02 PM

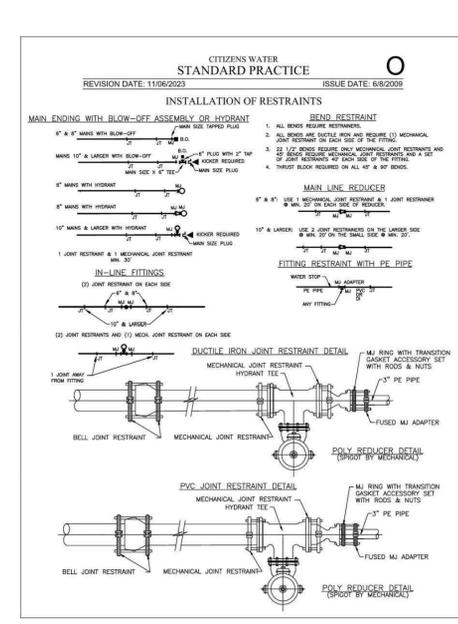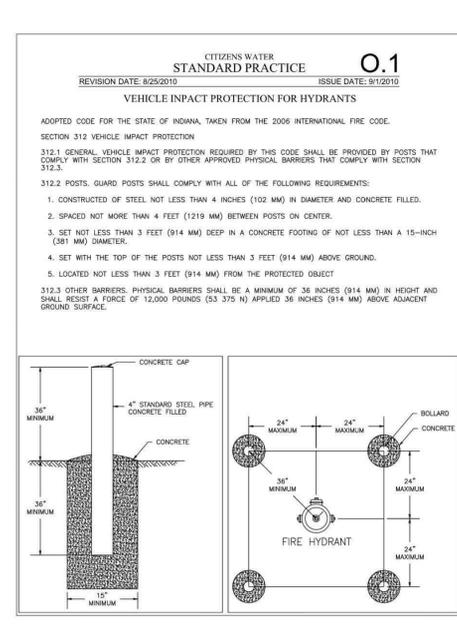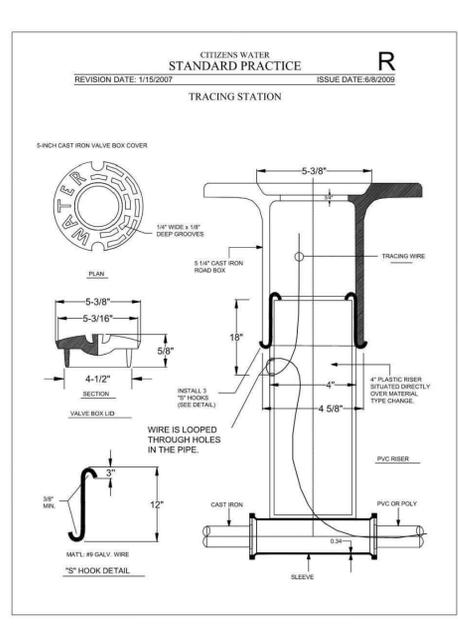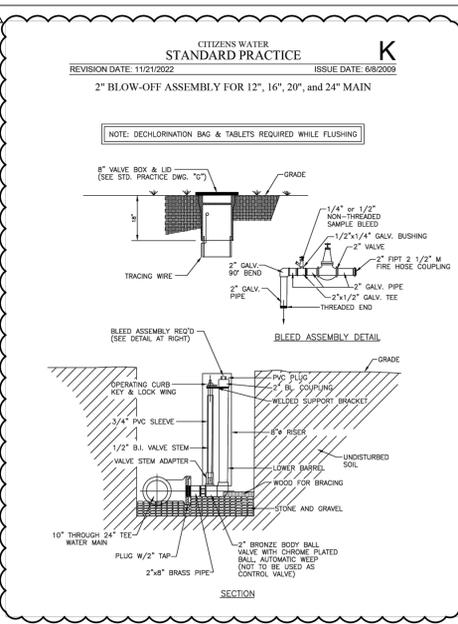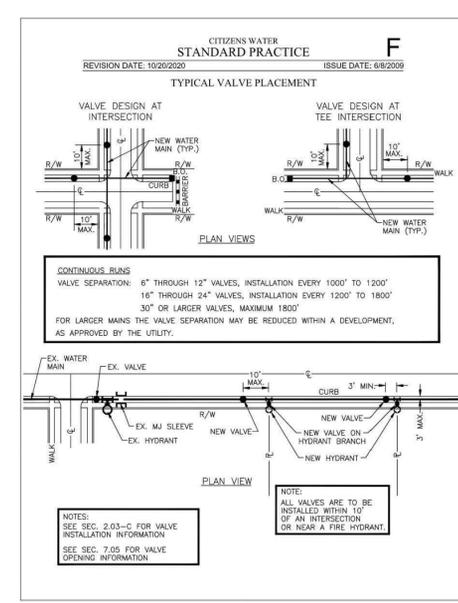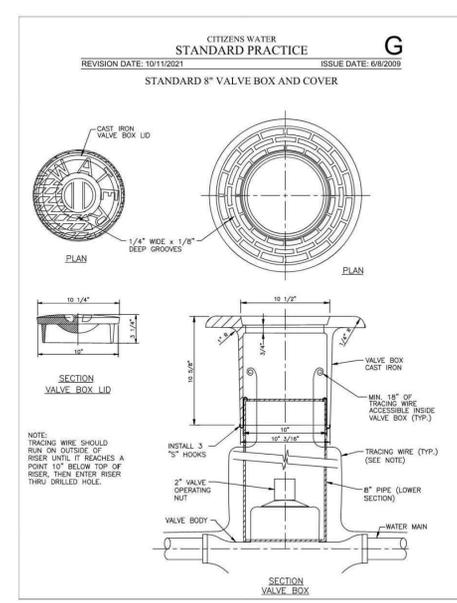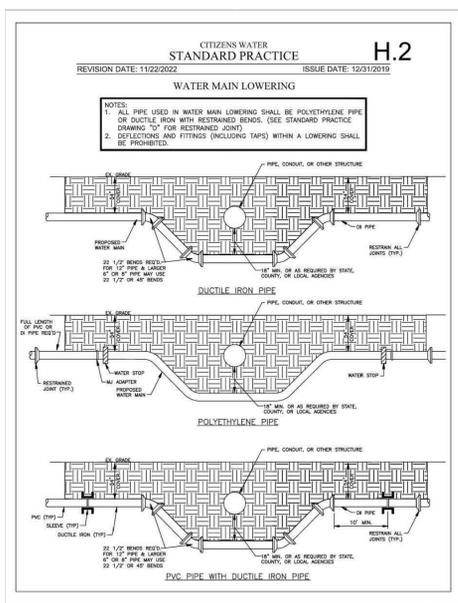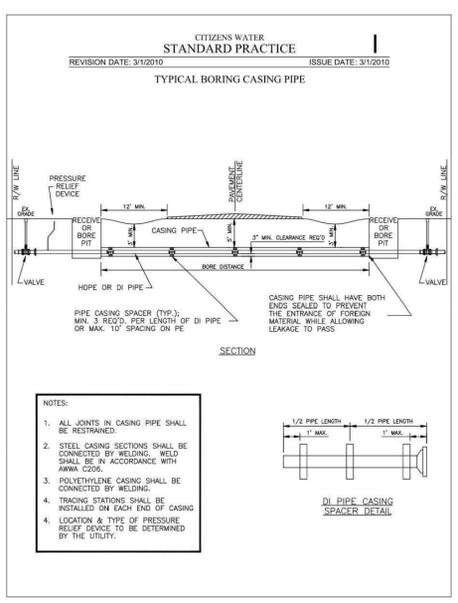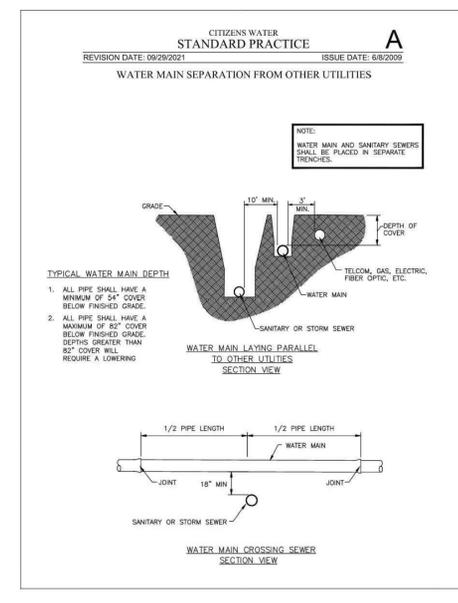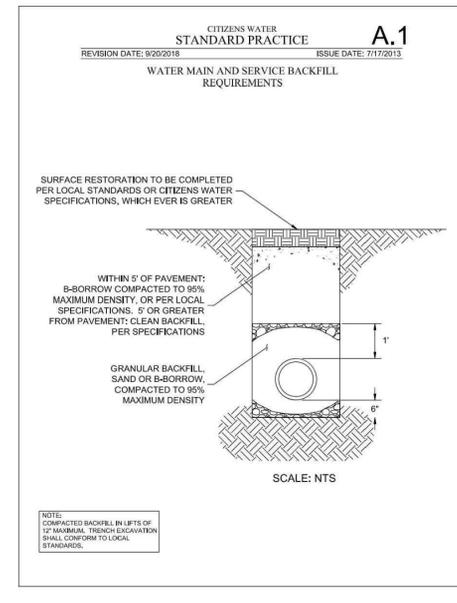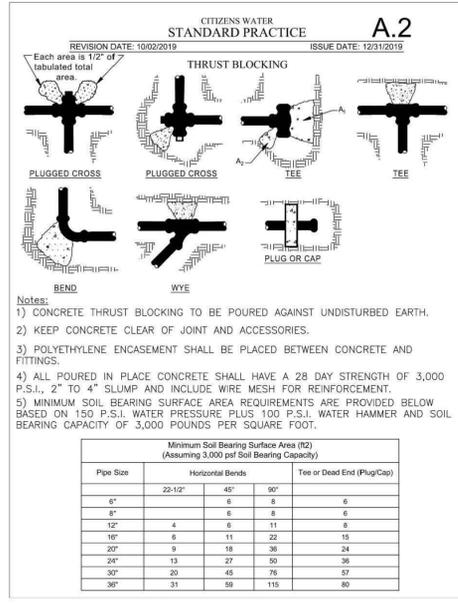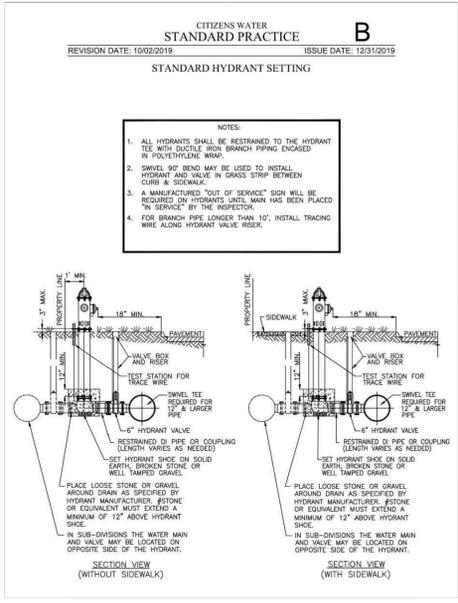

DRAFT

**STUDIO M ARCHITECTS**  
 CITYWALK ON THE NICKEL PLATE TRAIL  
 LANTERN ROAD AND CIRCLE DRIVE  
 FISHERS, INDIANA 46038

530 E. Ohio Street  
 Suite G  
 Indianapolis, IN 46204  
 Ph: 317.655.7777  
 www.cecinco.com

**WATER MAIN DETAILS**  
 DATE: FEB. 25, 2024 DRAWN BY: JCB  
 DWG SCALE: AS NOTED CHECKED BY: KPG  
 PROJECT NO: 323-947  
 APPROVED BY: DRAFT

C805

DOCUMENT 001113 - ADVERTISEMENT FOR BIDS

1.1 PROJECT INFORMATION

- A. Notice to Bidders: Bidders may submit bids for project as described in this Document. Submit bids according to the Instructions to Bidders.
- B. Project Identification: Citywalk on The Nickel Plate Trail.
  - 1. Project Location: Lantern Road and Circle Drive, Fishers, Indiana, 46038, United States.
- C. Owner: Citywalk Development LLC.
  - 1. Owner's Representative: Hossam Wanas, wanas@citywalkfishers.com .
- D. Architect: Studio M Architecture. Dan Moriarity dmoriarity@studiomarchitecture.net
- E. Construction Manager: Citibld, LLC. Contact Francois Mercho, francois@citywalkfishers.com .
- F. Developer: Wanas Group, LLC. Hossam Wanas, wanas@citywalkfishers.com .
- G. Project Description: Project consists of 14 buildings and associated sitework along the Nickel Plate Train in Fishers, IN. Uses include apartments, parking, condominiums, for sale townhomes, and associated amenities. .
- H. Construction Contract: Bids will be received for the following Work:
  - 1. Multiple Contract Project consisting of, but not necessarily limited to, the following prime contracts:
    - a. Sitework as represented in the documents prepared by Civil and Environmental Consultants Inc. dated 2/23/2024 and this Project Manual dated 3/4/2024.
    - b. General Building Construction.
    - c. Plumbing Construction.
    - d. Mechanical Construction.
    - e. Electrical Construction.
    - f. Landscaping and Site Amenities .

1.2 BID SUBMITTAL AND OPENING

- A. Owner will receive sealed lump sum bids until the bid time and date at the location given below. Owner will consider bids prepared in compliance with the Instructions to Bidders issued by Owner, and delivered as follows:
  - 1. **Bid Date: March 27, 2024 at 2:00 PM .**
  - 2. **Location: Studio M Architecture and Planning , 275 Veterans Way, Suite 200 , Carmel, IN 46032 . Bids may be submitted electronically to dmoriarity@studiomarchitecture.net.**
  - 3. **The link to the drawings and specs is [https://distribution.easternengineering.com/View/ViewJobList.aspx?group\\_id=private\\_all](https://distribution.easternengineering.com/View/ViewJobList.aspx?group_id=private_all). This is the "private" side of the Eastern Engineering Plan Room. The password is all lower case "citywalk".**
  - 4. **The current bid set asks for a complete bid for the civil portion of the project. If you wish, you can submit a number for only those categories that for which you have expertise.**
  - 5. **The owners have also relaxed the date to start construction. Please include in your bid when you can start work if you are selected.**
- B. All questions during the bid phase should be submitted to Dan Moriarity at Studio M Architecture and Planning in writing by March 25th at 5:00 PM. Dan will distribute answers to all bidders registered with the Eastern Engineering Plan Room at [https://distribution.easternengineering.com/view/viewjoblist.aspx?group\\_id=private\\_all](https://distribution.easternengineering.com/view/viewjoblist.aspx?group_id=private_all). Invited bidders will receive a link and password for access.

1.3 DOCUMENTS

- A. Online Procurement and Contracting Documents: Obtain access after March 3, 2024 , by contacting Eastern Engineering Plan Room, Private projects . Online access will be provided to prime bidders only.

1.4 TIME OF COMPLETION

- A. Successful bidder shall begin the Work on receipt of the Notice to Proceed and shall complete the Work within the Contract Time.

1.5 BIDDER'S QUALIFICATIONS

- A. Bidders must be properly licensed under the laws governing their respective trades and be able to obtain insurance and bonds required for the Work.

END OF DOCUMENT 001113

DOCUMENT 003113 - PRELIMINARY SCHEDULES

1.1 PROJECT SCHEDULE

- A. This Document with its referenced attachments is part of the Procurement and Contracting Requirements for Project. They provide Owner's information for Bidders' convenience and are intended to supplement rather than serve in lieu of Bidders' own investigations. They are made available for Bidders' convenience and information, but do not affect Contract Time requirements. This Document and its attachments are not part of the Contract Documents.
- B. Available Project information includes the following:
1. Project Schedule - The owner would like to begin construction of Bid Package 1 as soon as April of 2024 . Project documents were submitted to the City of Fishers for Approval on February 26, 2024.
  2. **The owners have relaxed the date to start construction. Please include in your bid when you can start work if you are selected.**

END OF DOCUMENT 003113

DOCUMENT 004126 - BID FORM - CONSTRUCTION MANAGEMENT (MULTIPLE-PRIME CONTRACT)

1.1 BID INFORMATION

- A. Bidder: \_\_\_\_\_.
- B. Prime Contract: Drawings and Project Manual for Bid Package #1 as prepared by CEC, Inc. and Studio M Architecture and Planning dated 2/23/2024 and 3/4/2024 respectively.
- C. Project Name: Citywalk on the Nickel Plate Trail.
- D. Project Location: Lantern Road, Fishers, Indiana, 46038, United States.
- E. Owner: Citywalk Development, LLC .
- F. Architect: Studio M Architecture and Planning, LLC.
- G. Architect Project Number: C\_22024.

1.2 CERTIFICATIONS AND BASE BID

- A. Base Bid, Bid Package #1: The undersigned Bidder, having carefully examined the Procurement and Contracting Requirements, Conditions of the Contract, Drawings, Specifications, and all subsequent Addenda, as prepared by Studio M Architecture and CEC, Inc. , having visited the site, and being familiar with all conditions and requirements of the Work, hereby agrees to furnish all material, labor, equipment and services, including all scheduled allowances, necessary to complete the construction of Bid Package #1 for above-named Project, according to the requirements of the Procurement and Contracting Documents, for the stipulated sum of:
  - 1. \_\_\_\_\_ Dollars (\$ \_\_\_\_\_).
  - 2. **Partial Bid Submissions: 1.The current bid set asks for a complete bid for the civil portion of the project. If you wish, you can submit a number for only those categories that for which you have expertise.**
  - 3. Please provide a breakdown of the cost associated with the following category of the Base Bid amount listed above:
    - a. General Conditions \_\_\_\_\_
    - b. Site Supervision \_\_\_\_\_
    - c. Fences and Gates \_\_\_\_\_
    - d. Earthwork Mobilization and Demobilization \_\_\_\_\_
    - e. On Site Sanitary Sewer \_\_\_\_\_
    - f. On Site Storm Sewer \_\_\_\_\_
    - g. Site Electrical \_\_\_\_\_
    - h. Water Main Extension (including associated SWPP and Build Back)\_\_\_\_\_
    - i. On Site Water \_\_\_\_\_
    - j. Earthwork, Grading and Drainage \_\_\_\_\_
    - k. SWPP Requirements \_\_\_\_\_
    - l. Site Concrete \_\_\_\_\_
    - m. Asphalt Paving \_\_\_\_\_
    - n. Survey and Staking \_\_\_\_\_
    - o. Material Testing \_\_\_\_\_
    - p. GC Fee \_\_\_\_\_
  - 4. Unit Prices:
    - a. Removal and haul off of unsuitable material \_\_\_\_\_per cubic yard
    - b. Import clean fill \_\_\_\_\_per cubic yard
    - c. #53 Stone delivered and placed \_\_\_\_\_per cubic yard
    - d. #2 Stone delivered and placed \_\_\_\_\_per cubic yard
    - e. #8 Stone delivered and placed \_\_\_\_\_per cubic yard
    - f. d. Labor unit rates (all stated as a cost per hour include labor burden) i. Project Executive \_\_\_\_\_ii. Senior Project Manager \_\_\_\_\_iii. Project Manager \_\_\_\_\_iv. Assistant Project Manager \_\_\_\_\_v. Senior Superintendent \_\_\_\_\_vi. Superintendent \_\_\_\_\_

1.3 TIME OF COMPLETION

- A. The undersigned Bidder proposes and agrees hereby to commence the Work of the Contract Documents on a date specified in a written Notice to Proceed to be issued by Architect, and shall fully complete the first phase that will allow foundation work, concrete forming and subsequent contractor access within \_\_\_\_\_ calendar days. Schedule for final completion of all work will be coordinated with the Construction Manager.

1.4 ACKNOWLEDGEMENT OF ADDENDA

- A. The undersigned Bidder acknowledges receipt of and use of the following Addenda in the preparation of this Bid:

1. **Addendum No. 1, dated March 12, 2024**
2. Addendum No. 2, dated \_\_\_\_\_.

1.5 SUBMISSION OF BID

- A. Respectfully submitted this \_\_\_\_ day of \_\_\_\_\_, 2024 .
- B. Submitted By: \_\_\_\_\_ (Name of bidding firm or corporation).
- C. Authorized Signature: \_\_\_\_\_ (Handwritten signature).
- D. Signed By: \_\_\_\_\_ (Type or print name).
- E. Title: \_\_\_\_\_ (Owner/Partner/President/Vice President).
- F. Witnessed By: \_\_\_\_\_ (Handwritten signature).
- G. Attest: \_\_\_\_\_ (Handwritten signature).
- H. By: \_\_\_\_\_ (Type or print name).
- I. Title: \_\_\_\_\_ (Corporate Secretary or Assistant Secretary).
- J. Street Address: \_\_\_\_\_.
- K. City, State, Zip: \_\_\_\_\_.
- L. Phone: \_\_\_\_\_.
- M. License No.: \_\_\_\_\_.
- N. Federal ID No.: \_\_\_\_\_ (Affix Corporate Seal Here).

END OF DOCUMENT 004126

## SECTION 011000 - SUMMARY

### PART 1 - GENERAL

#### 1.1 RELATED DOCUMENTS

- A. Drawings and general provisions of the Contract, including General and Supplementary Conditions and other Division 01 Specification Sections, apply to this Section.

#### 1.2 SUMMARY

- A. Section Includes:
  - 1. Project information.
  - 2. Work covered by Contract Documents.
  - 3. Phased construction.
  - 4. Multiple Work Packages.
  - 5. Work under Owner's separate contracts.
  - 6. Future work not part of this Project.
  - 7. Contractor's use of site and premises.
  - 8. Work restrictions.

#### 1.3 DEFINITIONS

- A. Work Package: A group of specifications, drawings, and schedules prepared by the design team to describe a portion of the Project Work for pricing, permitting, and construction.

#### 1.4 PROJECT INFORMATION

- A. Project Identification: Citywalk on the Nickel Plate Trail.
  - 1. Project Location: Lantern Road, Fishers, Indiana, 46038, United States.
- B. Owner: Citywalk Development LLC .
  - 1. Owner's Representative: Hossam Wanas .
- C. Architect: Studio M Architecture and Planning, 2 West Main, Carmel, Indiana, 46032.
  - 1. Architect's Representative: Studio M Architecture.
- D. Architect's Consultants: Architect has retained the following design professionals, who have prepared designated portions of the Contract Documents:
  - 1. Civil Engineering and Landscape Design : Civil and Environmental Consultants, Inc. .
    - a. Civil and Landscape Representative: Aaron Hurt .
- E. Construction Manager: CitiBld, LLC .
  - 1. Construction Manager Representative: Francois Mercho, francois@citywalkfishers.com, 317.201.4151 .
  - 2. Construction Manager has been engaged for this Project to serve as an advisor to Owner and to provide assistance in administering the Contract for construction between Owner and each Contractor, according to a separate contract between Owner and Construction Manager.
    - a. Construction Manager also serves as Project coordinator, as defined in Section 011200 "Multiple Contract Summary."

#### 1.5 WORK COVERED BY CONTRACT DOCUMENTS

- A. The Work of Project is defined by the Contract Documents and includes, but is not limited to, the following:
1. Civil engineering documents prepared by CEC, INC dated 2/23/2024 and other Work indicated in the Contract Documents.
- B. Type of Contract:
1. Project will be constructed under coordinated, concurrent multiple contracts. See Section 011200 "Multiple Contract Summary" for a list of multiple contracts, a description of work included under each of the multiple contracts, and the responsibilities of Project coordinator.
  2. **The link to the drawings and specs is [https://distribution.easternengineering.com/View/ViewJobList.aspx?group\\_id=private\\_all](https://distribution.easternengineering.com/View/ViewJobList.aspx?group_id=private_all). This is the "private" side of the Eastern Engineering Plan Room. The password is all lower case "citywalk".**
  3. **The owners have extended the bid date until the 27th of March 2024 at 2:00 PM.**
  4. **The current bid set asks for a complete bid for the civil portion of the project. If you wish, you can submit a number for only those categories that for which you have expertise.**
  5. **The owners have also relaxed the date to start construction. Please include in your bid when you can start work if you are selected.**

#### 1.6 PHASED CONSTRUCTION

- A. Construct the Work in phases, with each phase substantially complete as indicated on Drawings .
1. Phase I : Water Main Extension, Survey and Testing, Grading, Drainage and SWPP requirements, on site utilities . Initial site concrete and asphalt subbase and base course.
    - a. Commencement of Construction:
      - 1) Notice to Proceed: Work of this phase shall commence within 5 days after the Notice to Proceed.
      - 2) Start Date: Work of this phase shall commence no later than April 15, 2024 .
  2. Phase II : Perform the remaining Work including remaining site concrete, top coat of asphalt, and fine grading. The remaining Work shall be substantially complete at time of Substantial Completion of the Work.
- B. Before commencing Work of each phase, submit an updated copy of Contractor's construction schedule, showing the sequence, commencement and completion dates for all phases of the Work.

#### 1.7 MULTIPLE WORK PACKAGES

- A. Construction Documents for this Project will be issued in a series of Work Packages, each defining the Work under individual Contracts. Coordinate the Work under this Contract with separate contracts defined by other work packages. Work Packages consist of the following:
1. Early Site Package : Documents prepared by CEC, Inc. dated 2/23/2024 : . To be issued March 4, 2024 .
  2. Foundations and Structure Package : . To be issued Spring 2024 .
  3. General Building Package : . To be issued Summer 2024 .

#### 1.8 WORK UNDER OWNER'S SEPARATE CONTRACTS

- A. Work with Separate Contractors: Cooperate fully with Owner's separate contractors, so work on those contracts may be carried out smoothly, without interfering with or delaying Work under this Contract or other contracts. Coordinate the Work of this Contract with work performed under Owner's separate contracts.
- B. Subsequent Work: Owner will award separate contract(s) for additional work to be performed at site concurrently with the work of this contract. Completion of that work will depend on successful completion of preparatory Work under this Contract.

1.9 CONTRACTOR'S USE OF SITE AND PREMISES

- A. Unrestricted Use of Site: Each Contractor shall have full use of Project site for construction operations during construction period. Contractor's use of Project site is limited only by Owner's right to perform work or to retain other contractors on portions of Project.

1.10 WORK RESTRICTIONS

- A. Comply with restrictions on construction operations.
  - 1. Comply with limitations on use of public streets, work on public streets, rights of way, and other requirements of authorities having jurisdiction.

PART 2 - PRODUCTS (Not Used)

PART 3 - EXECUTION (Not Used)

END OF SECTION 011000