ADDENDUM NO. 1

Guion Creek Middle School, Lincoln Middle School, New Augusta North Public Academy – Restroom Renovations Phase 2

Project No. 223096.00

MSD of Pike Township Indianapolis, Indiana

Index of Contents

Addendum No. 1, 6 Items, 2 pages
New Project Manual Section: 09 01 62.91 – Terrazzo Restoration
Revised Drawing Sheets: A0.1.8, A1.1.8A, A1.1.8B, A1.1.8C, A2.1.8, A2.2.8, A2.3.8, A3.1.8, A3.2.8, A4.1.8, A4.2.8, and A4.3.8
Pre-Bid Meeting Sign-in Sheet

Date: March 8, 2024

FANNING/HOWEY ASSOCIATES, INC. ARCHITECTS/ENGINEERS/CONSULTANTS

TO: ALL BIDDERS OF RECORD

ADDENDUM NO. 1 to Drawings and Project Manual, dated February 23, 2024, for MSD of Pike Township, 3950 W. 56th Street, Indianapolis, Indiana 46278; as prepared by Fanning/Howey Associates, Inc., Indianapolis, Indiana.

This Addendum shall hereby be and become a part of the Contract Documents the same as if originally bound thereto.

The following clarifications, amendments, additions, revisions, changes, and modifications change the original Contract Documents only in the amount and to the extent hereinafter specified in this Addendum.

Each bidder shall acknowledge receipt of this Addendum in his proposal or bid.

NOTE: Bidders are responsible for becoming familiar with every item of this Addendum. (This includes miscellaneous items at the very end of this Addendum.)

RE: ALL BIDDERS

ITEM NO. 1. PROJECT MANUAL, TABLE OF CONTENTS

A. Page 00 01 10-2, DIVISION 09: Add Section 09 01 62.91 – Terrazzo Restoration.

ITEM NO. 2. <u>NEW PROJECT MANUAL SECTION</u>

A. New Project Manual Section 09 01 62.91 – Terrazzo Restoration is included with and hereby made a part of this Addendum.

ITEM NO. 3. PROJECT MANUAL, SECTION 01 29 00 - PAYMENT PROCEDURES

- A. Replace 1.4, E., as follows:
 - "E. Transmittal: Submit signed Application for Payment to A/E electronically. One copy shall also be complete, including waivers of lien and similar attachments, when required.
 - 1. Transmit each copy with a transmittal form listing attachments and recording appropriate information related to application in manner acceptable to A/E."

ITEM NO. 4. PROJECT MANUAL, SECTION 06 41 16 – PLASTIC-LAMINATE-FACED ARCHITECTURAL CABINETS

- A. Replace 1.1, A., 2., as follows:
 - "2. Solid Surface countertops/lavatory tops with integral bowls."
- B. Add 2.8, A., 7., 8., and 9., as follows:
 - "7. Bowl type: Oval configuration with pre-drilled faucet holes in top, complying with ANSI Z124.3 and ANSI Z124.6. Refer to Drawings for specific model number.
 - a. Sink/Bowl Mounting Hardware: Manufacturer's approved bowl clips, brass inserts and fasteners for attachment of undermount sink/bowls.
 - 8. Provide holes and cutouts for plumbing and bath accessories as indicated on Drawings.
 - 9. Rout and finish component edges to a smooth, uniform finish. Rout all cutouts, then sand all edges smooth. Repair or reject defective or inaccurate work."

ITEM NO. 5. PROJECT MANUAL, SECTION 10 28 00 - TOILET, BATH, AND LAUNDRY ACCESSORIES

- A. Article 2.5, A., 1: Delete subparagraphs a., b., d., e., and f., in their entirety.
- B. Article 2.5, B., 4: Change "115V" to "100 120V" at beginning of paragraph.
- C. Add 2.5, C., as follows:
 - "C. Contractor shall check, confirm, and set unit options at completion of installation and testing of operation.
 - a. Match operation of units installed in other portions of building.
 - b. Confirm settings for shut-off period, motor operation, infrared sensor, and heating element operation.

ITEM NO. 6. REVISED DRAWING SHEETS

A. Drawing Sheets: A0.1.8, A1.1.8A, A1.1.8B, A1.1.8C A2.1.8, A2.2.8, A2.3.8, A3.1.8, A3.2.8, A3.3.8, A4.1.8, A4.2.8, and A4.3.8 have been revised, dated 3/8/24, and are included with and hereby made a part of this Addendum. These Drawings supersede the original documents.

END OF ADDENDUM

SECTION 09 01 62.91 - TERRAZZO RESTORATION

PART 1 - GENERAL

1.1 SUMMARY

- A. Section Includes: Requirements for restoration of terrazzo work (RTERR).
 - 1. Cleaning and refinishing existing terrazzo floors.
 - 2. Repairing small cracks and holes in terrazzo floor with cement grout.

B. Related Requirements:

Division 07 Section "Joint Sealants."

1.2 SYSTEM DESCRIPTION

- A. NTMA Standards: Comply with specified provisions and recommendations of the National Terrazzo and Mosaic Association, Inc. (NTMA).
- B. Accessibility Requirements: Floor surfaces shall be provided to conform with the Americans with Disabilities Act Accessibility Guidelines (ADAAG) and State and Local Regulations. These requirements supersede Technical Specifications in this Section.

1.3 CLOSEOUT SUBMITTALS

- A. General: Closeout Submittals are to be submitted with O and M Manuals only. Do not submit with other ACTION and INFORMATIONAL Submittals:
 - 1. Maintenance Literature: Upon Substantial Completion of the Work under this Section, the Contractor shall furnish to the Owner copies of literature from the National Terrazzo and Mosaic Association (NTMA), Inc. on the "Care of Terrazzo."
 - Cleaning products to be used and Terrazzo Maintenance Data/Protocols for facility managers.

1.4 QUALITY ASSURANCE

- A. Suppliers shall provide materials in accordance with the NTMA standards.
- B. Installer shall be a Contractor Member of the NTMA or be certified to perform Work in accordance with NTMA standards.
- C. NTMA Standard: Comply with NTMA Guide Specification and written recommendations for terrazzo type indicated unless more stringent requirements are specified.
- D. Mockups: Perform restoration mockups to confirm proposed matching of existing color and pattern and to demonstrate aesthetic effects and qualities of materials and execution.
- E. Preinstallation Meeting: Conduct meeting at project site. Review methods and procedures related to terrazzo including, but not limited to, the following:
 - 1. Inspect and discuss condition of substrate and other preparatory work performed by other trades.
 - 2. Review and finalize construction schedule and verify availability of materials, Installer's personnel, equipment, and facilities needed to make progress and avoid delays.
 - 3. Review special terrazzo designs and patterns.
 - 4. Review dust control procedures.

1.5 DELIVERY, STORAGE, AND HANDLING

A. Deliver materials to Project site in supplier's original wrappings and containers, labeled with source's or manufacturer's name, material or product brand name, and lot number if anv.

B. Store materials in their original, undamaged packages and containers, inside a well-ventilated area protected from weather, moisture, soiling, extreme temperatures, and humidity.

1.6 FIELD CONDITIONS

- A. Environmental Limitations: Comply with manufacturer's written instructions for substrate temperature, ambient temperature, moisture, ventilation, and other conditions affecting terrazzo installation.
- B. Provide permanent lighting or, if permanent lighting is not in place, simulate permanent lighting conditions during terrazzo installation.
- C. Close spaces to traffic during epoxy terrazzo application and for not less than 24 hours after application unless manufacturer recommends a longer period.
- D. Control and collect dust produced by grinding operations. Protect adjacent construction from detrimental effects of grinding operations.
 - Provide dustproof partitions and temporary enclosures to limit dust migration and to isolate areas from noise.

PART 2 - PRODUCTS

2.1 MANUFACTURERS

- A. Products: Subject to compliance with requirements, provide one of the following:
 - Novalite; ChemRex, Inc./SKW-MBT.
 - 2. Spectrum Terrazzo; Dex-O-Tex Division, Crossfield Products Corp.
 - 3. Terrazzo 2000; General Polymers Corporation.
 - 4. Key Epoxy Terrazzo; Key Resin Company.
 - 5. Morricite; Master Terrazzo Technologies, LLC.
 - 6. MasterPiece ETS; Polymerica Incorporated.
 - 7. Tuff-Lite 10 Epoxy Terrazzo; TEC, Inc., and H.B. Fuller Company.
 - 8. Terroxy Resin Systems; Terrazzo and Marble Supply Companies
- B. Products of other manufacturers will be considered for acceptance provided they equal or exceed the material requirements and functional qualities of the specified product. Requests for A/E's approval must be accompanied by the "Substitution Request Form" and complete technical data for evaluation. All materials for evaluation must be received by the Project Manager and Specification Department at least 10 days prior to bid due date. Additional approved manufacturers will be issued by Addendum.

2.2 MATERIALS

- A. Materials for Existing Terrazzo Restoration
 - 1. Cleaner: Potable water, free of iron, all cleaners should be pH neutral.
 - a. Cleaner must be recommended by cleaning manufacturer for use on terrazzo type where it will be applied.
 - 2. Sealer: Liquid type to completely seal matrix surface; not detrimental to terrazzo components.
 - 3. Grout: Color to match existing matrix.
 - 4. Matrix: Pigmented epoxy to match sample submitted.
 - 5. Aggregates: Aggregates to match approved sample.
- B. Patching and Fill Material: Resinous product of or approved by terrazzo manufacturer and recommended by manufacturer for application indicated.
 - 1. Patching minor holes/chips and cracks in terrazzo with cement grout.
 - a. Portland Cement: ASTM C150, Type 1, except as modified to comply with NTMA requirements for compressive strength.
 - 1) Obtain cement from a single source for each required color.
 - 2) Provide non-staining white cement for terrazzo matrix.

- b. Sand: ASTM C33.
- c. Clean, potable water.
- d. Aggregate: Natural, sound, crushed marble chips that do not include excessive flats of flakes, complying with NTMA requirements.
 - 1) Colors and gradation of aggregate sizes as required to match original existing intact materials and patterns.
 - 2) Aggregate colors should be matched after cleaning or taken from the interior of core samples depending upon scope of work.
- e. Matrix Pigments: Pure mineral or synthetic pigments, resistant to alkali and non-fading. Mix pigments with matrix to provide required colors.
- f. Curing Compound: Liquid-membrane-forming compound, ASTM C309, Type 1.
- g. Grout: A cement acrylic grout with color added to match the matrix of the original terrazzo.
- Epoxy Resin: Manufacturer's standard recommended for use indicated and in color required for mix indicated.
 - 1. Physical Properties (without Aggregates):
 - a. Hardness: 60 to 85 per ASTM D2240, Shore D.
 - b. Minimum Tensile Strength: 3000 psi per ASTM D638 for a 2-inch specimen made using a "C" die per ASTM D412.
 - c. Minimum Compressive Strength: 10,000 psi per ASTM D695, Specimen B cylinder.
 - d. Chemical Resistance: No deleterious effects by contaminants listed below after 7-day immersion at room temperature per ASTM D1308.
 - 1) Distilled water.
 - 2) Mineral water.
 - 3) Isopropanol.
 - 4) Ethanol.
 - 5) 0.025 percent detergent solution.
 - 6) 1.0 percent soap solution.
 - 7) 10 percent sodium hydroxide.
 - 8) 10 percent hydrochloric acid.
 - 9) 30 percent sulfuric acid.
 - 10) 5 percent acetic acid.
 - 2. Physical Properties with Aggregates: For resin blended with Georgia White marble, ground, grouted, and cured per requirements in NTMA's "Guide Specification for Epoxy Terrazzo," comply with the following:
 - a. Flammability: Self extinguishing, maximum extent of burning 0.25 inch per ASTM D635.
 - b. Thermal Coefficient of Linear Expansion: 0.0025 inch/inch per degrees F for temperature range of minus 12 to 140 degrees F per ASTM D696.
- D. Marble Chips: Complying with NTMA gradation standards for mix indicated and containing no deleterious or foreign matter.
 - 1. Hardness: Ha-10 minimum per ASTM C241.
 - 2. 24 Hour Absorption Rate: Less than 0.75 percent.
 - 3. Dust Content: Less than 1.0 percent by weight.
- E. Divider Strip Adhesive: Epoxy resin adhesive recommended by adhesive manufacturer for this use and acceptable to terrazzo manufacturer.
- F. Finishing Grout: Resin-based.
- G. Seal Coat: Slip-resistant, thin coat terrazzo sealer of or approved by terrazzo manufacturer.
- H. Mix: Comply with NTMA's "Guide Specification for Epoxy Terrazzo" and manufacturer's written instructions for component proportions and mixing.
 - 1. Color and Pattern: Match existing.

2.3 ACCESSORIES

- A. Joint Sealants: Recommended by terrazzo and sealant manufacturers and complying with requirements in Division 07 Section "Joint Sealants".
- B. Cleaner: Chemically neutral cleaner with pH factor between 7 and 10 that is biodegradable, phosphate free, and recommended by cleaner manufacturer for use on terrazzo type indicated.

2.4 EQUIPMENT

- A. Grinding Stones: Fine grit emery stones manufactured specifically for restorative type grinding and surfacing of terrazzo surfaces (#40 and #80 grit stones).
- B. Resurfacing Screens: A fine grit screen manufactured specifically for restorative type grinding and resurfacing terrazzo surface.

PART 3 - EXECUTION

3.1 EXAMINATION

A. Inspection of Surfaces: Before beginning operations the Contractor will examine carefully surfaces to receive terrazzo renovation. Finish which is found unsuitable to receive his work should be reported to the A/E.

3.2 PREPARATION

- A. Clean areas to be renovated by removing dirt, debris, loose chips and foreign matter.
 - Remove existing layers of sealer and wax as recommended by cleaning materials and NTMA.
- B. Saturate void with water to prevent quick surface drying. Ensure that water penetrates into the surface in order to achieve a proper bond.
- C. Apply cement paste and work into the surface. Do not allow cement paste to dry before placing terrazzo composition.

3.3 CRACK REPAIR (RC)

- A. Clean crack of loose material, dirt or sealer.
- B. Fill with resin to match existing. Use aggregate in the crack if crack is wider than 1/4 inch.

3.4 PATCHING MINOR HOLES, CHIPS, AND CRACKS

- A. Mix two parts blended marble chips with one part Portland cement and add enough water to make the mixture plastic.
- B. Place mixture over chip or crack and level with a trowel.
- C. Seed additional marble chips of the same blend over the patch, as required to establish a uniform covering.
- D. Compact patch, removing all excess water and cement from the surface.
- E. Cover the patch with paper or polyethylene sheeting to prevent quick hydration.
- F. Cure until topping develops sufficient strength to prevent lifting or pulling of terrazzo chips during grinding.

- G. Sand surface with a hand sander or small grinding tool, using fine stones to achieve desired finish.
 - 1. Use a #40 or finer grit stone for the initial grinding, exposing the marble chips. Follow with a #80 grid stone before grouting with cement to fill all pinholes.
 - a. Caution: If divider strips are coated instead of solid composition, they should not be ground. Grinding may cause coated divider strips to lose their coating and discolor.
 - 2. Cover grouted surface with paper or polyethylene for at least 72 hours.
 - 3. Thoroughly rinse the surface with clean, clear water.
 - Remove excess rinse water.
 - 5. Apply grout by hand or with a machine, using identical Portland cement, color and pigments as were used in topping, taking care to fill all voids completely.
 - 6. Final polish with a #80 or finer grit stone. Care should be taken to limit grinding and polishing to a small distance beyond the perimeter of the patch.
- H. Seal patch with a penetrating type terrazzo sealer.

3.5 RESTORATION OF TERRAZZO FINISH

A. Initial Grinding

- 1. Grind with 24 or finer grit stones--fine mesh sand can be used if needed--in the presence of water.
- 2. Follow initial grind with 80 or finer grit stones in the presence of water, but omit sand.

B. Grouting

- 1. Cleanse floor with ample clean water and rinse thoroughly. Wet grind with 50 or higher abrasive grit medium diamonds.
- Remove excess rinse water and machine or hand-apply grout, using a cement/acrylic, with or without color added to match the matrix of the terrazzo floor, taking care to fill voids.

C. Curing Grout

- 1. As soon as grout has attained initial set, use an approved curing method, allowing a slow cure of the grout.
- 2. Allow grout to cure a minimum of 12 hours. Maintain ambient air temperature between 70 deg F and 80 deg F.

D. Final Grinding

1. Grind with 120 grit carborundum or 200 grit resin bond diamond until traces of the grout have been removed from the terrazzo surface.

E. Existing Divider Strips

1. Cover existing divider strips with 3 inch fiberglass tape using the same catalyzed resin as the binder for system application.

3.6 CLEANING, SEALING, AND PROTECTION

A. Cleaning and Sealing

- 1. Thoroughly wash all surfaces with a neutral cleaner, follow by rinsing with clean water and allow to dry thoroughly.
- 2. Apply sealer as per manufacturer's directions.
- 3. Remove protection and clean any adjacent surfaces effected by the refinish process.

B. Protection

 Upon completion, this Work shall be ready for final inspection and acceptance by the Owner or his agent. The General Contractor shall protect the finished floor from all trades that will follow.

END OF SECTION 09 01 62.91



Project Name

MSD OF PIKE TOWNSHIP

Pike Guion Creek Middle School, Lincoln Middle School, and New

Augusta North Public Academy - Restroom Renovation Phase 2

223096.00

FEBRUARY 29, 2024

Project No. Meeting Date

PLEASE PRINT CLEARLY. YOUR NAME AND TITLE WILL BE INCLUDED IN THE MEETING REPORT.

THANK YOU!

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NAME (Please print)	TITLE	COMPANY	PHONE/ FAX	E-MAIL
Clayton Gruber	Director of Facilities and Security	MSD of Pike Township	317.280.2425	cgruber@pike.k12.in.us
Danny Struck	Assistant PM	Shuck Copposition	317-786-4818	2 carrie Shuckeo D. co.a
Jimmie Immel	District Phosber	2kc.		317-519-41821) James (2016 - 117.15 0
HARD WS	ESTIMMEDA	JERUCE	PETOIPTIE	SITGIOTAS MIJSKOVEVKIER, COM
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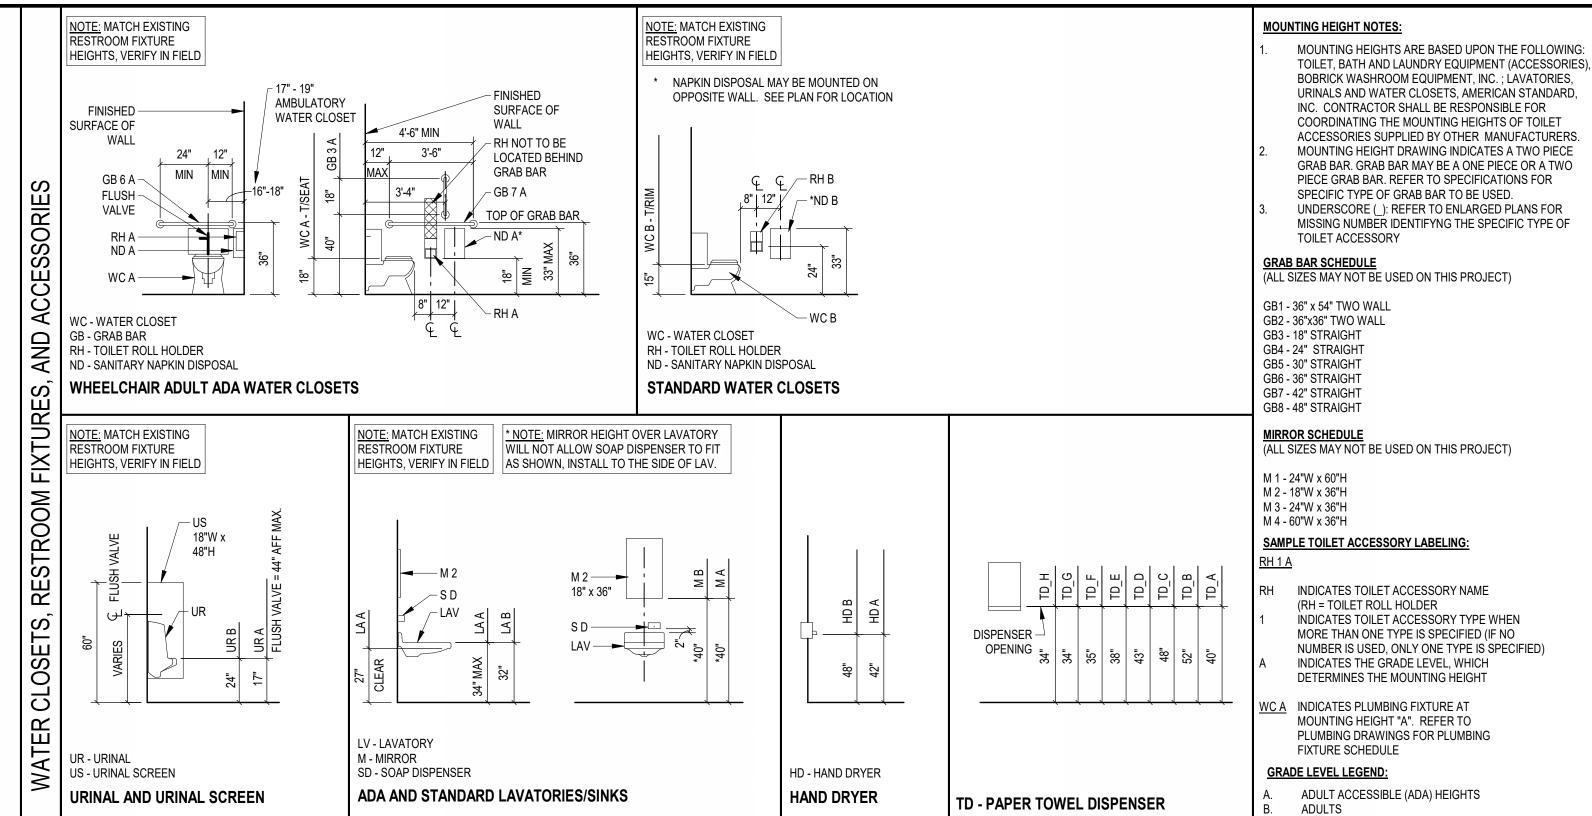
• LAVATORY CARRIER NOTE: CONTRACTOR SHALL REUSE EXISTING CONCEALED ARM CARRIER FOR NEW LAVATORY INSTALLATION. IF LAVATORY IS DETERMINED TO BE IMPROPERLY SECURED, NOTIFY ARCHITECT WITH DETAILED INFORMATION AND LOCATION.

SEE WATER CLOSETS, RESTROOM FIXTURES, AND ACCESSORIES DIAGRAMS TO THE RIGHT FOR CLARIFICATOINS OF THE "A" AND "B" MARK DESIGNATIONS. IN ALL CASES, NEW FIXTURES WILL BE INSTALLED ON EXISTING CARRIERS AT EXISTING HEIGHTS, SO LOCATIONS OF A VS. B FIXTURES WILL BE VERIFIED IN THE FILED. NOTIFY THE ARCHITECT OF ANY CONCERNS OR ISSUES WITH EXISTING CARRIERS BEFORE PROCEEDING WITH INSTALLATION.


DIFFUSER AND GRILLE SCHEDULE									
MARK	TYPE	MANUFACTURER MODEL	NECK SIZE	OVERALL SIZE L"xW"	MAX CORE/ NECK VEL.(FPM)	MAX. CFM	MAX. NOISE CRITERIA	FRAME/ MOUNTING	COMMENTS
(A) CFM	ADJUSTABLE 3-CONE CEILING DIFFUSER	TITUS TMSA	8"	24"x24"	700	200	20	REFER TO REFLECTED CEILING PLAN	
(B) CFM	EXHAUST GRILLE	TITUS 350RL	12"x12	12"x12"	800	300	20	REFER TO REFLECTED CEILING PLAN	

GENERAL REQUIREMENTS:

1. CONTRACTOR SHALL VERIFY SIZE, LOCATION, AND CEILING TYPE PRIOR TO ORDERING DIFFUSERS AND GRILLES. COORDINATE LOCATIONS OF DIFFUSERS AND GRILLES WITH ALL TRADES.



TOILET ACCESSORIES						
SYMBOL	DESCRIPTION	OWNER PROVIDED/ OWNER INSTALL	OWNER PROVIDED/ CONTR. INSTALL	CONTR. PROVIDED/ CONTR. INSTALL	CONTR.PROVIDED/ OWNER INSTALL	
GB	GRAB BARS			X		
HD	HAND DRYERS - ELECTRIC			X		
М	MIRRORS			X		
ND	SANITARY NAPKIN DISPOSAL			X		
SD	SOAP DISPENSER	Х				
RH	TOILET TISSUE ROLL HOLDER		X			
PT	PAPER TOWEL DISPENSER		X			

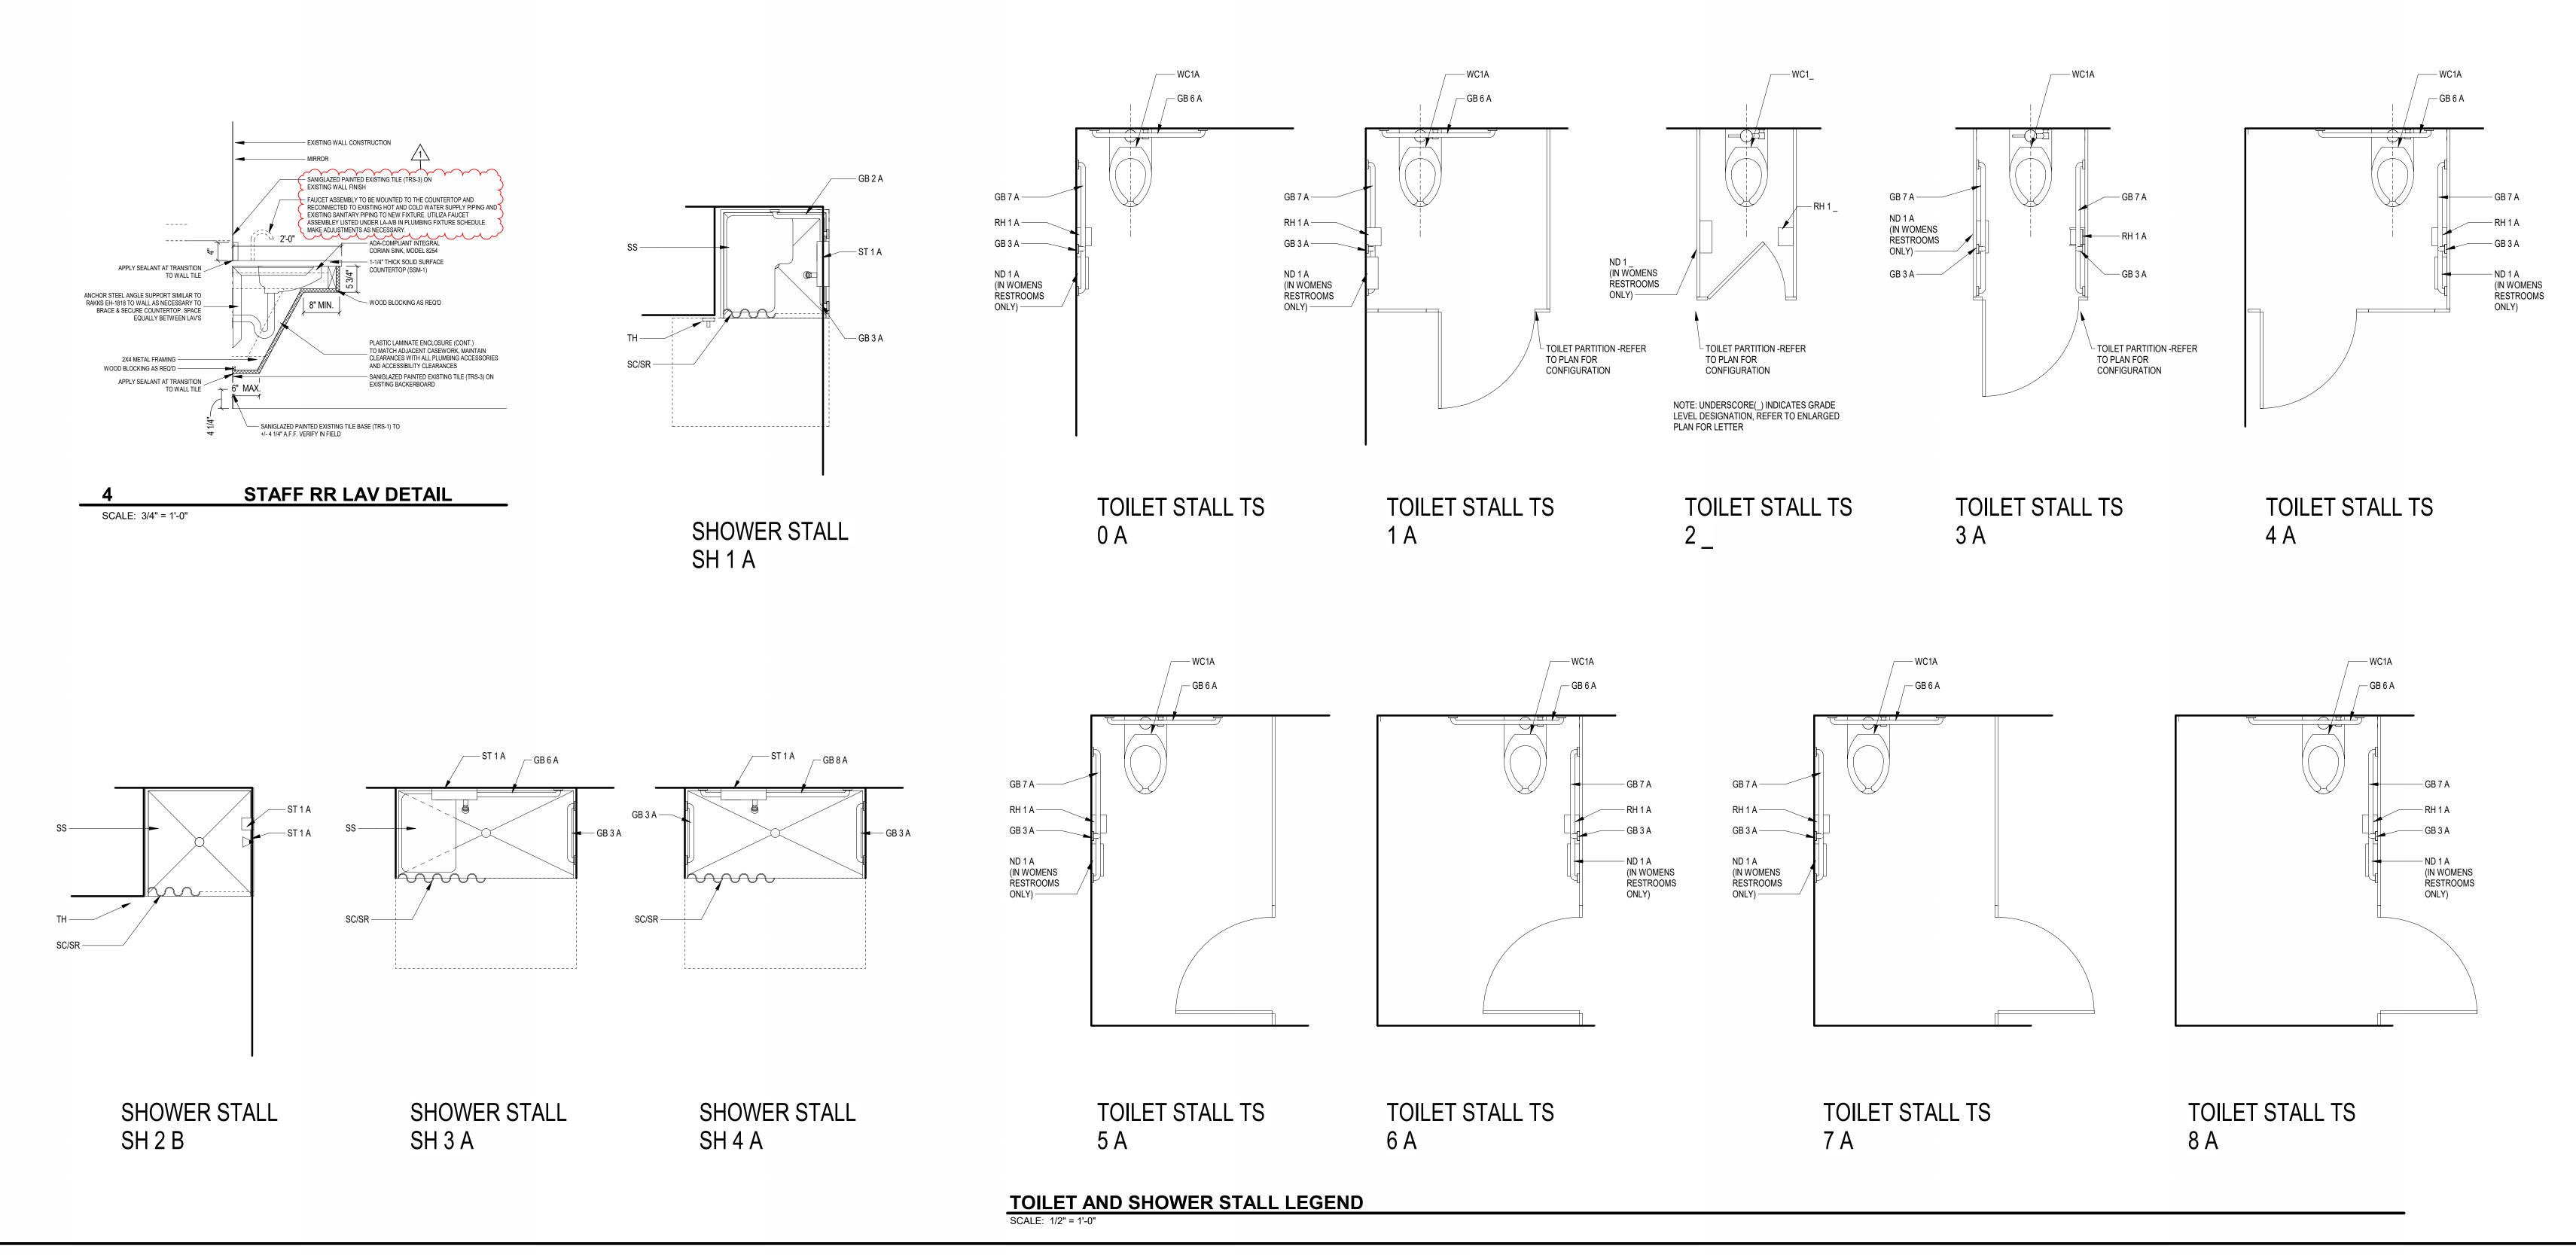

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RESTROOM RENOVATIONS PHASE II

GUION GREEK MIDDLE SCHOOL 4401 W 52ND ST INDIANAPOLIS, IN 46254

LINCOLN MIDDLE SCHOOL 5353 W 71ST ST INDIANAPOLIS, IN 46268


NEW AUGUSTA NORTH PUBLIC ACADEMY 6450 RODEBAUGH RD INDIANAPOLIS, IN 46268

MSD OF PIKE TOWNSHIP





WWW.FHAI.COM 350 E. NEW YORK ST., SUITE 300 INDIANAPOLIS, IN 46204

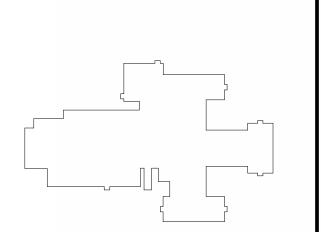

KEY PLAN GUION CREEK MIDDLE SCHOOL

CONSTRUCTION DOCUMENTS

PROJECT MANAGER: PW DRAWN BY: KMS PROJECT NUMBER: 223096.00

ISSUE DATE: 02.23.2024

NO. DESCRIPTION 03.08.2024 1 ADDENDUM #1

GCMS, LMS, NAPAN LEGENDS AND SCHEDULES

GCMS, LMS, NAPAN RESTROOM RENOVATIONS PHASE II

GUION GREEK MIDDLE SCHOOL 4401 W 52ND ST INDIANAPOLIS, IN 46254

LINCOLN MIDDLE SCHOOL 5353 W 71ST ST INDIANAPOLIS, IN 46268


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MSD OF PIKE TOWNSHIP



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KEY PLAN GUION CREEK MIDDLE SCHOOL

CONSTRUCTION DOCUMENTS

PROJECT MANAGER: PW DRAWN BY: HA PROJECT NUMBER: 223096.00 ISSUE DATE: 02.23.2024 **REV.**

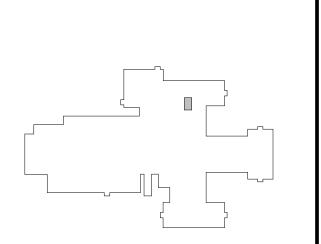NO.	DESCRIPTION	DATE
1	ADDENDUM #1	03.08.2024

GCMS FIRST FLOOR PLAN

A1.1.8A

GCMS, LMS, NAPAN RESTROOM RENOVATIONS PHASE II

GUION GREEK MIDDLE SCHOOL 4401 W 52ND ST INDIANAPOLIS, IN 46254

LINCOLN MIDDLE SCHOOL 5353 W 71ST ST INDIANAPOLIS, IN 46268

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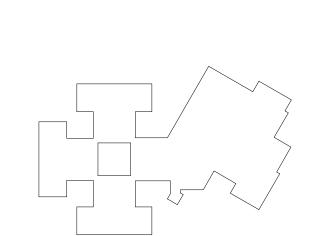
MSD OF PIKE TOWNSHIP



ARCHITECT

FANNING HOWEY

317-848-0966 WWW.FHAI.COM350 E. NEW YORK ST., SUITE 300 INDIANAPOLIS, IN 46204



KEY PLAN
LINCOLN MIDDLE SCHOOL

CONSTRUCTION DOCUMENTS


PROJECT MANAGER: PW DRAWN BY: KMS

DRAWN BY: KMS
PROJECT NUMBER: 223096.00
PROJECT ISSUE DATE: 02.23.2024
REV.

NO.	DESCRIPTION	DATE
	1	

LMS FIRST FLOOR PLAN

A1.1.8B

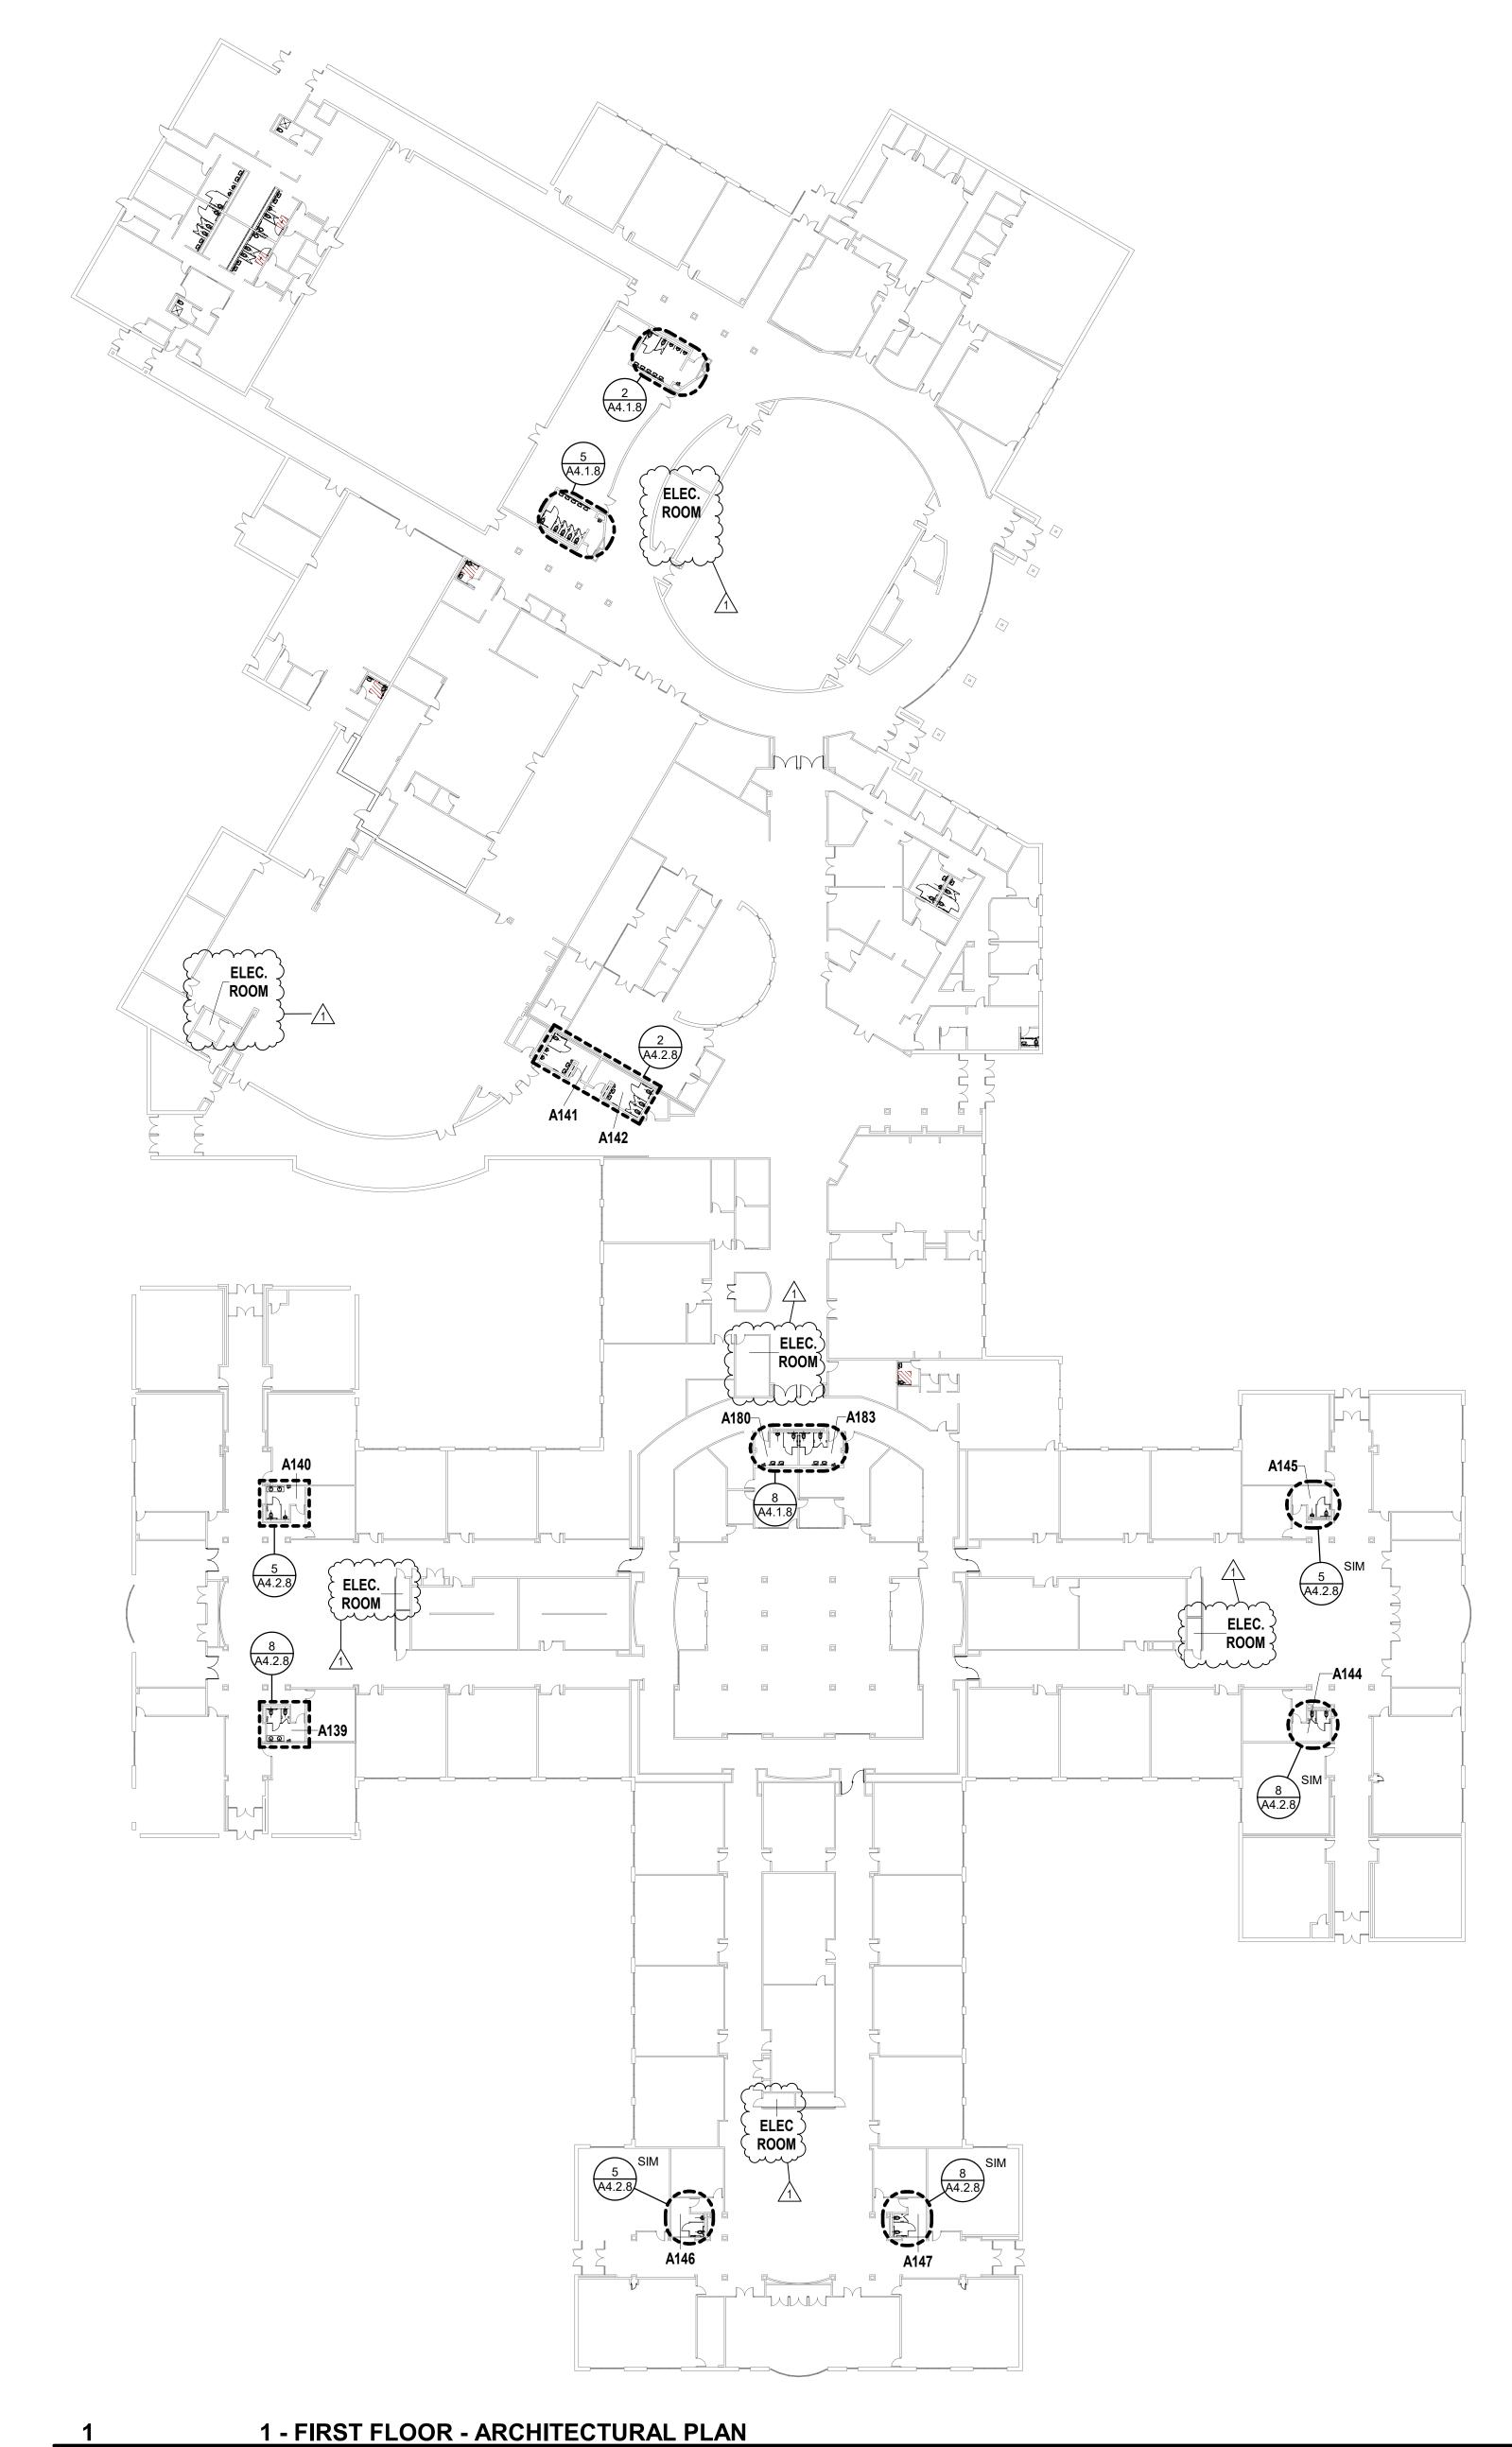

GCMS, LMS, NAPAN RESTROOM RENOVATIONS PHASE II

GUION GREEK MIDDLE SCHOOL 4401 W 52ND ST INDIANAPOLIS, IN 46254

LINCOLN MIDDLE SCHOOL 5353 W 71ST ST INDIANAPOLIS, IN 46268


NEW AUGUSTA NORTH PUBLIC ACADEMY 6450 RODEBAUGH RD INDIANAPOLIS, IN 46268

MSD OF PIKE TOWNSHIP



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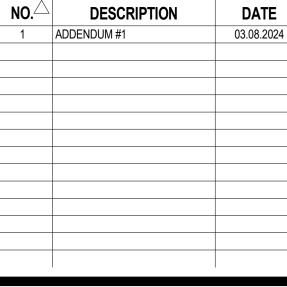
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KEY PLAN GUION CREEK MIDDLE SCHOOL


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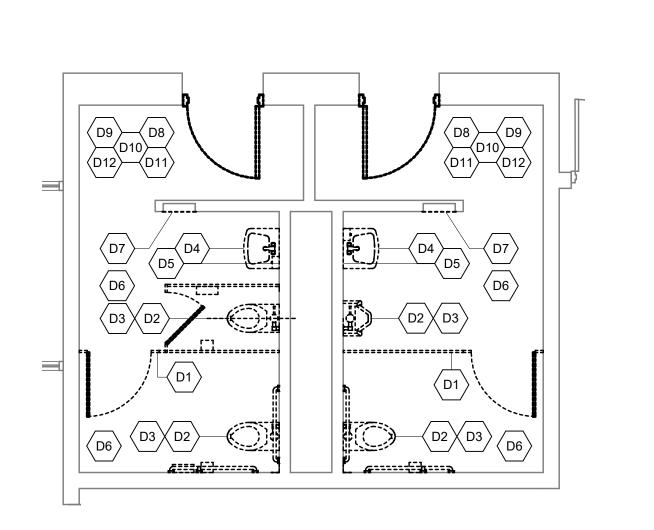
PROJECT MANAGER: PW DRAWN BY: HA PROJECT NUMBER: 223096.00 ISSUE DATE: 02.23.2024

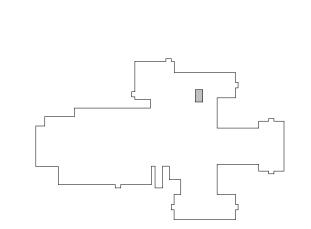


NAPAN FIRST FLOOR PLAN

A1.1.8C




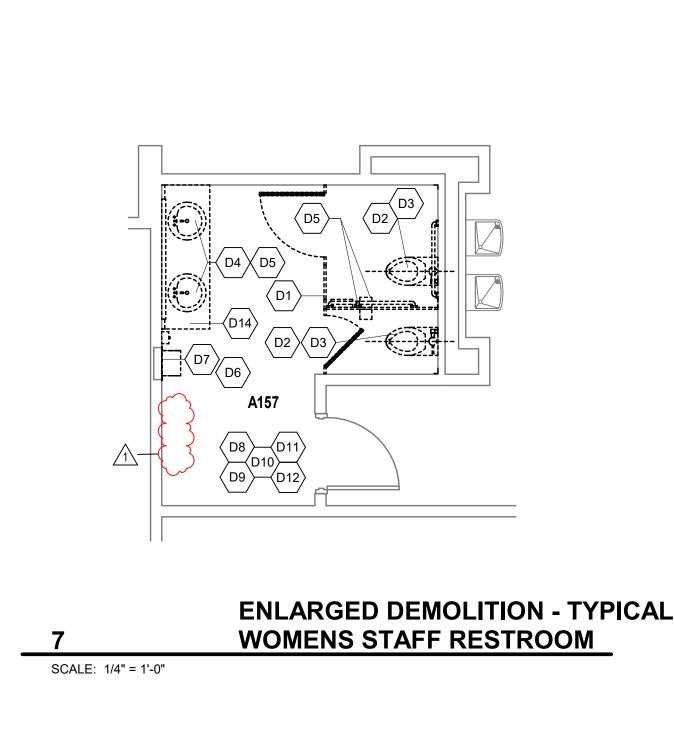




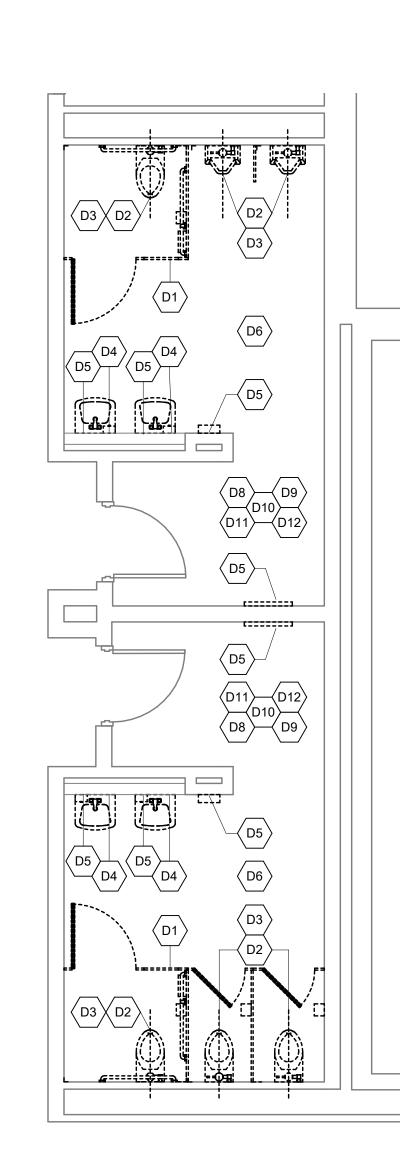

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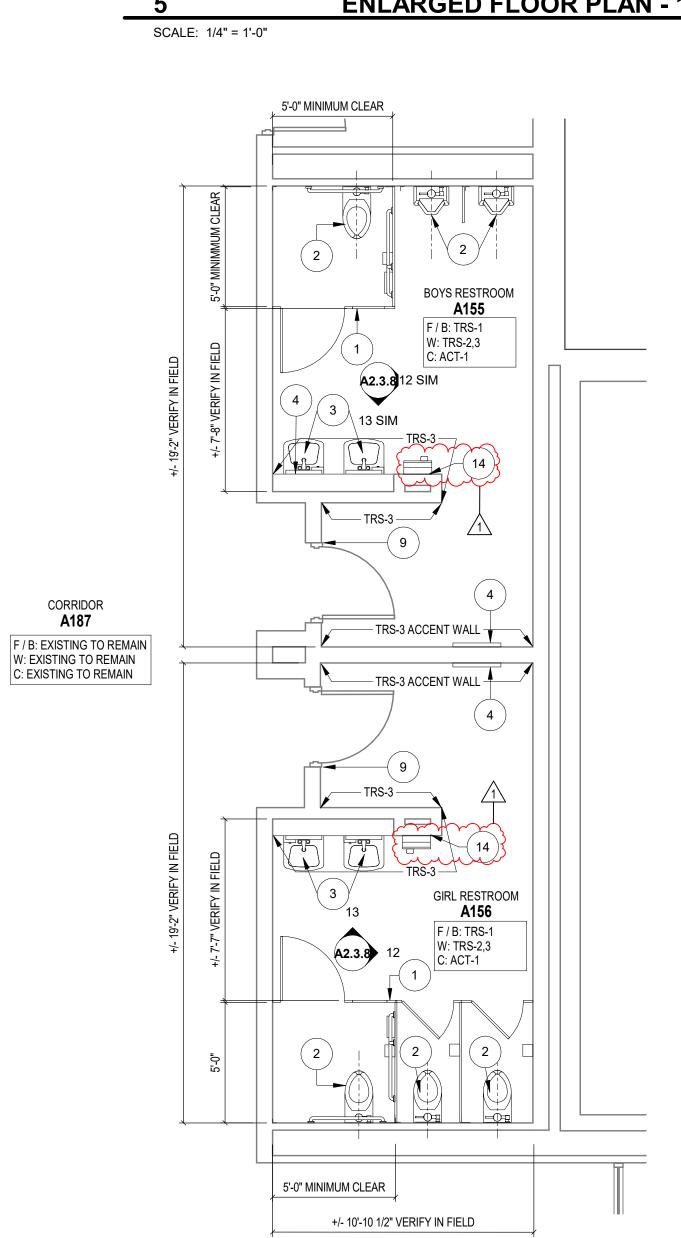


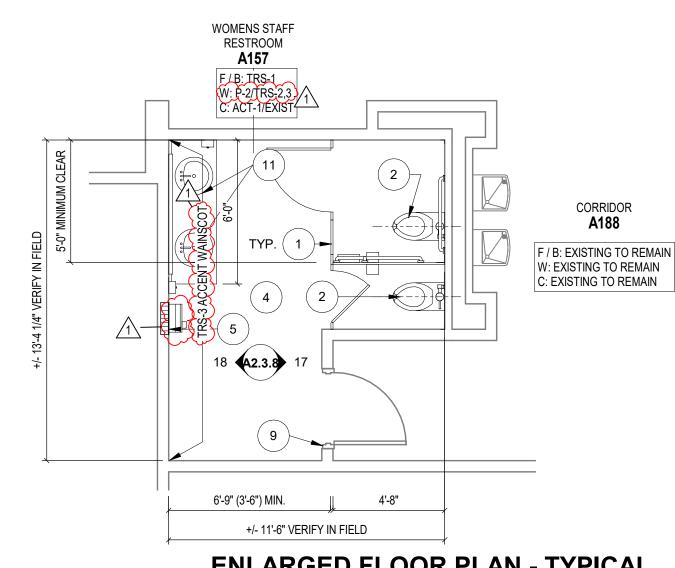ENLARGED FLOOR PLAN - TYPICAL WOMENS STAFF RESTROOM

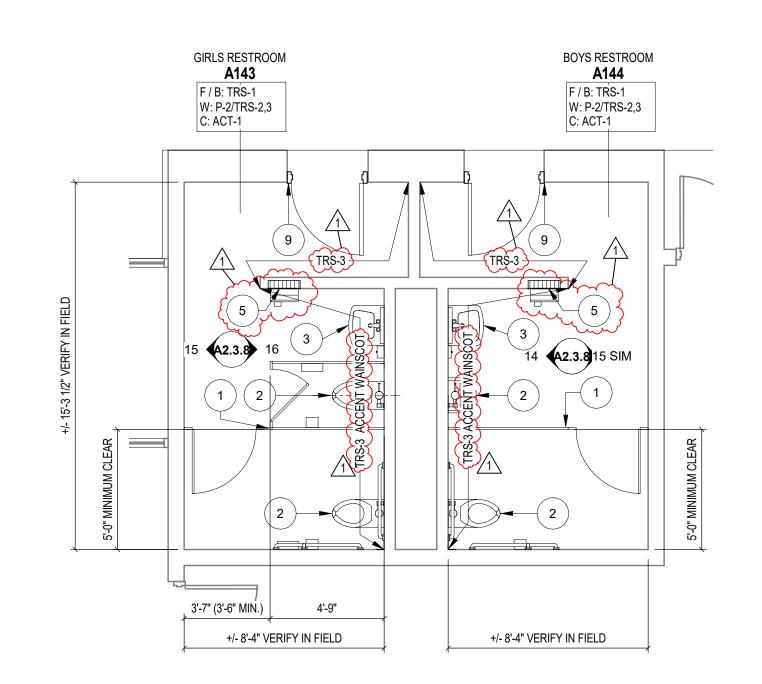


SCALE: 1/4" = 1'-0"

ENLARGED FLOOR PLAN - 143 & 144




ENLARGED FLOOR PLAN - 155 & 156

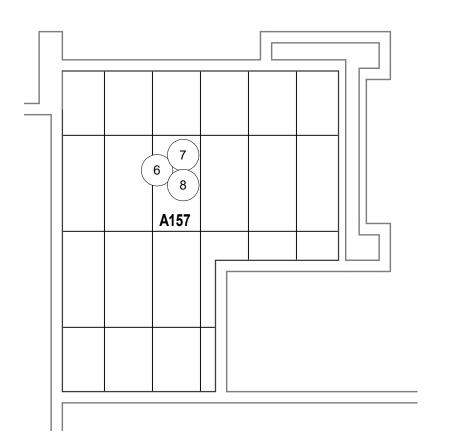


ENLARGED CEILING PLAN -TYPICAL WOMENS STAFF **RESTROOM**

SCALE: 1/4" = 1'-0"

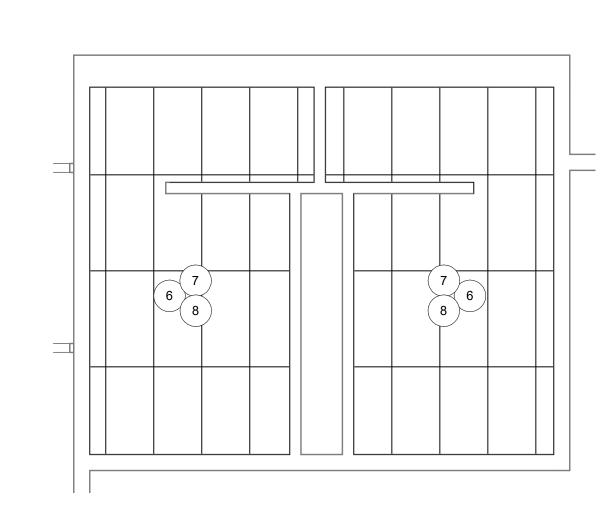

ENLARGED CEILING PLAN - 143 & 144

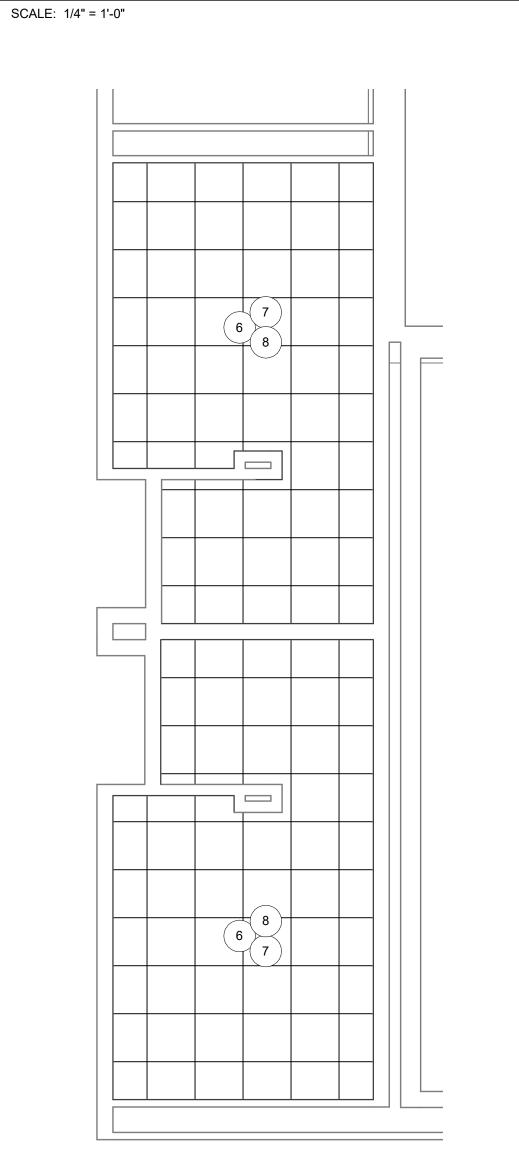

"CEILING" DENOTES CEILING MATERIALS INCLUDING TILE RESTORATION SYSTEM
MATERIAL ABBREVIATION: TRS-1 (FLOOR AND BASE TO +/- 5" SUSPENSION SYSTEMS ADHESIVE RESIDUES, MOLDINGS UP TO BUT EXCLUSIVE OF STRUCTURAL MATERIALS. MECHANICAL AND ELECTRICAL ITEMS THAT ARE CAPPED MATERIAL MANUFACTURER: TILE RESTORATION SYSTEM AND ABANDONED SHALL BE LOCATED BEHIND FINAL FINIS BASE COLOR SELECTION: 422 GREY SANICHIP COLOR SELECTION: BLACK MARBLE 300 CONTRACTOR TO FIELD VERIFY PORTIONS OR SECTIONS OF EXISTING WALLS TO BE FILLED IN AND SALVAGE WALL FINISHES (W): NECESSARY MATERIAL. TILE RESTORATION SYSTEM
MATERIAL ABBREVIATION: TRS-2 (FIELD) MATERIALS OF DEMOLITION SHALL BE DISPOSED OF OFF-SITE UNLESS OTHERWISE DIRECTED BY OWNER.

MATERIAL MANUFACTURER: TILE RESTORATION SYSTEM COLOR SELECTION: 452 WHITE MATERIAL ABBREVIATION: TRS-3 (ACCENT) MATERIAL MANUFACTURER: TILE RESTORATION SYSTEM

COLOR SELECTION: 469 BLUE PAINT
MATERIAL ABBREVIATION: P-1 (DOOR FRAME) MATERIAL MANUFACTURER: SEE SPECS COLOR SELECTION: MATCH EXISTING

MATERIAL ABBREVIATION: P-2 (FIELD) MATERIAL MANUFACTURER: SHERWIN WILLIAMS COLOR SELECTION: TO BE SELECTED MATERIAL ABBREVIATION: P-3 (STEEL TUBE) MATERIAL MANUFACTURER: SHERWIN WILLIAMS

CEILING FINISHES (C): SUSPENDED ACOUSTICAL TILE SYTEM MATERIAL ABBREVIATION: ACT-1 MATERIAL MANUFACTURER: SEE SPECIFICATIONS. COLOR SELECTION: WHITE

SIZE: 24" x 24"

TEXTURE: GRIP EX

ACCEPTANCE OF CONDITIONS.

COLOR SELECTION: TO MATCH TOILET PARTITION FINISH

SUSPENDED ACOUSTICAL TILE SYTEM MATERIAL ABBREVIATION: ACT-2 MATERIAL MANUFACTURER: SEE SPECIFICATIONS. COLOR SELECTION: WHITE SIZE: 24" x 48"

PLASTIC LAMINATE (SINK BASE) MATERIAL ABBREVIATION: PL-1 MATERIAL MANUFACTURER: WILSONART/FORMICA/NEVAMAR COLOR SELECTION: TO BE SELECTED

MATERIAL ABBREVIATION: SSM-1 MATERIAL MANUFACTURER: CORIAN/MEGANITE/WILSONART COLOR SELECTION: TO BE SELECTED

MISCELLANEOUS FINISHES: TOILET PARTITIONS / COMPARTMENTS MATERIAL ABBREVIATION: TPP-1 MATERIAL MANUFACTURER: SEE SPECIFICATIONS. COLOR SELECTION: BLACK

VERIFICATION NOTE CONTRACTOR SHALL VERIEY ALL DIMENSIONS AND CLEARANCES AND ALL EXISTING FIELD CONDITIONS BEFORE STARTING CONSTRUCTION. COMMENCEMENT OF WORK CONSTITUTES

SHOULD DIFFERENT CONDITIONS BE ENCOUNTERED, CONTACT THE ARCHITECT BEFORE PROCEEDING WITH WORK.

ELECTRICAL GENERAL NOTES ARCHITECTURAL DEMOLITION GENERAL NOTES DEMOLITION IS TO FOLLOW ESTABLISHED CONSTRUCTION CONNECT EACH NEW-INSTALLED HAND DRYER TO THE NEAREST AVAILABLE DEDICATED 120V 20A BREAKER. SEQUENCE. CONTRACTOR IS TO VERIFY THEIR WORK IN PROVIDE BREAKER IN SPACE IF NEEDED. THE FIELD WITH THE DEMOLITION DRAWINGS, NEW REFER TO ELECTRICAL ROOM LOCATIONS WITH CONSTRUCTION DRAWINGS, AND THE EXISTING IN-FIELD CONDITIONS. REPORT DISCREPANCIES TO THE ARCHITEC AVAILABLE SPARE/SPACE ON SHEET A1.1.8A. "FLOORING" DENOTES FLOOR COVERING MATERIALS INCLUDING BACKINGS, ADHESIVES, BASES, DOWN TO BUT LIST OF FINISHES EXCLUSIVE OF FLOOR SLABS AND STRUCTURAL MATERIALS, UNLESS NOTED OTHERWISE. FLOOR FINISHES (F) / BASE FINISHES (B):

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MATERIAL. REFINISH TO LIKE NEW CONDITION, OR IF

MATERIALS THAT ARE BEING DEMOLISHED PRIOR TO THE

CONSTRUCTION OR RENOVATION SHALL BE REMOVED.

ITEMS TO BE REMOVED SHALL BE REMOVED IN THEIR

AFTER REMOVAL OF ITEMS, THE EXISTING WALL AND CEILING SURFACES (IF EXPOSED) SHALL BE

REPAIRED/PATCHED AS REQUIRÉD TO RECEIVE NEW

DESCRIPTION

REMOVE EXISTING TOILET PARTITIONS AND ALL PARTITION

MOUNTED ACCESSORIES COMPLETELY. PATCH/REPAIR

FLOOR AND WALL AS NECESSARY, PREPARE FOR NEW

FINISH. IF APPLICABLE, EXISTING TUBE STEEL TOPS

SUPPORTS AND METAL FRAMING ABOVE TO REMAIN REMOVE EXISTING PLUMBING FIXTURE(S). COORDINATE

EXTENTS OF DEMOLITION WITH NEW WORK, CAP ALL

OWNER'S RIGHT OF FIRST REFUSAL BEFORE DISPOSAL

REMOVE EXISTING SANITARY AND SUPPLY PIPING BACK TO

UNUSED PLUMBING. SALVAGE FLUSH VALVES FOR

THE CHASE WALL AND PREPARE FOR NEW FIXTURE

DISCONNECT AND REMOVE EXISTING HOT AND COLD

THE CHASE WALL AND PREPARE FOR NEW FIXTURE

REMOVE EXISTING RESTROOM/TOILET ACCESSORIES COMPLETELY. PATCHAND REPAIR WALL TO MATCH ADJACENT CONSTRUCTION AND PREPARE FOR NEW

CONFIRM EXISTANCE AND LOCATION OF FLOOR DRAIN. EXISTING FLOOR DRAIN TO REMAIN. CONTRACTOR SHALL CLEAN FLOOR DRAIN TO LIKE NEW CONDITION.

ACCESSORY COMPLETELY AND SURROUNDING WALL TILE

RECESSED TOILET ACCESSORY, SALVAGE BULLNOSE TRIM. TO BE REINSTALLED TO MATCH ADJACENT WAINSCOT HEIGHT AND INSTALLATION, AND PREPARE FOR NEW

REMOVE EXISTING DAMAGED FLOOR AND/OR WALL TILE AS

NECESSARY, ASSUME 5% OF FLOOR/WALL. PATCH AND

REPAIR WALL TO MATCH ADJACENT CONSTRUCTION AND

REMOVE EXISTING SUSPENDED ACOUSTICAL CEILING TILE

REMOVE EXISTING SUPPLY DIFFUSERS AND/OR EXHAUST GRILLES. PREPARE FOR INSTALLATION OF NEW DIFFUSER/GRILLE. EXISTING DUCTWORK TO REMAIN, ADJUST AS NECCESSARY FOR NEW DIFFUSER/GRILLES. TEMPORARILY SUSPEND EXISTING CEILING-MOUNTED LIGHT FIXTURES AS NECESSARY FOR CEILING WORK. EXISTING FIRE ALARM DEVICES, SPRINKLER HEADS, AND

SPEAKER DEVICES TO REMAIN. TEMPORARILY DISCONNECT AND STORE OR SUPPORT IN PLACE AS

NECESSARY UNTIL NEW CEILING IS INSTALLED. D13 REMOVE EXISTING HAND DRYER. SALVAGE EXISTING WIRE CONNECTIONS TO INSTALL NEW HAND DRYER. D14 DEMOLISH PLUMBING FIXTURE (S) AND PLASTIC LAMINATE COUNTERTOP. VERIFY COUNTER TOP LENGTH PRIOR TO

ARCHITECTURAL PLAN GENERAL NOTES

(ALL NOTES MAY NOT BE INDICATED ON THIS SHEET)

CONFIGURATION AS EXISTING, TPP-1.

MAKE ADJUSTMENTS AS NECESSARY.

DESCRIPTION PROVIDE NEW TOILET PARTITION AT SAME LOCATION AND

PROVIDE NEW PLUMBING FIXTURE(S) AT SAME LOCATION AS EXISTING. EXTEND EXISTING SANITARY AND SUPPLY PIPING TO NEW FIXTURE. MAKE ADJUSTMENTS AS NECESSARY.

PROVIDE NEW PLUMBING FIXTURE(S) AT SAME LOCATION AS

EXISTING. EXTEND EXISTING HOT AND COLD WATER SUPPLY

PIPING AND EXISTING SANITARY PIPING TO NEW FIXTURE.

INSTALL NEW RESTROOM/TOILET ACCESSORIES, SEE TOILET

ACCESSORIES SCHEDULE FOR MORE INFORMATION. ÍNFILL EXISTING WALL AT LOCATION OF DAMAGE OR

DEMOLITION TO MATCH ADJACENT CONSTRUCTION INCLUDING BUT NOT LIMITED TO METAL STUDS, GYPSUM WALLBOARD AND/OR TILE BACKER, AND WALL TILE. PREPARE FOR NEW FINISH. WHERE EXISTING RECESSED TOWEL DISPENSER IS REMOVED, INSTALL NEW HAND DRYER. SEE

ELECTRICAL RELATED NOTES FOR MORE DETAILS. REINSTALL EXISTING CEILING-MOUNTED LIGHT FIXTURE(S). REINSTALL EXISTING FIRE ALARM DEVICES, SPRINKLER HEADS, AND SPEAKER DEVICES INTO NEW CEILING. INSTALL NEW EXHAUST GRILLE AND/OR SUPPLY GRILLE. CAP DUCTWORK IF DIFFUSER/GRILLE IS NOT REPLACED. CONNEC

TO EXISTING DUCTWORK ABOVE CEILING. CONTRACTOR

RESPONSIBLE FOR REPLACEMENT OF BALANCING DAMPER IF

NECCESSARY. BALANCE TO INDICATED VALUE. CONTRACTOR SHALL RE-BALANCE EXHAUST FAN AS NECCESSARY

PAINT EXISTING DOOR FRAME IN ITS ENTIRETY, P-1, REFER TO

NEW FIXTURE. MAKE ADJUSTMENTS AS NECESSARY. REFER

TO 4/A0.1.8 FOR STAFF RR LAV DETAIL. NEW INSTALLED

RESTORE EXISTING TERRAZZO FLOOR FINISH TO LIKE NEW CONDITION. REFER TO TERRAZZO FLOORING RESTORATION

EXISTING TOILET PARTITION TO REMAIN, PAINT TO MATCH

PARTITION BELOW AT SAME LOCATION AND CONFIGURATION

TRANSITIONS, BACKSPLASHES, AND DOOR FRAMES. ALL LOCATIONS WHERE NEW FINISH ABUTS A DISSIMILAR

REMOVE AND REINSTALL EXISTING DEVICE FACEPLATES, SWITCH FACEPLATES, TECHNOLOGY FACEPLATES, AND

EXISTING ITEMS TO REMAIN AND NEW FINISHES APPLIED AROUND INCLUDE BUT NOT LIMITED TO THERMOSTATS,

EXPOSED EDGE OF NEW FLOOR FINISH TO EXISTING

PAINT ALL EXISTING INTERIOR DOOR FRAMES PER FINISH

PATCH AND REPAIR ALL HOLES AND IMPERFECTIONS, TO

OCCURS, TO BE TRS-2 FROM TOP OF TRS-1 BASE TO FULL

ALL WALLS WITHIN SCOPE OF WORK WHERE TILE

HEIGHT OF TILE, UNLESS NOTED OTHERWISE.

NEW TOILET PARTITIONS, P-3. PROVIDE NEW TOILET

INSTALL NEW HAND DRYER AT THIS LOCATION, SEE ELECTRICAL GENERAL NOTES FOR MORE DETAILS.

SEALANT SHALL BE APPLIED AT ALL MATERIAL

AND FIRE EXTINGUISHER CABINETS (UNO). PROVIDE NEW RESILIENT TRANSITION STRIPS AT

SCHEDULE ON SIDE(S) OF NEW WORK.

SPECIFICATION FOR ADDITIONAL INFORMATION. EXISTING STEEL TUBING AND METAL FRAMING ABOVE

AS EXISTING, TPP-1.

FINISH PLAN GENERAL NOTES

FLOOR FINISH.

RECEIVE NEW FINISHES.

LIST OF FINISHES FOR ADDITIONAL INFORMATION. INSTALL NEW HAND DRYER AT THE SAME LOCATION. RECONNECT TO SALVAGED ELECTRICAL CONNECTIONS. PROVIDE NEW PLUMBING FIXTURE(S) NEW PLASTIC LAMINATI ADA SINK BASE, PL-1 WITH SOLID SURFACE MATERIAL COUNTERTOP, SSM-1. EXTEND EXISTING HOT AND COLD WATER SUPPLY PIPING AND EXISTING SANITARY PIPING TO

ARCHITECTURAL PLAN NOTES

ALL DIMENSIONS ON FLOOR PLANS ARE TO FINISH FACE OF CMU, CONCRETE, BRICK OR FINISH FACE OF GWB AT METAL STUD WALLS, UNLESS NOTED OTHERWISE. EXCEPTION: EXTERIOR METAL STUD WALLS ARE TO FACE OF METAL STUDS. PROVIDE WOOD BLOCKING AS REQUIRED. WITHIN METAL STUD WALLS FOR WALL MOUNTED ITEMS.

PREPARE FOR NEW FINISH.

ASSEMBLY COMPLETELY.

AS NECESSARY. PATCH AND REPAIR WALL TO MATCH

REMOVE EXISTING RECESSED RESTROOM/TOILET

ADJACENT CONSTRUCTION. WHERE TILE WRAPS

WATER SUPPLY PIPING AND SANITARY PIPING BACK TO

CONDITION WARRANTS REPLACE IN ENTIRETY.

CONTRACTOR DISPOSING OF THEM OFF SITE.

(ALL NOTES MAY NOT BE INDICATED ON THIS SHEET)

DEMOLITION PLAN NOTES

INSTALLATION.

INSTALLATION.

ITEMS MADE OBSOLETE TO ACCOMODATE NEW

THE OWNER SHALL RESERVE RIGHT TO CLAIM ANY

RESTROOM RENOVATIONS PHASE II

ITEMS TO BE PATCHED. REMOVE ALL LOOSE OR DAMAGED GUION GREEK MIDDLE SCHOOL 4401 W 52ND ST

INDIANAPOLIS, IN 46254

LINCOLN MIDDLE SCHOOL 5353 W 71ST ST INDIANAPOLIS, IN 46268

NEW AUGUSTA NORTH PUBLIC ACADEMY 6450 RODEBAUGH RD **INDIANAPOLIS, IN 46268**

MSD OF PIKE TOWNSHIP





WWW.FHAI.COM 350 E. NEW YORK ST., SUITE 300 INDIANAPOLIS, IN 46204

KEY PLAN GUION CREEK MIDDLE SCHOOL

CONSTRUCTION DOCUMENTS

PROJECT MANAGER: PW DRAWN BY: HA/KMS PROJECT NUMBER: 223096.00 ISSUE DATE: 02.23.2024

NO.

1 ADDENDUM #1

DESCRIPTION


GCMS ENLARGED RESTROOM PLANS

ENLARGED DEOLITION - 155 & 156

SCALE: 1/4" = 1'-0"


SCALE: 1/4" = 1'-0"

ENLARGED CEILING PLAN - 155 & 156

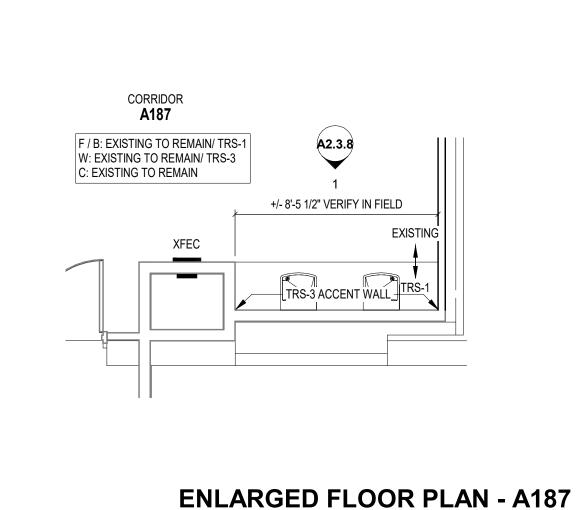


DRINKING FOUNTAIN

SCALE: 1/4" = 1'-0"

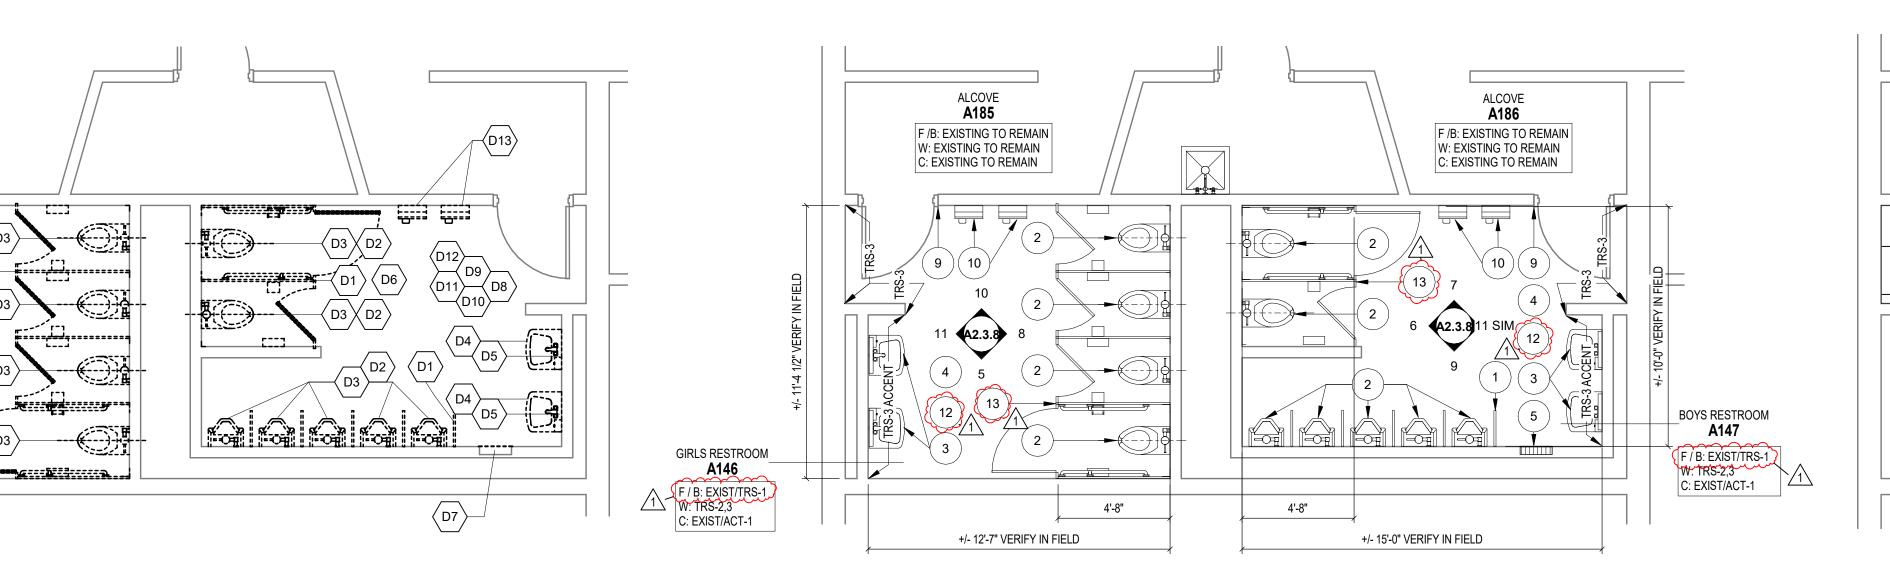

ENLARGED DEMOLITION - 146 & 147 SCALE: 1/4" = 1'-0"


ENLARGED FLOOR PLAN - A146 & 147 SCALE: 1/4" = 1'-0"

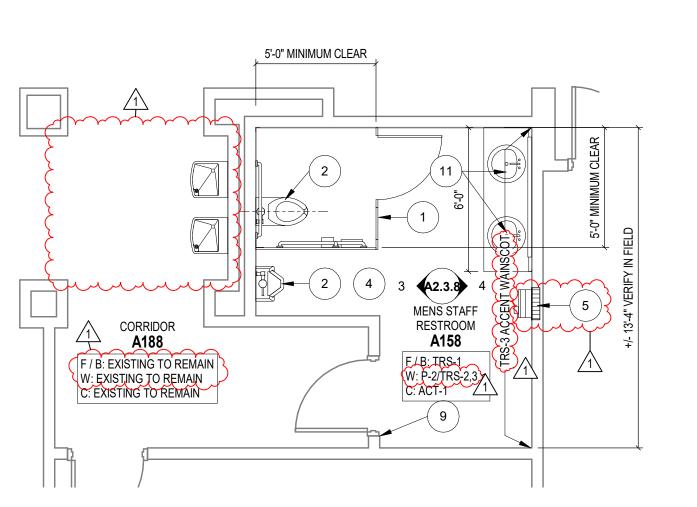

ENLARGED DEMOLITION - TYPICAL MENS STAFF RESTROOM

ENLARGED FLOOR PLAN - TYPICAL MENS STAFF RESTROOM SCALE: 1/4" = 1'-0"

ENLARGED CEILING PLAN - 146 & 147 SCALE: 1/4" = 1'-0"

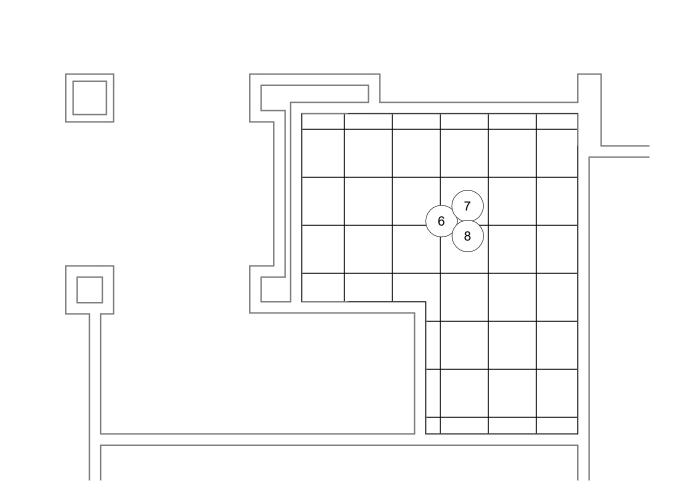

ENLARGED CEILING PLAN -TYPICAL MENS STAFF RESTROOM SCALE: 1/4" = 1'-0"

ARCHITECTURAL DEMOLITION GENERAL NOTES CONNECT EACH NEW-INSTALLED HAND DRYER TO THE DEMOLITION IS TO FOLLOW ESTABLISHED CONSTRUCTION NEAREST AVAILABLE DEDICATED 120V 20A BREAKER. SEQUENCE. CONTRACTOR IS TO VERIFY THEIR WORK IN THE FIELD WITH THE DEMOLITION DRAWINGS, NEW CONSTRUCTION DRAWINGS, AND THE EXISTING IN-FIELD CONDITIONS. REPORT DISCREPANCIES TO THE ARCHITECT

ELECTRICAL GENERAL NOTES

FLOOR FINISHES (F) / BASE FINISHES (B):

BASE COLOR SELECTION: 422 GREY

TILE RESTORATION SYSTEM
MATERIAL ABBREVIATION: TRS-2 (FIELD)

MATERIAL ABBREVIATION: TRS-3 (ACCENT)

MATERIAL ABBREVIATION: P-1 (DOOR FRAME)

MATERIAL MANUFACTURER: SHERWIN WILLIAMS

MATERIAL MANUFACTURER: SHERWIN WILLIAMS

MATERIAL MANUFACTURER: SEE SPECIFICATIONS.

MATERIAL MANUFACTURER: SEE SPECIFICATIONS.

MATERIAL MANUFACTURER: WILSONART/FORMICA/NEVAMAR

MATERIAL MANUFACTURER: CORIAN/MEGANITE/WILSONART

CONTRACTOR SHALL VERIFY ALL DIMENSIONS AND CLEARANCES

SHOULD DIFFERENT CONDITIONS BE ENCOUNTERED, CONTACT

AND ALL EXISTING FIELD CONDITIONS BEFORE STARTING

THE ARCHITECT BEFORE PROCEEDING WITH WORK.

CONSTRUCTION. COMMENCEMENT OF WORK CONSTITUTES

COLOR SELECTION: TO MATCH TOILET PARTITION FINISH

MATERIAL ABBREVIATION: P-3 (STEEL TUBE)

MATERIAL MANUFACTURER: SEE SPECS

COLOR SELECTION: MATCH EXISTING

MATERIAL ABBREVIATION: P-2 (FIELD)

COLOR SELECTION: TO BE SELECTED

SUSPENDED ACOUSTICAL TILE SYTEM

SUSPENDED ACOUSTICAL TILE SYTEM

MATERIAL ABBREVIATION: ACT-2

MATERIAL ABBREVIATION: ACT-1

COLOR SELECTION: WHITE

COLOR SELECTION: WHITE

PLASTIC LAMINATE (SINK BASE)

MATERIAL ABBREVIATION: PL-1

COLOR SELECTION: TO BE SELECTED

MATERIAL ABBREVIATION: SSM-1

MISCELLANEOUS FINISHES:

COLOR SELECTION: BLACK TEXTURE: GRIP EX

VERIFICATION NOTE

ACCEPTANCE OF CONDITIONS.

COLOR SELECTION: TO BE SELECTED

TOILET PARTITIONS / COMPARTMENTS MATERIAL ABBREVIATION: TPP-1

MATERIAL MANUFACTURER: SEE SPECIFICATIONS.

EQUIPMENT FINISHES:

CEILING FINISHES (C):

SIZE: 24" x 24"

SIZE: 24" x 48"

COLOR SELECTION: 452 WHITE

COLOR SELECTION: 469 BLUE

LIST OF FINISHES

WALL FINISHES (W):

TILE RESTORATION SYSTEM

PROVIDE BREAKER IN SPACE IF NEEDED.

AVAILABLE SPARE/SPACE ON SHEET A1.1.8A.

REFER TO ELECTRICAL ROOM LOCATIONS WITH

MATERIAL ABBREVIATION: TRS-1 (FLOOR AND BASE TO +/- 5"

MATERIAL MANUFACTURER: TILE RESTORATION SYSTEM

MATERIAL MANUFACTURER: TILE RESTORATION SYSTEM

MATERIAL MANUFACTURER: TILE RESTORATION SYSTEM

SANICHIP COLOR SELECTION: BLACK MARBLE 300

"FLOORING" DENOTES FLOOR COVERING MATERIALS INCLUDING BACKINGS, ADHESIVES, BASES, DOWN TO BUT EXCLUSIVE OF FLOOR SLABS AND STRUCTURAL MATERIALS, UNLESS NOTED OTHERWISE. "CEILING" DENOTES CEILING MATERIALS INCLUDING SUSPENSION SYSTEMS ADHESIVE RESIDUES, MOLDINGS, UP TO BUT EXCLUSIVE OF STRUCTURAL MATERIALS.

MECHANICAL AND ELECTRICAL ITEMS THAT ARE CAPPED AND ABANDONED SHALL BE LOCATED BEHIND FINAL FINISH SYSTEMS. CONTRACTOR TO FIELD VERIFY PORTIONS OR SECTIONS

OF EXISTING WALLS TO BE FILLED IN AND SALVAGE NECESSARY MATERIAL. MATERIALS OF DEMOLITION SHALL BE DISPOSED OF OFF-SITE UNLESS OTHERWISE DIRECTED BY OWNER. ITEMS TO BE PATCHED. REMOVE ALL LOOSE OR DAMAGED MATERIAL. REFINISH TO LIKE NEW CONDITION, OR IF CONDITION WARRANTS REPLACE IN ENTIRETY. THE OWNER SHALL RESERVE RIGHT TO CLAIM ANY MATERIALS THAT ARE BEING DEMOLISHED PRIOR TO THE CONTRACTOR DISPOSING OF THEM OFF SITE. ITEMS MADE OBSOLETE TO ACCOMODATE NEW CONSTRUCTION OR RENOVATION SHALL BE REMOVED. ITEMS TO BE REMOVED SHALL BE REMOVED IN THEIR

AFTER REMOVAL OF ITEMS, THE EXISTING WALL AND CEILING SURFACES (IF EXPOSED) SHALL BE

REPAIRED/PATCHED AS REQUIRED TO RECEIVE NEW

DEMOLITION PLAN NOTES (ALL NOTES MAY NOT BE INDICATED ON THIS SHEET)

> REMOVE EXISTING TOILET PARTITIONS AND ALL PARTITION MOUNTED ACCESSORIES COMPLETELY. PATCH/REPAIR FLOOR AND WALL AS NECESSARY, PREPARE FOR NEW FINISH. IF APPLICABLE, EXISTING TUBE STEEL TOPS SUPPORTS AND METAL FRAMING ABOVE TO REMAIN REMOVE EXISTING PLUMBING FIXTURE(S). COORDINATE EXTENTS OF DEMOLITION WITH NEW WORK, CAP ALL UNUSED PLUMBING. SALVAGE FLUSH VALVES FOR OWNER'S RIGHT OF FIRST REFUSAL BEFORE DISPOSAL REMOVE EXISTING SANITARY AND SUPPLY PIPING BACK TO THE CHASE WALL AND PREPARE FOR NEW FIXTURE

INSTALLATION. DISCONNECT AND REMOVE EXISTING HOT AND COLD WATER SUPPLY PIPING AND SANITARY PIPING BACK TO THE CHASE WALL AND PREPARE FOR NEW FIXTURE INSTALLATION. REMOVE EXISTING RESTROOM/TOILET ACCESSORIES

COMPLETELY. PATCHAND REPAIR WALL TO MATCH ADJACENT CONSTRUCTION AND PREPARE FOR NEW CONFIRM EXISTANCE AND LOCATION OF FLOOR DRAIN. EXISTING FLOOR DRAIN TO REMAIN. CONTRACTOR SHALL CLEAN FLOOR DRAIN TO LIKE NEW CONDITION. REMOVE EXISTING RECESSED RESTROOM/TOILET

ACCESSORY COMPLETELY AND SURROUNDING WALL TILE AS NECESSARY. PATCH AND REPAIR WALL TO MATCH ADJACENT CONSTRUCTION. WHERE TILE WRAPS RECESSED TOILET ACCESSORY, SALVAGE BULLNOSE TRIM TO BE REINSTALLED TO MATCH ADJACENT WAINSCOT HEIGHT AND INSTALLATION, AND PREPARE FOR NEW REMOVE EXISTING DAMAGED FLOOR AND/OR WALL TILE AS NECESSARY, ASSUME 5% OF FLOOR/WALL, PATCH AND REPAIR WALL TO MATCH ADJACENT CONSTRUCTION AND

PREPARE FOR NEW FINISH. REMOVE EXISTING SUSPENDED ACOUSTICAL CEILING TILE ASSEMBLY COMPLETELY. REMOVE EXISTING SUPPLY DIFFUSERS AND/OR EXHAUST GRILLES. PREPARE FOR INSTALLATION OF NEW DIFFUSER/GRILLE. EXISTING DUCTWORK TO REMAIN, ADJUST AS NECCESSARY FOR NEW DIFFUSER/GRILLES 11 TEMPORARILY SUSPEND EXISTING CEILING-MOUNTED

LIGHT FIXTURES AS NECESSARY FOR CEILING WORK. D12 EXISTING FIRE ALARM DEVICES, SPRINKLER HEADS, AND SPEAKER DEVICES TO REMAIN. TEMPORARILY DISCONNECT AND STORE OR SUPPORT IN PLACE AS NECESSARY UNTIL NEW CEILING IS INSTALLED. REMOVE EXISTING HAND DRYER. SALVAGE EXISTING WIRE CONNECTIONS TO INSTALL NEW HAND DRYER.

D14 DEMOLISH PLUMBING FIXTURE (S) AND PLASTIC LAMINATE COUNTERTOP. VERIFY COUNTER TOP LENGTH PRIOR TO

ARCHITECTURAL PLAN GENERAL NOTES ALL DIMENSIONS ON FLOOR PLANS ARE TO FINISH FACE OF CMU, CONCRETE, BRICK OR FINISH FACE OF GWB AT METAL STUD WALLS. UNLESS NOTED OTHERWISE. EXCEPTION: EXTERIOR METAL STUD WALLS ARE TO FACE OF METAL STUDS. PROVIDE WOOD BLOCKING AS REQUIRED. WITHIN METAL STUD WALLS FOR WALL MOUNTED ITEMS.

ARCHITECTURAL PLAN NOTES (ALL NOTES MAY NOT BE INDICATED ON THIS SHEET) **DESCRIPTION**

PROVIDE NEW TOILET PARTITION AT SAME LOCATION AND CONFIGURATION AS EXISTING, TPP-1. PROVIDE NEW PLUMBING FIXTURE(S) AT SAME LOCATION AS EXISTING. EXTEND EXISTING SANITARY AND SUPPLY PIPING TO NEW FIXTURE. MAKE ADJUSTMENTS AS NECESSARY. PROVIDE NEW PLUMBING FIXTURE(S) AT SAME LOCATION AS EXISTING. EXTEND EXISTING HOT AND COLD WATER SUPPLY PIPING AND EXISTING SANITARY PIPING TO NEW FIXTURE. MAKE ADJUSTMENTS AS NECESSARY.

INSTALL NEW RESTROOM/TOILET ACCESSORIES, SEE TOILET ACCESSORIES SCHEDULE FOR MORE INFORMATION. INFILL EXISTING WALL AT LOCATION OF DAMAGE OR DEMOLITION TO MATCH ADJACENT CONSTRUCTION INCLUDING BUT NOT LIMITED TO METAL STUDS, GYPSUM WALLBOARD AND/OR TILE BACKER, AND WALL TILE. PREPARE FOR NEW FINISH. WHERE EXISTING RECESSED TOWEL DISPENSER IS REMOVED, INSTALL NEW HAND DRYER. SEE ELECTRICAL RELATED NOTES FOR MORE DETAILS.

REINSTALL EXISTING CEILING-MOUNTED LIGHT FIXTURE(S) REINSTALL EXISTING FIRE ALARM DEVICES, SPRINKLER HEADS, AND SPEAKER DEVICES INTO NEW CEILING. INSTALL NEW EXHAUST GRILLE AND/OR SUPPLY GRILLE. CAP DUCTWORK IF DIFFUSER/GRILLE IS NOT REPLACED. CONNECT TO EXISTING DUCTWORK ABOVE CEILING. CONTRACTOR RESPONSIBLE FOR REPLACEMENT OF BALANCING DAMPER IF NECCESSARY. BALANCE TO INDICATED VALUE. CONTRACTOR SHALL RE-BALANCE EXHAUST FAN AS NECCESSARY PAINT EXISTING DOOR FRAME IN IT'S ENTIRETY, P-1. REFER TO LIST OF FINISHES FOR ADDITIONAL INFORMATION. INSTALL NEW HAND DRYER AT THE SAME LOCATION. RECONNECT TO SALVAGED ELECTRICAL CONNECTIONS.

PROVIDE NEW PLUMBING FIXTURE(S) NEW PLASTIC LAMINATE ADA SINK BASE, PL-1 WITH SOLID SURFACE MATERIAL COUNTERTOP, SSM-1. EXTEND EXISTING HOT AND COLD WATER SUPPLY PIPING AND EXISTING SANITARY PIPING TO NEW FIXTURE. MAKE ADJUSTMENTS AS NECESSARY. REFER TO 4/A0.1.8 FOR STAFF RR LAV DETAIL. NEW INSTALLED COUNTERTOP TO MATCH DEMOLISHED LENGTH LENGTH. ŘESTORE EXISTING TEŘRAZŽO FLOOŘ FINÍSH ŤO LÍKE NĚW CONDITION. REFER TO TERRAZZO FLOORING RESTORATION : SPECIFICATION FOR ADDITIONAL INFORMATION. EXISTING STEEL TUBING AND METAL FRAMING ABOVE EXISTING TOILET PARTITION TO REMAIN, PAINT TO MATCH NEW TOILET PARTITIONS, P-3, PROVIDE NEW TOILET

PARTITION BELOW AT SAME LOCATION AND CONFIGURATION AS EXISTING, TPP-1. INSTALL NEW HAND DRYER AT THIS LOCATION, SEE ELECTRICAL GENERAL NOTES FOR MORE DETAILS.

FINISH PLAN GENERAL NOTES

SEALANT SHALL BE APPLIED AT ALL MATERIAL TRANSITIONS, BACKSPLASHES, AND DOOR FRAMES. ALL LOCATIONS WHERE NEW FINISH ABUTS A DISSIMILAR

REMOVE AND REINSTALL EXISTING DEVICE FACEPLATES, SWITCH FACEPLATES, TECHNOLOGY FACEPLATES, AND EXISTING ITEMS TO REMAIN AND NEW FINISHES APPLIED

AROUND INCLUDE BUT NOT LIMITED TO THERMOSTATS, AND FIRE EXTINGUISHER CABINETS (UNO). PROVIDE NEW RESILIENT TRANSITION STRIPS AT EXPOSED EDGE OF NEW FLOOR FINISH TO EXISTING

PAINT ALL EXISTING INTERIOR DOOR FRAMES PER FINISH SCHEDULE ON SIDE(S) OF NEW WORK. PATCH AND REPAIR ALL HOLES AND IMPERFECTIONS, TO RECEIVE NEW FINISHES. ALL WALLS WITHIN SCOPE OF WORK WHERE TILE OCCURS, TO BE TRS-2 FROM TOP OF TRS-1 BASE TO FULL HEIGHT OF TILE, UNLESS NOTED OTHERWISE.

RENOVATIONS PHASE II

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GUION GREEK MIDDLE SCHOOL 4401 W 52ND ST

INDIANAPOLIS, IN 46254

LINCOLN MIDDLE SCHOOL 5353 W 71ST ST INDIANAPOLIS, IN 46268

NEW AUGUSTA NORTH PUBLIC ACADEMY 6450 RODEBAUGH RD INDIANAPOLIS, IN 46268


MSD OF PIKE TOWNSHIP



<u>ARCHITECT</u>



WWW.FHAI.COM 350 E. NEW YORK ST., SUITE 300 INDIANAPOLIS, IN 46204

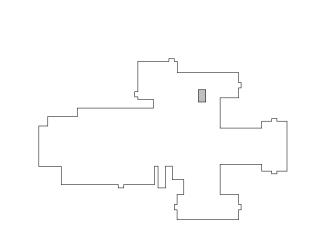

KEY PLAN GUION CREEK MIDDLE SCHOOL


CONSTRUCTION DOCUMENTS

PROJECT MANAGER: PW DRAWN BY: HA/KMS PROJECT NUMBER: 223096.00 ISSUE DATE: 02.23.2024

DESCRIPTION ADDENDUM #1

> **GCMS ENLARGED RESTROOM PLANS**

SCALE: 1/4" = 1'-0"

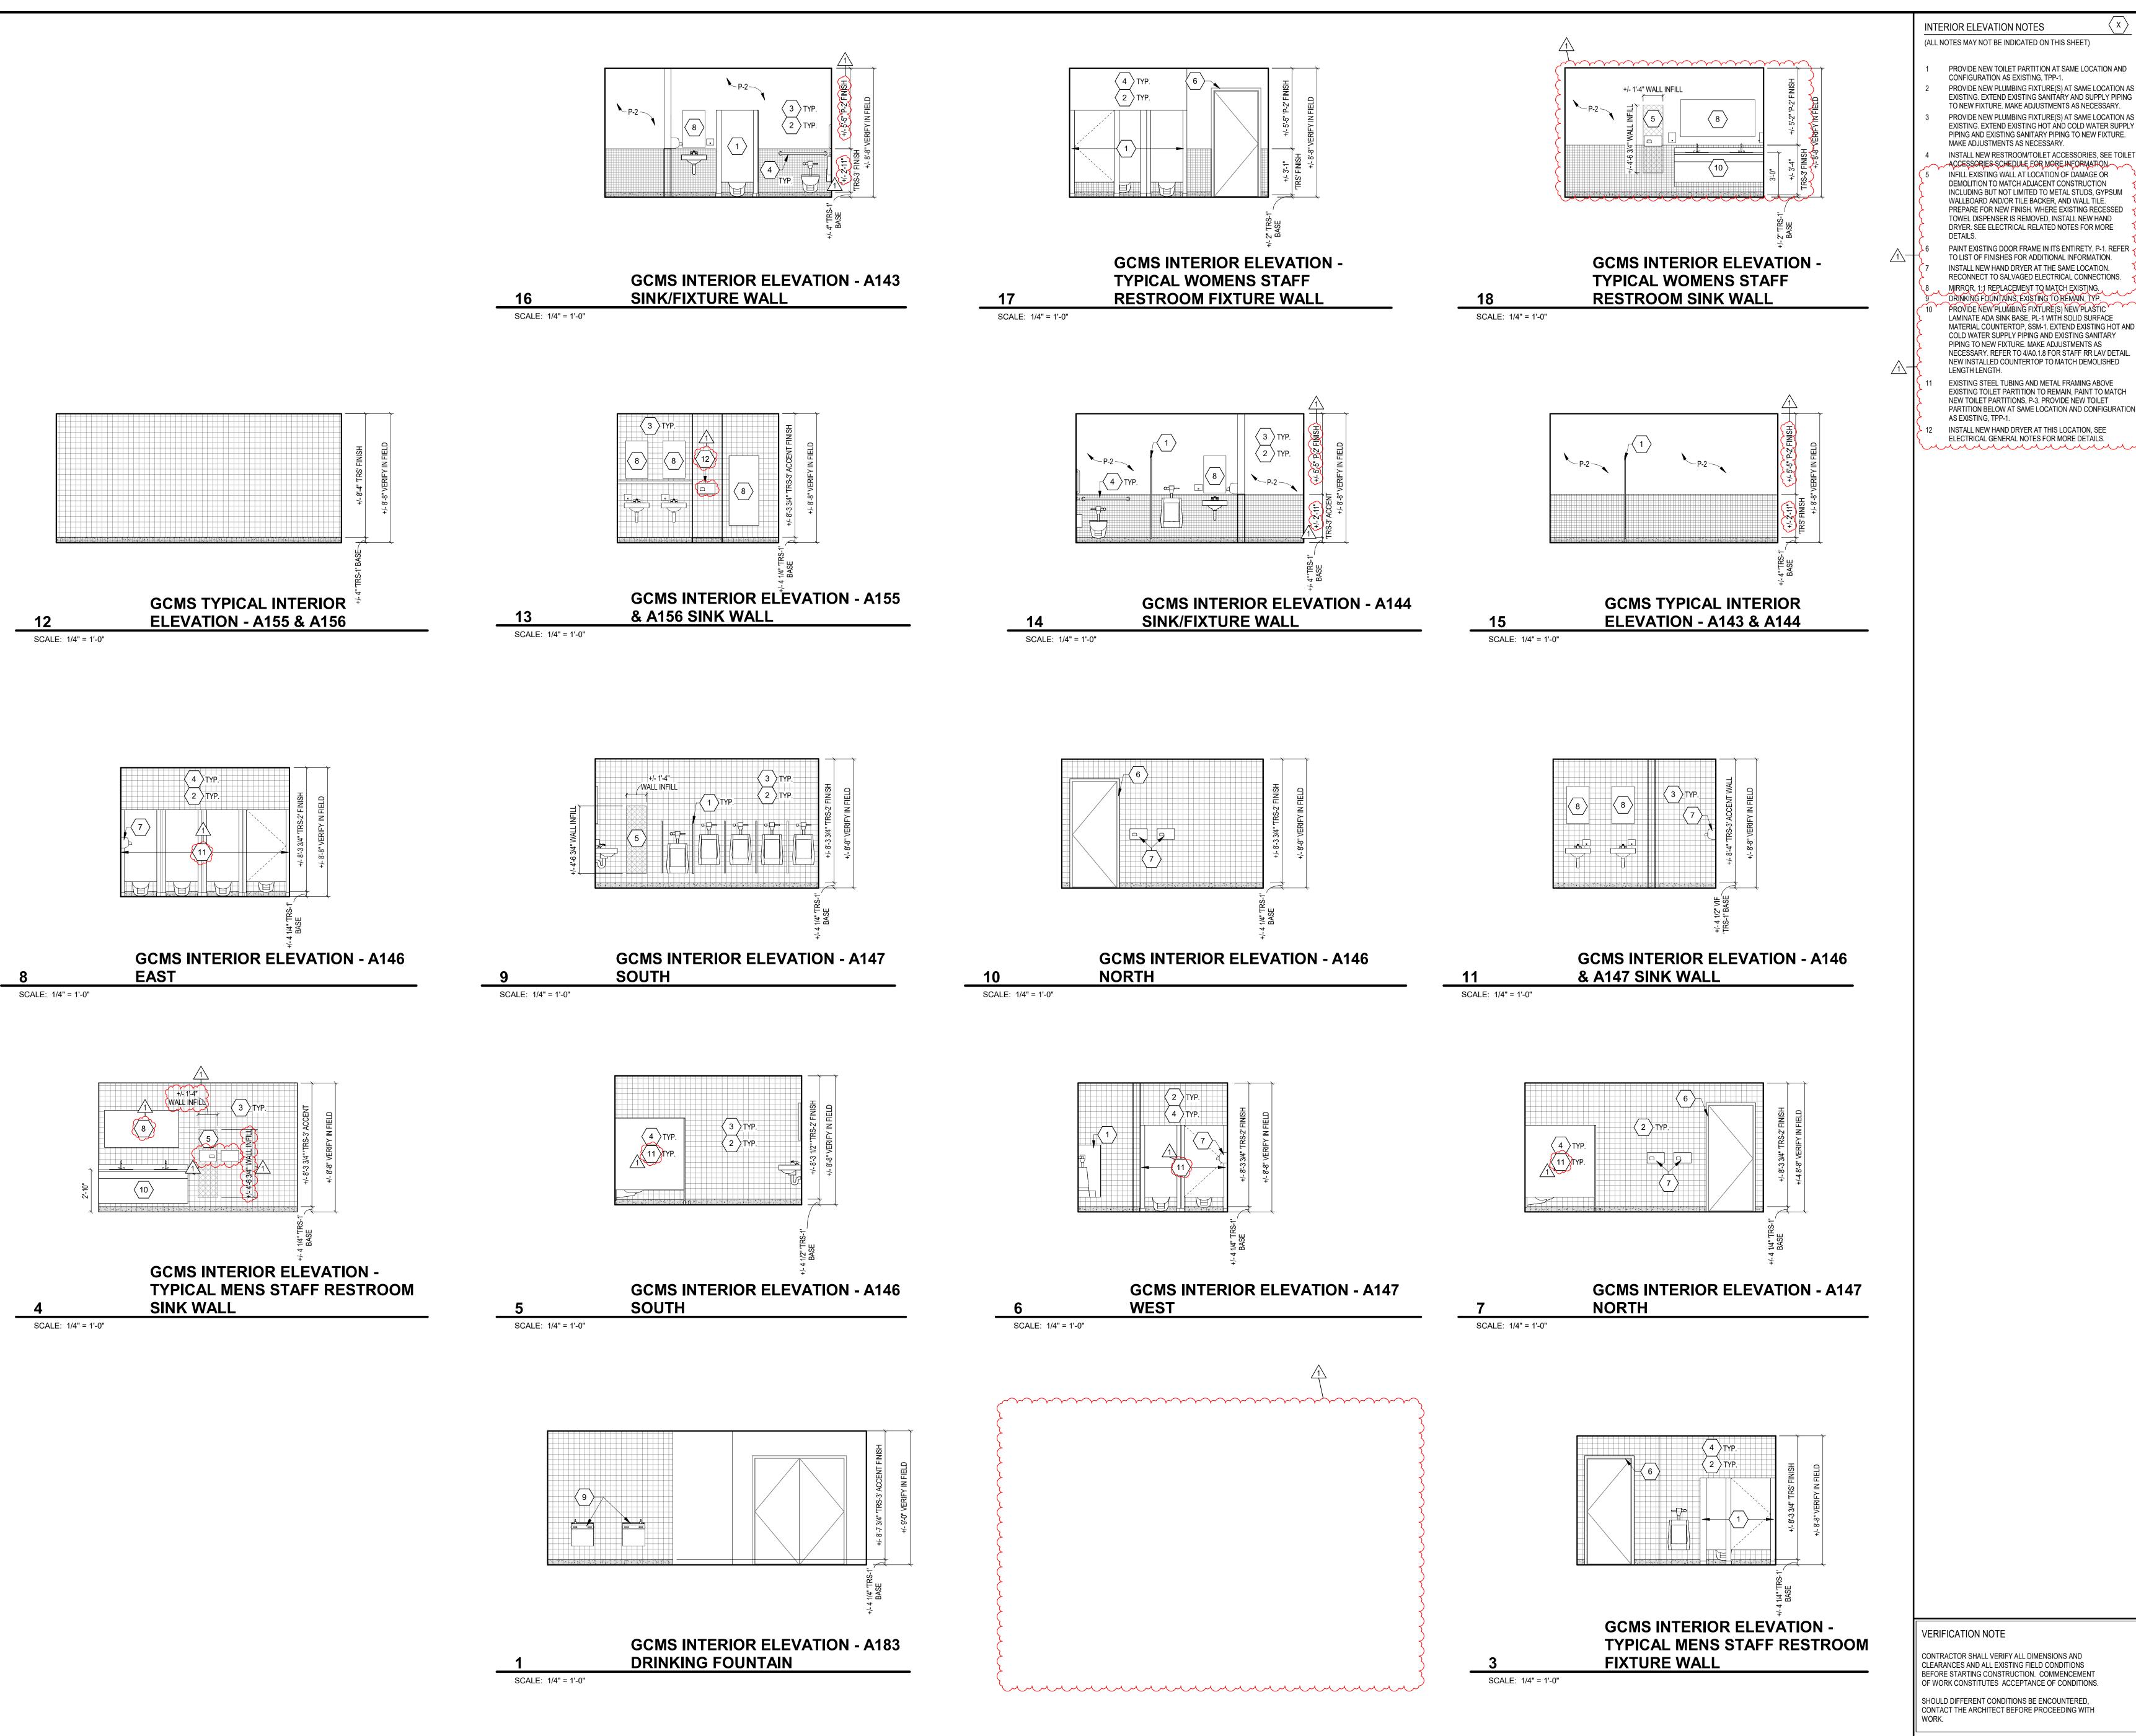

GCMS, LMS, RESTROOM RENOVATIONS PHASE II

GUION GREEK MIDDLE SCHOOL 4401 W 52ND ST INDIANAPOLIS, IN 46254

LINCOLN MIDDLE SCHOOL 5353 W 71ST ST INDIANAPOLIS, IN 46268


NEW AUGUSTA NORTH PUBLIC MATERIAL COUNTERTOP, SSM-1. EXTEND EXISTING HOT AND ACADEMY NECESSARY, REFER TO 4/A0.1.8 FOR STAFF RR LAV DETAIL. 6450 RODEBAUGH RD NEW INSTALLED COUNTERTOP TO MATCH DEMOLISHED INDIANAPOLIS, IN 46268

EXISTING TOILET PARTITION TO REMAIN, PAINT TO MATCH MSD OF PIKE TOWNSHIP PARTITION BELOW AT SAME LOCATION AND CONFIGURATION





WWW.FHAI.COM 350 E. NEW YORK ST., SUITE 300 INDIANAPOLIS, IN 46204

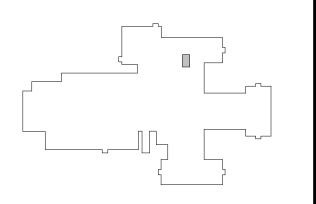


KEY PLAN GUION CREEK MIDDLE SCHOOL

CONSTRUCTION DOCUMENTS

PROJECT MANAGER: PW DRAWN BY: KMS PROJECT NUMBER: 223096.00 ISSUE DATE: 02.23.2024

CONTRACTOR SHALL VERIFY ALL DIMENSIONS AND CLEARANCES AND ALL EXISTING FIELD CONDITIONS BEFORE STARTING CONSTRUCTION. COMMENCEMENT OF WORK CONSTITUTES ACCEPTANCE OF CONDITIONS. **GCMS RESTROOM INTERIOR ELEVATIONS**

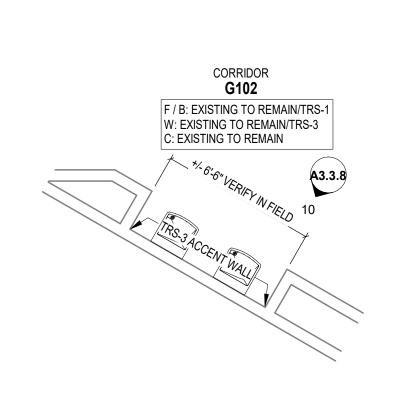

ENLARGED FLOOR PLAN - G102 DRINKING FOUNTAIN

CORRIDOR G110 F / B: EXISTING TO REMAIN/TRS-1 W: EXISTING TO REMAIN/TRS-3 C: EXISTING TO REMAIN

ENLARGED FLOOR PLAN - G110 DRINKING FOUNTAIN

+/- 12'-0" VERIFY IN FIELD

GIRLS RESTROOM

F / B: TRS-1

W: TRS-2,3

SCALE: 1/4" = 1'-0"


C: EXIST/ACT-1


C127

5'-0" MINIMUM CLEAR


SCALE: 1/4" = 1'-0"


TRS-3 ACCENT WALL +/- 6'-8" VERIFY IN FIELD CORRIDOR C130 A3.3.8 F / B: EXISTING TO REMAIN/TRS-1 W: EXISTING TO REMAIN/TRS-3 C: EXISTING TO REMAIN

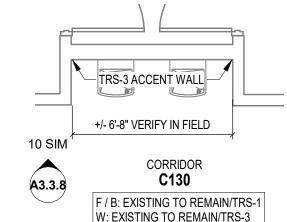

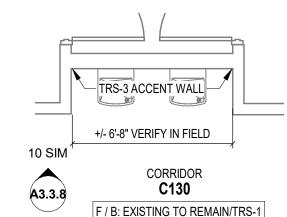


ENLARGED FLOOR PLAN - C124 & C125

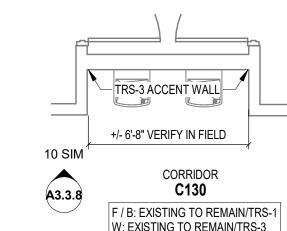

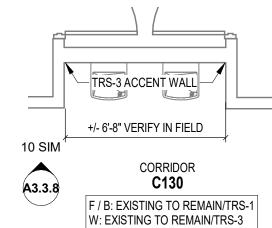


MATERIAL ABBREVIATION: SSM-1 MATERIAL MANUFACTURER: CORIAN/MEGANITE/WILSONART COLOR SELECTION: TO BE SELECTED MISCELLANEOUS FINISHES:

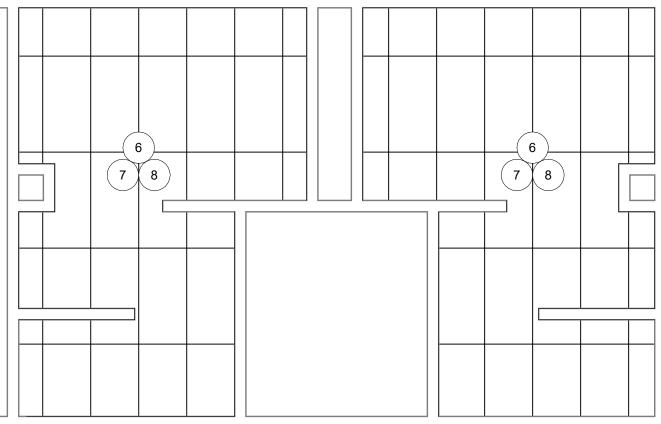


SCALE: 1/4" = 1'-0"



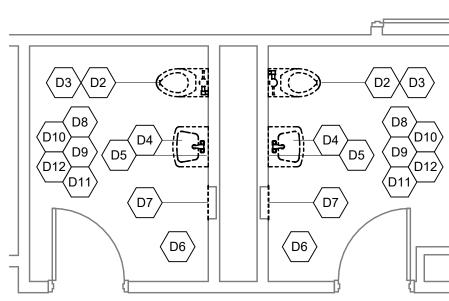

ENLARGED DEMOLITION - D118 & D119

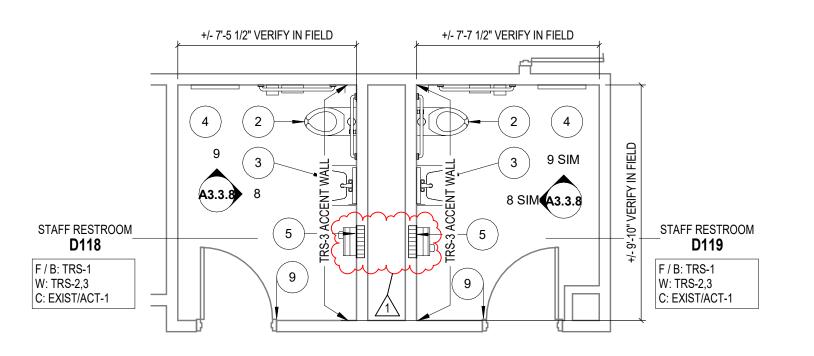


F / B: EXISTING TO REMAIN

W: EXISTING TO REMAIN

C: EXISTING TO REMAIN

ENLARGED FLOOR PLAN - D118 & D119 SCALE: 1/4" = 1'-0"

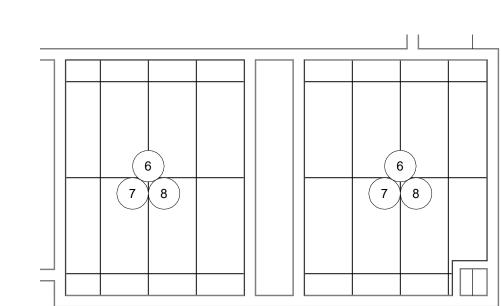

ENLARGED CEILING PLAN - D118 & D119

ARCHITECTURAL DEMOLITION GENERAL NOTES DEMOLITION IS TO FOLLOW ESTABLISHED CONSTRUCTION

ÉLECTRICAL GENERAL NOTES

FLOOR FINISHES (F) / BASE FINISHES (B):

BASE COLOR SELECTION: 422 GREY

MATERIAL ABBREVIATION: TRS-2 (FIELD)

MATERIAL ABBREVIATION: TRS-3 (ACCENT)

MATERIAL ABBREVIATION: P-1 (DOOR FRAME)

MATERIAL MANUFACTURER: SHERWIN WILLIAMS

MATERIAL MANUFACTURER: SHERWIN WILLIAMS

MATERIAL MANUFACTURER: SEE SPECIFICATIONS.

MATERIAL MANUFACTURER: SEE SPECIFICATIONS.

MATERIAL MANUFACTURER: WILSONART/FORMICA/NEVAMAR

MATERIAL MANUFACTURER: SEE SPECS

COLOR SELECTION: MATCH EXISTING

MATERIAL ABBREVIATION: P-2 (FIELD)

COLOR SELECTION: TO BE SELECTED

COLOR SELECTION: TO BE SELECTED

SUSPENDED ACOUSTICAL TILE SYTEM MATERIAL ABBREVIATION: ACT-1

SUSPENDED ACOUSTICAL TILE SYTEM MATERIAL ABBREVIATION: ACT-2

CEILING FINISHES (C):

SIZE: 24" x 24"

SIZE: 24" x 48"

COLOR SELECTION: WHITE

COLOR SELECTION: WHITE

PLASTIC LAMINATE (SINK BASE)

MATERIAL ABBREVIATION: PL-1

COLOR SELECTION: TO BE SELECTED

TOILET PARTITIONS / COMPARTMENTS

MATERIAL MANUFACTURER: SEE SPECIFICATIONS.

CONTRACTOR SHALL VERIFY ALL DIMENSIONS AND CLEARANCES

SHOULD DIFFERENT CONDITIONS BE ENCOUNTERED, CONTACT

AND ALL EXISTING FIELD CONDITIONS BEFORE STARTING

THE ARCHITECT BEFORE PROCEEDING WITH WORK.

CONSTRUCTION. COMMENCEMENT OF WORK CONSTITUTES

MATERIAL ABBREVIATION: TPP-1

COLOR SELECTION: BLACK

TEXTURE: GRIP EX

VERIFICATION NOTE

ACCEPTANCE OF CONDITIONS.

SOLID SURFACE MATERIAL (COUNTERTOP

EQUIPMENT FINISHES:

MATERIAL ABBREVIATION: P-3 (RR ACCENT)

LIST OF FINISHES

WALL FINISHES (W):

TILE RESTORATION SYSTEM

COLOR SELECTION: 452 WHITE

COLOR SELECTION: 469 BLUE

CONNECT EACH NEW-INSTALLED HAND DRYER TO THE NEAREST AVAILABLE DEDICATED 120V 20A BREAKER.

PROVIDE BREAKER IN SPACE IF NEEDED.

REFER TO ELECTRICAL ROOM LOCATIONS WITH

AVAILABLE SPARE/SPACE ON SHEET A1.1.8B.

TILE RESTORATION SYSTEM
MATERIAL ABBREVIATION: TRS-1 (FLOOR AND BASE TO +/- 5"

MATERIAL MANUFACTURER: TILE RESTORATION SYSTEM

MATERIAL MANUFACTURER: TILE RESTÓRATION SYSTEM

MATERIAL MANUFACTURER: TILE RESTORATION SYSTEM

SANICHIP COLOR SELECTION: BLACK MARBLE 300

SEQUENCE. CONTRACTOR IS TO VERIFY THEIR WORK IN THE FIELD WITH THE DEMOLITION DRAWINGS, NEW CONSTRUCTION DRAWINGS, AND THE EXISTING IN-FIELD CONDITIONS, REPORT DISCREPANCIES TO THE ARCHITECT "FLOORING" DENOTES FLOOR COVERING MATERIALS INCLUDING BACKINGS, ADHESIVES, BASES, DOWN TO BUT EXCLUSIVE OF FLOOR SLABS AND STRUCTURAL

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RENOVATIONS

GUION GREEK MIDDLE SCHOOL

4401 W 52ND ST

5353 W 71ST ST

ACADEMY

INDIANAPOLIS, IN 46254

INDIANAPOLIS, IN 46268

6450 RODEBAUGH RD

INDIANAPOLIS, IN 46268

LINCOLN MIDDLE SCHOOL

NEW AUGUSTA NORTH PUBLIC

MSD OF PIKE TOWNSHIP

350 E. NEW YORK ST., SUITE 300 INDIANAPOLIS, IN 46204

LINCOLN MIDDLE SCHOOL

PROJECT MANAGER: PW

PROJECT NUMBER: 223096.00 PROJECT ISSUE DATE: 02.23.2024

ADDENDUM #1

DESCRIPTION

03.08.2024

DRAWN BY: HA/KMS

CONSTRUCTION DOCUMENTS

WWW.FHAI.COM

MATERIALS, UNLESS NOTED OTHERWISE. "CEILING" DENOTES CEILING MATERIALS INCLUDING SUSPENSION SYSTEMS ADHESIVE RESIDUES, MOLDINGS,

UP TO BUT EXCLUSIVE OF STRUCTURAL MATERIALS. MECHANICAL AND ELECTRICAL ITEMS THAT ARE CAPPED AND ABANDONED SHALL BE LOCATED BEHIND FINAL FINIS SYSTEMS. CONTRACTOR TO FIELD VERIFY PORTIONS OR SECTIONS OF EXISTING WALLS TO BE FILLED IN AND SALVAGE NECESSARY MATERIAL. MATERIALS OF DEMOLITION SHALL BE DISPOSED OF OFF-

SITE UNLESS OTHERWISE DIRECTED BY OWNER. ITEMS TO BE PATCHED. REMOVE ALL LOOSE OR DAMAGED MATERIAL. REFINISH TO LIKE NEW CONDITION, OR IF CONDITION WARRANTS REPLACE IN ENTIRETY. THE OWNER SHALL RESERVE RIGHT TO CLAIM ANY MATERIALS THAT ARE BEING DEMOLISHED PRIOR TO THE CONTRACTOR DISPOSING OF THEM OFF SITE.

ITEMS MADE OBSOLETE TO ACCOMODATE NEW CONSTRUCTION OR RENOVATION SHALL BE REMOVED. ITEMS TO BE REMOVED SHALL BE REMOVED IN THEIR AFTER REMOVAL OF ITEMS, THE EXISTING WALL AND CEILING SURFACES (IF EXPOSED) SHALL BE REPAIRED/PATCHED AS REQUIRED TO RECEIVE NEW

DEMOLITION PLAN NOTES

(ALL NOTES MAY NOT BE INDICATED ON THIS SHEET) **DESCRIPTION**

> REMOVE EXISTING TOILET AND ALL PARTITION MOUNTED ACCESSORIES COMPLETELY. PATCH/REPAIR FLOOR AND WALL AS NECESSARY, PREPARE FOR NEW FINISH. IF APPLICABLE, EXISTING TUBE STEEL TOPS SUPPORTS AND METAL FRAMING ABOVE TO REMAIN. REMOVE EXISTING PLUMBING FIXTURE(S). COORDINATE EXTENTS OF DEMOLITION WITH NEW WORK, CAP ALL

UNUSED PLUMBING. SALVAGE FLUSH VALVES FOR

OWNER'S RIGHT OF FIRST REFUSAL BEFORE DISPOSAL

REMOVE EXISTING SANITARY AND SUPPLY PIPING BACK TO THE CHASE WALL. PREPARE FOR NEW FIXTURE INSTALLATION. D4 DISCONNECT AND REMOVE EXISTING HOT AND COLD WATER SUPPLY PIPING AND SANITARY PIPING BACK TO THE

CHASE WALL AND PREPARE FOR NEW FIXTURE INSTALLATION. REMOVE EXISTING RESTROOM/TOILET ACCESSORIES

COMPLETELY. PATCHAND REPAIR WALL TO MATCH ADJACENT CONSTRUCTION AND PREPARE FOR NEW

D6 CONFIRM EXISTANCE AND LOCATION OF FLLOR DRAIN. EXISTING FLOOR DRAIN TO REMAIN. CONTRACTOR SHALL CLEAN FLOOR DRAIN TO LIKE NEW CONDITION. REMOVE EXISTING RECESSED RESTROOM/TOILET ACCESSORY COMPLETELY AND SURROUNDING WALL TILE AS NECESSARY. PATCH AND REPAIR WALL TO MATCH ADJACENT CONSTRUCTION. WHERE TILE WRAPS

HEIGHT AND INSTALLATION, AND PREPARE FOR NEW REMOVE EXISTING DAMAGED FLOOR AND/OR WALL TILE AS NECESSARY, ASSUME 5% OF FLOOR/WALL, PATCH AND REPAIR WALL TO MATCH ADJACENT CONSTRUCTION AND PREPARE FOR NEW FINISH.

RECESSED TOILET ACCESSORY, SALVAGE BULLNOSE TRIM-

TO BE REINSTALLED TO MATCH ADJACENT WAINSCOT

D9 REMOVE EXISTING SUSPENDED ACOUSTICAL CEILING TILE ASSEMBLY COMPLETELY. D10 REMOVE EXISTING SUPPLY DIFFUSERS AND/OR EXHAUST GRILLES. PREPARE FOR INSTALLATION OF NEW DIFFUSER/GRILLE. EXISTING DUCTWORK TO REMAIN, ADJUST AS NECCESSARY FOR NEW DIFFUSER/GRILLES.

TEMPORARILY SUSPEND EXISTING CEILING-MOUNTED LIGHT FIXTURES AS NECESSARY FOR CEILING WORK. D12 EXISTING FIRE ALARM DEVICES, SPRINKLER HEADS, AND SPEAKER DEVICES TO REMAIN. TEMPORARILY DISCONNECT AND STORE OR SUPPORT IN PLACE AS NECESSARY UNTIL NEW CEILING IS INSTALLED.

D13 REMOVE EXISTING HAND DRYER. SALVAGE EXISTING WIRE CONNECTIONS TO INSTALL NEW HAND DRYER. D14 DEMOLISH PLUMBING FIXTURE (S) AND PLASTIC LAMINATE COUNTERTOP. VERIFY COUNTER TOP LENGTH PRIOR TO

ARCHITECTURAL PLAN GENERAL NOTES ALL DIMENSIONS ON FLOOR PLANS ARE TO FINISH FACE OF CMU, CONCRETE, BRICK OR FINISH FACE OF GWB AT METAL STUD WALLS, UNLESS NOTED OTHERWISE. EXCEPTION: EXTERIOR METAL STUD WALLS ARE TO FACE OF METAL STUDS. PROVIDE WOOD BLOCKING AS REQUIRED. WITHIN

METAL STUD WALLS FOR WALL MOUNTED ITEMS. ARCHITECTURAL PLAN NOTES

(ALL NOTES MAY NOT BE INDICATED ON THIS SHEET) **DESCRIPTION**

PROVIDE NEW TOILET PARTITION AT SAME LOCATION AND CONFIGURATION AS EXISTING, TPP-1. PROVIDE NEW PLUMBING FIXTURE(S) AT SAME LOCATION AS EXISTING. EXTEND EXISTING SANITARY AND SUPPLY PIPING TO NEW FIXTURE. MAKE ADJUSTMENTS AS NECESSARY. PROVIDE NEW PLUMBING FIXTURE(S) AT SAME LOCATION AS EXISTING. EXTEND EXISTING HOT AND COLD WATER SUPPLY PIPING AND EXISTING SANITARY PIPING TO NEW FIXTURE. MAKE ADJUSTMENTS AS NECESSARY.

INSTALL NEW RESTROOM/TOILET ACCESSORIES, SEE TOILET ACCESSORIES SCHEDULE FOR MORE INFORMATION. INFILL EXISTING WALL AT LOCATION OF DAMAGE OR DEMOLITION TO MATCH ADJACENT CONSTRUCTION INCLUDING BUT NOT LIMITED TO METAL STUDS, GYPSUM WALLBOARD AND/OR TILE BACKER, AND WALL TILE. PREPARE FOR NEW FINISH. WHERE EXISTING RECESSED TOWEL DISPENSER IS REMOVED, INSTALL NEW HAND DRYER, UNLESS NOTED TO BE INSTALLED IN A DIFFERENT LOCATION. SEE ELECTRICAL RELATED NOTES FOR ADDITIONAL DETAILS. REINSTALL EXISTING CEILING-MOUNTED LIGHT FIXTURE. ~REINSTALL/EXISTING PIRE-ALARM DEVICES, SPRINKLER HEADS, AND SPEAKER DEVICES INTO NEW CEILING. INSTALL NEW EXHAUST GRILLE AND/OR SUPPLY GRILLE. CAP

DUCTWORK IF DIFFUSER/GRILLE IS NOT REPLACED. CONNECT TO EXISTING DUCTWORK ABOVE CEILING. CONTRACTOR RESPONSIBLE FOR REPLACEMENT OF BALANCING DAMPER IF NECCESSARY. BALANCE TO INDICATED VALUE. CONTRACTOR SHALL RE-BALANCE EXHAUST FAN AS NECCESSARY. PAINT EXISTING DOOR FRAME IN ITS ENTIRETY, P-1. REFER

TO LIST OF FINISHED FOR ADDITIONAL INFORMATION INSTALL NEW HAND DRYER AT THE SAME LOCATION. , RECONNECT TO SALVAGED ELECTRICAL CONNECTIONS. PROVIDE NEW PLUMBING FIXTURE(S) NEW PLASTIC LAMINATE ADA SINK BASE, PL-1 WITH SOLID SURFACE MATERIAL COUNTERTOP, SSM-1. EXTEND EXISTING HOT AND COLD WATER SUPPLY PIPING AND EXISTING SANITARY PIPING TO NEW FIXTURE. MAKE ADJUSTMENTS AS

NECESSARY. REFER TO 4/A0.1.8 FOR STAFF RR LAV DETAIL. NEW INSTALLED COUNTERTOP TO MATCH DEMOLISHED RESTORE EXISTING TERRAZZO FLOOR FINISH TO LIKE NEW

CONDITION. REFER TO TERRAZZO FLOORING RESTORATION SPECIFICATION FOR ADDITIONAL INFORMATION. EXISTING STEEL TUBING AND METAL FRAMING ABOVE EXISTING TOILET PARTITION TO REMAIN, PAINT TO MATCH NEW TOILET PARTITIONS, P-3, PROVIDE NEW TOILET PARTITION BELOW AT SAME LOCATION AND CONFIGURATION AS EXISTING, TPP-1.

14 INSTALL NEW HAND DRYER AT THIS LOCATION, SEE ELECTRICAL GENERAL NOTES FOR MORE DETAILS. mmmmmmm.

FINISH PLAN GENERAL NOTES

SEALANT SHALL BE APPLIED AT ALL MATERIAL TRANSITIONS, BACKSPLASHES, AND DOOR FRAMES. ALL LOCATIONS WHERE NEW FINISH ABUTS A DISSIMILAR MATERIAL. REMOVE AND REINSTALL EXISTING DEVICE FACEPLATES, SWITCH FACEPLATES, TECHNOLOGY FACEPLATES, AND CLOCKS.

EXISTING ITEMS TO REMAIN AND NEW FINISHES APPLIED AROUND INCLUDE BUT NOT LIMITED TO THERMOSTATS, AND FIRE EXTINGUISHER CABINETS PROVIDE NEW RESILIENT TRANSITION STRIPS AT

EXPOSED EDGE OF NEW FLOOR FINISH TO EXISTING FLOOR FINISH. PAINT ALL EXISTING INTERIOR DOOR FRAMES PER FINISH SCHEDULE ON SIDE(S) OF NEW WORK. PATCH AND REPAIR ALL HOLES AND IMPERFECTIONS, TO RECEIVE NEW FINISHES. ALL WALLS WITHIN SCOPE OF WORK WHERE TILE OCCURS, TO BE TRS-2 FROM TOP OF TRS-1 BASE TO

FULL HEIGHT OF TILE, UNLESS NOTED OTHERWISE.

LMS ENLARGED RESTROOM PLAN

SCALE: 1/4" = 1'-0"

SCALE: 1/4" = 1'-0"

SCALE: 1/4" = 1'-0"

ENLARGED DEMOLITION - C127 & C128

+/- 12'-2" VERIFY IN FIELD

BOYS RESTROOM

C128

F / B: TRS-1

W: TRS-2,3

ENLARGED FLOOR PLAN - C127 & C128


C: EXIST/ACT-1

7'-1"

5'-0" MINIMUM CLEAR

SCALE: 1/4" = 1'-0"

SCALE: 1/4" = 1'-0"

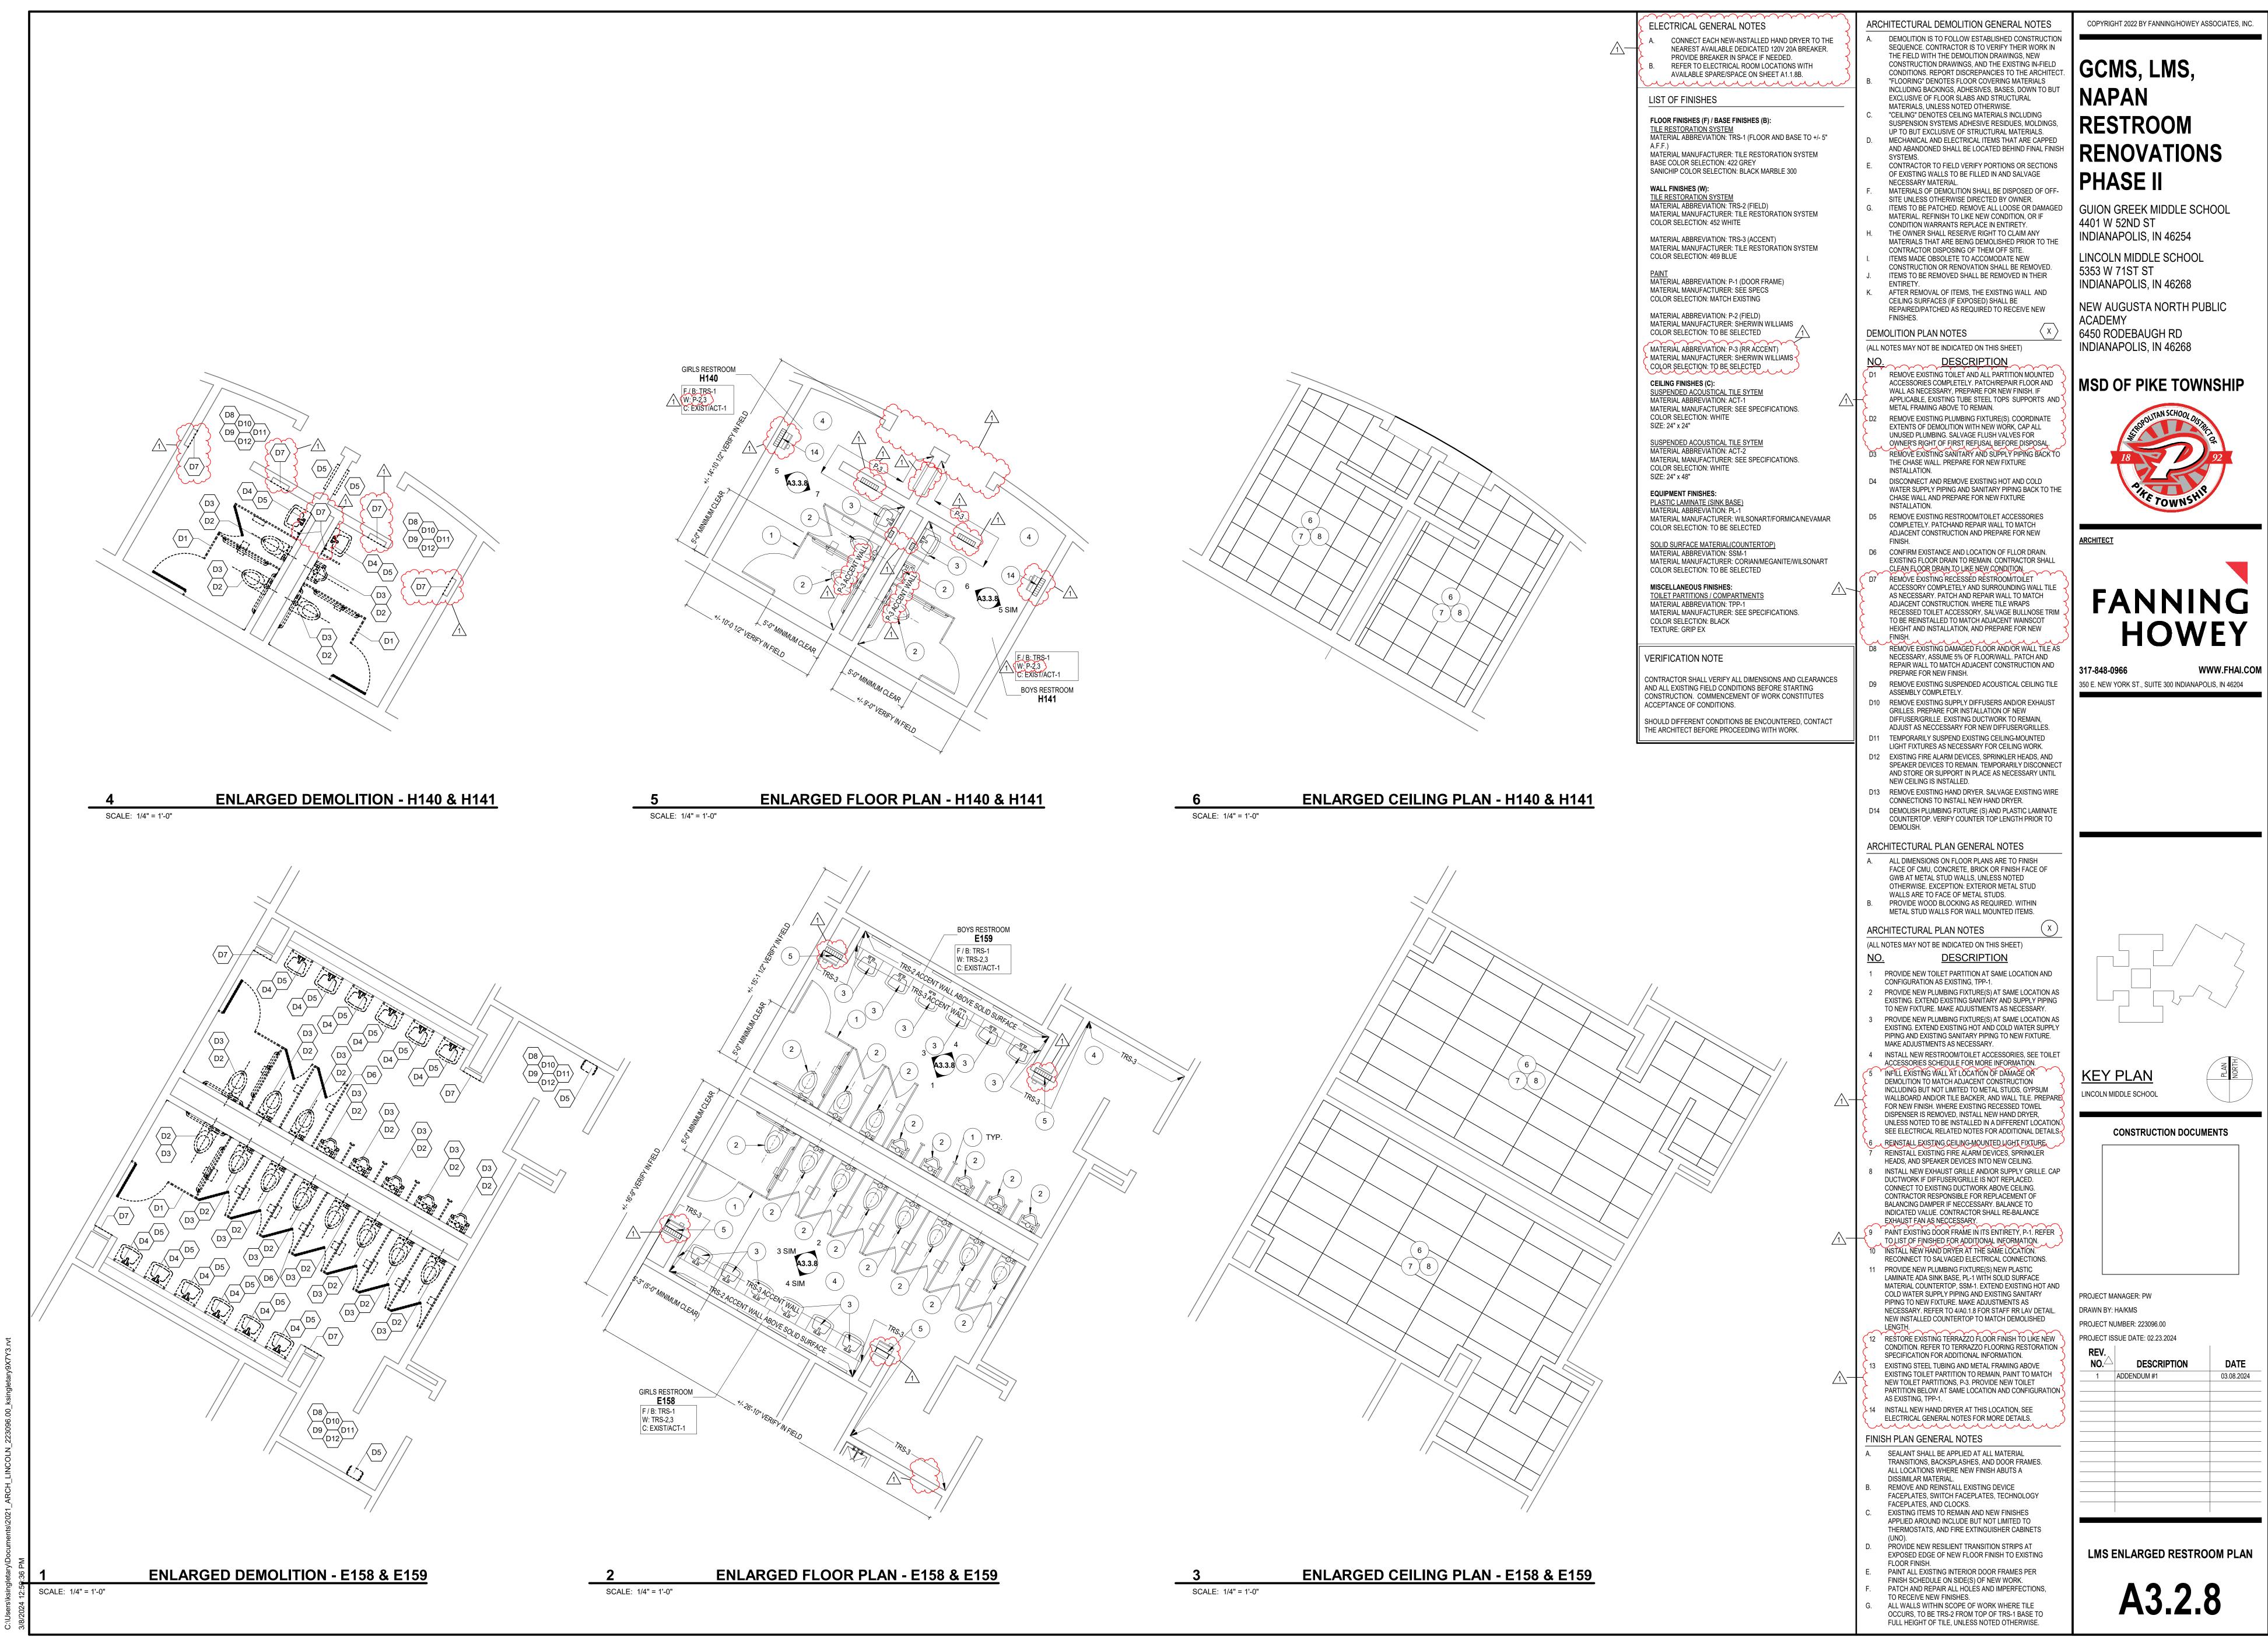



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